	SHEET LIST TABLE
Sheet Number	Sheet Title
S-100	SHEET LIST TABLE
S-200	GENERAL NOTES
S-300	GENERAL DETAILS-1-
S-301	GENERAL DETAILS-2-
S-400	FOUNDATIONS DETAILS .
S-500	MAT FOUNDATION GENERAL ARRANGEMENT PLAN
S-501	SLAB ON GRADE GENERAL ARRANGEMENT PLAN
S-502	FIRST FLOOR GENERAL ARRANGEMENT PLAN
S-503	SECOND FLOOR GENERAL ARRANGEMENT PLAN
S-504	THIRD FLOOR GENERAL ARRANGEMENT PLAN
S-505	FOURTH FLOOR GENERAL ARRANGEMENT PLAN
S-506	FIFTH FLOOR GENERAL ARRANGEMENT PLAN
S-507	ROOF GENERAL ARRANGEMENT PLAN
S-508	UPPER ROOF GENERAL ARRANGEMENT PLAN
S-600	TOP. REINFORCEMENT LAYOUT AT RAFT, Y DIRECTION
S-601	TOP. REINFORCEMENT LAYOUT AT RAFT, X DIRECTION
S-602	BOT. REINFORCEMENT LAYOUT AT RAFT, Y DIRECTION
S-603	BOT. REINFORCEMENT LAYOUT AT RAFT, X DIRECTION
S-604	ADD. REINFORCEMENT LAYOUT AT RAFT
S-605	TOP. REINF. LAYOUT AT 1ST FLOOR, Y DIRECTION
S-606	TOP. REINF. LAYOUT AT 1ST FLOOR, X DIRECTION
S-607	BOT. REINF. LAYOUT AT 1ST FLOOR, Y DIRECTION
S-608	BOT. REINF. LAYOUT AT 1ST FLOOR, X DIRECTION
S-609	ADD. REINFORCEMENT LAYOUT AT 1ST FLOOR
S-610	TOP. REINF. LAYOUT AT 2ND FLOOR, Y DIRECTION
S-611	TOP. REINF. LAYOUT AT 2ND FLOOR, X DIRECTION
S-612	BOT. REINF. LAYOUT AT 2ND FLOOR, Y DIRECTION
S-613	BOT. REINF. LAYOUT AT 2ND FLOOR, X DIRECTION
S-614	ADD. REINFORCEMENT LAYOUT AT 2ND FLOOR
S-615	TOP. REINF. LAYOUT AT 3RD FLOOR, Y DIRECTION
S-616	TOP. REINF. LAYOUT AT 3RD FLOOR, X DIRECTION
S-617	BOT. REINF. LAYOUT AT 3RD FLOOR, Y DIRECTION

	SHEET LIST TABLE
Sheet Number	Sheet Title
S-618	BOT. REINF. LAYOUT AT 3RD FLOOR, X DIRECTION
S-619	ADD. REINFORCEMENT LAYOUT AT 3RD FLOOR
S-620	TOP. REINF. LAYOUT AT 4TH FLOOR, Y DIRECTION
S-621	TOP. REINF. LAYOUT AT 4TH FLOOR, X DIRECTION
S-622	BOT. REINF. LAYOUT AT 4TH FLOOR, Y DIRECTION
S-623	BOT. REINF. LAYOUT AT 4TH FLOOR, X DIRECTION
S-624	ADD. REINFORCEMENT LAYOUT AT 4TH FLOOR
S-625	TOP. REINF. LAYOUT AT 5TH FLOOR, Y DIRECTION
S-626	TOP. REINF. LAYOUT AT 5TH FLOOR, X DIRECTION
S-627	BOT. REINF. LAYOUT AT 5TH FLOOR, Y DIRECTION
S-628	BOT. REINF. LAYOUT AT 5TH FLOOR, X DIRECTION
S-629	ADD. REINFORCEMENT LAYOUT AT 5TH FLOOR
S-630	TOP. REINF. LAYOUT AT ROOF, Y DIRECTION
S-631	TOP. REINF. LAYOUT AT ROOF, X DIRECTION
S-632	BOT. REINF. LAYOUT AT ROOF, Y DIRECTION
S-633	BOT. REINF. LAYOUT AT ROOF, X DIRECTION
S-634	ADD. REINFORCEMENT LAYOUT AT ROOF
S-635	TOP. REINF. LAYOUT AT UPPER ROOF, Y DIRECTION
S-636	TOP. REINF. LAYOUT AT UPPER ROOF, X DIRECTION
S-637	BOT. REINF. LAYOUT AT UPPER ROOF, Y DIRECTION
S-638	BOT. REINF. LAYOUT AT UPPER ROOF, X DIRECTION
S-800	COLUMNS AND WALLS DETAILS
S-900	STAIRCASE DETAIL

Note:
- all dimensions in (cm)
- all levels in meter (m)

PROJECT TITLE:

YORKVILLE HOTEL & **APARTMENTS LIMITED** CLIENT:

DELOMIS

DESIGNED DRAWN CHECKED SCALE 17 JAN. 2022

DRAWING TITLE: SHEET LIST TABLE CONSULTANT OFFICE Java Design Concepts LTD

SIZE: A1 DRAWING no:

<u>GENERAL</u> ALL DIMENSIONS ARE IN MILLIMETERS AND LEVELS IN METERS UNLESS OTHERWISE SPECIFIED.

- WORK TO FIGURED DIMENSIONS. DO NOT SCALE THE
- ALL STRUCTURAL DRAWINGS SHALL BE READ IN CONJUNCTION WITH RELEVANT ARCHITECTURAL, MEP, SERVICES AND LANDSCAPE DRAWINGS & SPECIFICATIONS. REFER TO ARCHITECTURAL, MECHANICAL AND ELECTRICAL

DRAWINGS FOR LOCATIONS OF PITS BASES, SUMPS,

SLOPES NOT SHOWN ON STRUCTURAL DRAWINGS. ANY DISCREPANCY NOTED SHALL BE BROUGHT TO THE NOTICE OF THE ENGINEER BEFORE COMMENCING THE WORK.

TRENCHES, DEPRESSIONS, GROOVES, CURBS, CHAMFERS AND

- THE CONTRACTOR IS FULLY RESPONSIBLE FOR DEVELOPING CONSTRUCTION METHOD AND MEANS.
- PRECAUTION SHOULD BE TAKEN TO PREVENT WATERPROOFING FROM DAMAGE DURING SUB-STRUCTURE CONCRETE WORKS ALL SPECIFIED LOADS ARE SERVICE (UNFACTORED) LOADS
- UNLESS OTHERWISE NOTED. LIVE (IMPOSED) LOADS FOR EACH PORTION OF THE STRUCTURE ARE SHOWN AND ARE NOT TO BE EXCEEDED DURING CONSTRUCTION. NO OPENINGS OR SLEEVES OTHER THAN THOSE SHOWN ON THE STRUCTURAL DRAWINGS SHALL BE MADE THROUGH SLABS,
- BEAMS OR BEARING WALLS UNLESS PRIOR APPROVAL IS OBTAINED FROM THE ENGINEER. THE CONTRACTOR SHALL PRODUCE SHOP DRAWINGS AND SCHEDULES AS NECESSARY FOR COMPLETION OF THE WORKS
- AND RECORD DRAWINGS OF THE AS BUILT WORKS, ALL FOR THE ENGINEER'S APPROVAL.
- <u>DESIGN CRITERIA</u>
- STANDARDS AND LOADS
- THE CONCRETE DESIGN IS BASED ON ACI-318-05 AND ALL OTHER RELEVANT ACI CODES.
- LIVE LOADS ARE BASED ON UNIFORM BUILDING CODE UBC (1997) OR EMPLOYER REQUIREMENTS AND ARE AS FOLLOWS: LOADING AREA ..1500 KG/M2 COMMERCIAL AREA 500 KG/M2 TECHNICAL AREA 500 KG/M2
- 2.1.3 SUPERIMPOSED DEAD LOADS ADOPTED WHERE NOT ACCURATELY COMPUTED:

250 KG/M2

..... 500 KG/M2

- PARTITION (light weight) 100 KG/M2 .. 250 KG/M2 FALSE CEILING, E/M INSTALLATIONS 100 KG/M2
- 2.1.4 <u>WIND LOADS (ASCE 7-07)</u>

OFFICE AREA

STAIRS

SPEED 160 Km/Hr EXPOSURE

- MODERATE SULPHATE RESISTING CEMENT ASTM TYPE II, SHALL BE USED FOR ALL CONCRETE WORK IN THE SUBSTRUCTURE INCLUDING GROUND SLAB ACCORDING TO THE
- MAXIMUM SIZE OF AGGREGATE SHALL BE 20mm
- ORDINARY PORTLAND CEMENT AND IN SPECIFIED QUANTITIES SHALL BE USED FOR ALL SUPERSTRUCTURE
- LIGHT WEIGHT CONCRETE SHALL HAVE A MAXIMUM DENSITY OF 600 KG/M3 UNLESS OTHERWISE NOTED.
- UNLESS OTHERWISE NOTED, THE MINIMUM CHARACTERISTIC 28 DAYS CYLINDER
- CRUSHING STRENGTH OF CONCRETE SHALL BE AS FOLLOWS:
 - a) BLINDING, CONCRETE FOR CAVITY FILLING PURPOSES, CONCRETE ENCASEMENT OR BEDDING OF PIPES 14 MPa c) COLUMNS & SHEAR, RETAINING WALLS 30 MPa
- d) BEAMS, & ORDINARY SLABS e) POST TENSIONED SLABS f) RAFT FOUNDATION .. 25 MPa g) ALL OTHER CONCRETE
- ALL CONCRETE MUST BE DEPOSITED, VIBRATED AND CURED IN ACCORDANCE WITH ACI STANDARD
- USE WATERPROOFING ADMIXTURES IN THE MIX DESIGN OF THE FOUNDATIONS CONCRETE.
- CONCRETE MIXES SHALL COMPLY WITH ACI 201.2 FOR DURABILITY REQUIREMENTS.
- <u>FORMWORK</u>
- FORMS SHALL RESULT IN A FINAL STRUCTURE THAT CONFORMS TO SHAPES, LINES, AND DIMENSIONS OF THE MEMBERS AS REQUIRED BY THE DESIGN DRAWINGS AND
- FORMS SHALL BE SUBSTANTIAL AND SUFFICIENTLY TIGHT TO PREVENT LEAKAGE OF MORTAR
- FORMS SHALL BE PROPERLY BRACED OR TIED TOGETHER TO MAINTAIN POSITION AND SHAPE
- FORMS AND THEIR SUPPORTS SHALL BE DESIGNED SO AS NOT TO DAMAGE PREVIOUSLY PLACED STRUCTURE
- 4.5 FORMWORK SHALL COMPLY WITH THE REQUIREMENTS OF "GUIDE TO FORMWORK OF CONCRETE" ACI 347. *

- NO CONSTRUCTION LOADS SHALL BE SUPPORTED ON , NOR ANY SHORING REMOVED FROM ANY PART OF THE STRUCTURE UNDER CONSTRUCTION EXCEPT WHEN THAT PORTION OF THE STRUCTURE IN COMBINATION WITH THE REMAINING FORMING AND SHORING SYSTEM HAS SUFFICIENT STRENGTH TO SUPPORT SAFELY ITS WEIGHT AND LOADS PLACED THEREON
- EXCEPT STATED OTHERWISE AND DEPENDING ON THE CURING METHOD AND THE NATURE OF THE ELEMENT, FORMWORK SHALL BE REMOVED:

14 DAYS

- 1-FOUNDATIONS 1 DAY 2-COLUMNS & WALLS 2 DAYS 3-BEAMS & GIRDERS 21 DAYS
- <u>REINFORCING STEEL</u>
- ALL REINFORCING STEEL SHALL CONFORM TO ASTM 615M HAVING A MINIMUM YIELD STRENGTH OF 420MPa
 - ALL MILD STEEL REINFORCEMENT SHALL CONFORM TO ASTM A 615 (Fy=240 MPa)
- ALL WELDED WIRE FABRIC SHALL CONFORM TO ASTM A497 HAVING A MINIMUM YIELD STRENGTH OF 420 MPa.
- ALL BAR SIZES ARE IN MILLIMETERS.
- BARS INDICATED BY DOTTED LINE SHALL BE AT TOP OF

4-SLABS

- REINFORCEMENT DETAILS SHOWN ARE INDICATIVE FOR THE PREPARATION OF THE CONTRACTOR'S WORKING DRAWINGS.
- ALL REINFORCING STEEL SHALL BE SECURELY WIRED IN PLACE BEFORE CONCRETE IS PLACED ACCORDING TO "CRSI" REQUIREMENTS.
- STEEL SHALL BE CLEAN AND FREE FROM MILL SCALE, RUST, PAINT, GREASE AND ANY HARMFUL SUBSTANCES.
 - DEVELOPMENT & SPLICE LENGTHS IN TENSION FOR REINFORCING BARS IN SLAB & COLUMNS AND WALLS SHALL BE AS PER ACI-318 , REFER TO TABLES BELOW:


TABLE-	1								
		DEVELO	PMENT LEI	NGTH RATIO	(ld/db)	IN TENSION	I		
	fcu	26Mp	a	35Mpa	451	Ира	55Mpa		
BAR DIA		OTHER BAR	TOP BAR	OTHER BAR	TOP BAR	OTHER BAR	TOP BAR	OTHER BAR	TOP BAR
	CA ⁻	EGORY							
10mm TO	ı	44	57	38	49	34	44	31	40
18mm	II	66	86	57	74	51	66	46	60
20mm TO	ı	55	72	47	61	42	55	39	51
32mm	II	82	107	71	92	64	83	58	75

TABLE-2									
SPLICE LENGTH RATIO (SPLICE/db) IN TENSION									
	fcu	26Mp	a	35Mpa	451	Ира	55Mpa		
BAR DIA	CV	OTHER BAR TEGORY	TOP BAR	OTHER BAR	TOP BAR	OTHER BAR	TOP BAR	OTHER BAR	TOP BAR
10mm T0	1	57	74	49	64	44	57	40	52
18mm	II	86	112	74	96	66	86	60	78
20 TO		72	93	61	79	55	72	51	66

| | 107 | 139 | 92 | 120 | 83 | 108 | 75 | 98

NOTES: 1. SEE CATEGORY CHART FOR CATEGORY | & II.

2. Id IS THE DEVELOPMENT LENGTH db IS THE DIAMETER OF BAR. SPLICE IS THE SPLICE LENGTH.

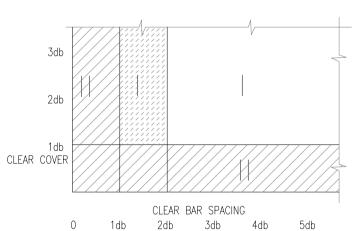

CATEGORY CHART

CATEGORY I (CLEAR SPACING ≥db

CLEAR COVER ≥db CODE MINIMUM STIRRUPS OR TIES THROUGHOUT ID

∫ CLEAR SPACING ≥2db CLEAR COVER ≥db ALL OTHER CASES. CATEGORY II


* TOP BARS ARE THOSE WHICH HAVE 300MM OR MORE OF CONCRETE UNDER THEM. REST ARE OTHER BARS.

MINIMUM SPLICE FOR WELDED FABRIC SHALL BE 200MM.

- WHEN BARS ARE BUNDLED, INCREASE THE LAP BY 20% FOR 3 BAR BUNDLE, 33% FOR 4 BAR BUNDLE.
- MINIMUM DEVELOPMENT SHALL BE 300MM.

- DEVELOPMENT LENGTH RATIO (Id/db) IN COMPRESSION BAR DIA 8mm → 32mm 17
- DEVELOPMENT LENGTH IN COMPRESSION SHALL BE > 200mm


23

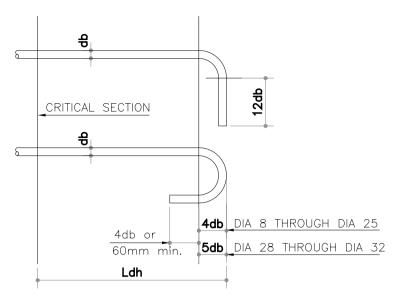

MINIMUM TENSION EMBEDMENT LENGTH Ldh, FOR STANDARD END HOOKS

TABLE-3					
STANDAR	D H00	K LENGTH	RATIO (Id	h/db) IN	TENSION
BAR DIA	fcu	26Mpa	35Мра	45Mpa	55Мра
8mm TO 3	32mm	22	19	17	16

- 5.8 <u>TEMPERATURE REINFORCEMENT FOR CONCRETE SLABS</u>
 - a) UNLESS OTHERWISE NOTED PROVIDE TEMPERATURE REINFORCEMENT IN CONCRETE SLABS, COVER SLABS & TOPPINGS AS SHOWN IN
 - b) UNLESS OTHERWISE NOTED, PLACE TEMPERATURE REINFORCEMENT PERPENDICULAR TO MAIN REINFORCEMENT IN ONE WAY SLABS. WHERE MAIN REINFORCEMENT CONSISTS OF TOP AND BOTTOM BARS, PLACE TEMPERATURE REINFORCEMENT ALTERNATIVELY AT TOP AND
 - c) UNLESS OTHERWISE NOTED, PROVIDE WELDED WIRE FABRIC IN FLAT
 - d) UNLESS OTHERWISE NOTED, PLACE WELDED WIRE FABRIC WITH 25 MM TOP COVER. LAP RE-BARS WITH TENSION LAP SPLICE. LAP ENDS OF WELDED WIRE FABRIC SUCH THAT THE OVERLAP MEASURED BETWEEN OUTERMOST CROSS WIRES OF EACH FABRIC SHEET SHALL NOT BE LESS THAN ONE SPACING OF CROSS WIRE PLUS 50 MM.
 - e) UNLESS OTHERWISE NOTED, PROVIDE MINIMUM REINFORCEMENT IN SLABS As = 0.0020 Ag
- 5.9 FOR ALL SILLS AND LINTELS BETWEEN COLLIMNS AND NOT SUPPORTED BY A WALL, PROVIDE DOWELS IN THE COLUMN OF SAME SIZE AND NUMBER AS THE REINFORCEMENT OF THE LINTEL OR SILL. THESE DOWELS SHALL EXTEND 50 BAR DIA. FROM THE FACE OF THE COLUMN AND SHALL BE EMBEDDED 50 BAR DIA. IN THE COLUMN

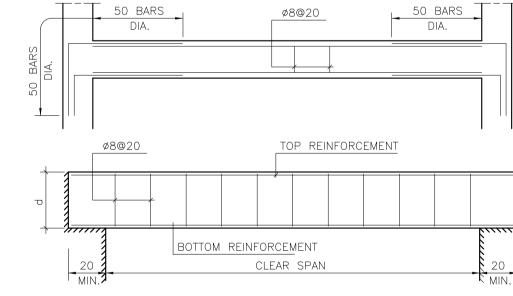

SCHEDULE OF LINTELS REINFORCEMENT (MASONRY WALLS)									
LINTEL WIDTH	b=1	0cm.	b=1	5cm.	b=20cm.	TO 25cm.	b=25cm	TO 30cm.	DEPTH=
CLEAR SPAN	TOP REINF.	BOTTOM REINF.	TOP REINF.	BOTTOM REINF.	TOP REINF.	BOTTOM REINF.	TOP REINF.	BOTTOM REINF.	d
< 200	1T10	1T14	2T10	2T12	2T10	2T12	3T10	3T12	20
200-300	1T10	1T16	2T10	2T14	2T10	2T16	3T10	3T16	25
301-400	1T10	1T20	2T10	2T16	2T10	2T20	3T10	3T20	30
401-500	1T10	1T20	2T10	2T16	2T10	2T20	3T10	3T20	40
501-600	1T10	1T20	2T10	2T16	2T10	2T20	3T10	3T20	50
601-700	1T10	1T20	2T10	2T16	2T10	2T20	3T10	3T20	50

5.0 CONCRETE COVER TO REINFORCEMENT

CONCRETE CAST AGAINST AND PERMANENTLY EXPOSED TO EARTH. 7.5 cm 5.2 CONCRETE EXPOSED TO WEATHER 5.0 cm UNEXPOSED CONCRETE FOR BEAMS & COLUMNS 4.0 cm

3.0 cm

6.0 <u>SOIL DATA AND WATER TABLE</u>

5.4 UNEXPOSED CONCRETE FOR SLABS, WALLS

- AT THE DATE OF ELABORATION OF THIS REPORT NO SOIL INVESTIGATION REPORT WAS AVAILABLE.
- 6.2 IN CASE, IN ANY LOCATION AT THE FOUNDATION LEVEL, VERY WEAK SHELLY OR FRACTURED LOCAL AREAS ARE ENCOUNTERED, THEY SHOULD BE TOTALLY EXCAVATED, REMOVED AND REPLACED WITH PLAIN CONCRETE.
- FOUNDATION ON BACKFILL IS NOT ALLOWED. BACKFILL AND FILL NEXT TO FOOTINGS, FOUNDATIONS, UNDER SUBFLOORS ETC. SHALL BE AS APPROVED BY THE ENGINEER AND SHALL BE LAID IN LAYERS NOT EXCEEDING 20 cm THICK AND COMPACTED BY MECHANICAL TAMPERS OR AS SPECIFIED BY THE ENGINEER.
- 7.0 <u>CONSTRUCTION JOINTS (IF SHOWN ON DRAWINGS)</u>
- FOR THE PURPOSE OF REDUCING SHRINKAGE AND TEMPERATURE STRESSES AND CRACKS, THE FOLLOWING THREE TYPES OF JOINTS ARE RECOMMENDED:
- a- SHRINKAGE STRIPS 90 cm WIDE ACROSS THE ENTIRE RAFT & SLABS AND CAST THREE TO FOUR MONTHS LATER
- b- CONTROL JOINTS: INDUCE CRACKING AT PRESELECTED LOCATIONS IN WALLS AND SLABS c- CONSTRUCTION JOINTS: AS PER POURING REQUIREMENTS DURING CONSTRUCTION LOCATIONS AND RELEVANT DETAILS SHALL BE SUBMITTED FOR APPROVAL BY THE CONTRACTOR
- 7.2 IN NO CASE SHALL HORIZONTAL CONSTRUCTION JOINTS IN CONCRETE WALLS BE LOCATED ANYWHERE OTHER THAN AT SUPPORTS UNLESS SHOWN ON DRAWINGS.
- HORIZONTAL CONSTRUCTION JOINTS SHALL NOT BE MADE IN BEAMS, UNLESS SHOWN OR REVIEWED BY THE ENGINEER.
- VERTICAL CONSTRUCTION JOINTS MAY BE MADE ONLY WITHIN MIDDLE THIRD SPAN OF BEAMS OR SLABS UNLESS OTHERWISE SHOWN OR DIRECTED AND THEIR LOCATION SHALL BE REVIEWED BY THE ENGINEER.
- ALL THE PARAPET AND BASEMENT RETAINING WALLS SHALL HAVE CONTROL JOINT NOT EXCEEDING 6.0m UNLESS OTHERWISE SPECIFIED

8.0 <u>MASONRY CONSTRUCTION</u>

- MASONRY CONSTRUCTION SHALL CONFORM TO ACI 530, CURRENT EDITION. MORTAR FOR MASONRY WALLS TO BE TYPE "S".
- 8.2 ALL CONCRETE BLOCKS SUPPLIED TO SITE SHALL COMPLY WITH ASTM C90.
- MASONRY CONTRACTOR IS RESPONSIBLE FOR PROVIDING NECESSARY SHORING AND BRACING TO MAINTAIN WALL IN SHAPE, LINE AND DIMENSION IN CONFORMANCE WITH DRAWINGS, AGAINST WIND AND CONSTRUCTION LOADS.
- 8.4 WHERE NO CONTROL JOINTS ARE SHOWN, SUBMIT PROPOSED LOCATIONS PER ACI 530 FOR APPROVAL BY ARCHITECT AND/OR ENGINEER.
- PROVIDE BOND BEAM 400MM DEEP W/ 4T10 CONTINUOUS & STIRRUPS Ø8 @ 25 CM FOR WALLS HIGHER THAN 3.0M.
- 8.6 BLOCKS TO HAVE MINIMUM CRUSHING STRENGTH OF 7.5 MPa AND MAXIMUM UNIT WEIGHT OF 1400 KG/m2.
- 8.7 ALL JOINTS BETWEEN COLUMN AND BLOCK WORK TO BE PROVIDED WITH G.I. ANCHORS AT 400MM C/C (EVERY ALTERNATIVE LAYER)
- 8.8 MORTAR 1:1:6 CEMENT/LIM/SAND. MAXIMUM CUBE STRENGTH 5 MPa.
- ALL CONCRETE AND BLOCK JOINTS TO HAVE 300mm WIDE EXPANDED METAL SECURED ON BOTH
- 8.10 CONCRETE FILLED HOLLOW BLOCKS TO HAVE CONCRETE OF MINIMUM STRENGTH OF 21 MPa
- MAXIMUM SIZE OF AGGREGATES TO BE 10mm HEIGHT OF POURS SHOULD NOT EXCEED 1200mm. 8.11 GALVANISED FLAT BARS, WALL TIES AND HORIZONTAL WALL REINFORCEMENT TO BE BEDDED CENTRALLY IN MORTAR COURSES.
- 8.12 THE CONTRACTOR SHALL BE FULLY RESPONSIBLE OF THE DETAILING AND PROVISION OF ALL STIFFENERS, MOVEMENT JOINTS ETC. FOR THE MASONRY WALLS IN ACCORDANCE WITH STANDARDS AND TO THE ENGINEERS APPROVAL. AS A GENERAL GUIDE STIFFENERS SHALL BE PROVIDED FOR

9.0 <u>WATERPROOFING</u>

- RAFT FOUNDATION AND BASEMENT WALLS SHALL BE WATERPROOFED WITH A SPECIFIED WATERPROOFING SYSTEM AS DETAILED AND SPECIFIED BY THE NOMINATED SUPPLIER/SUBCONTRACTOR.
- WATERSTOPS OF APPROVED MANUFACTURER AND SIZE SHALL BE INSTALLED AS DETAILED AND SPECIFIED BY THE NOMINATED SUPPLIER/SUBCONTRACTOR.

STEEL MATERIALS SPECIFICATIONS

- 1-HOT ROLLED SECTIONS ARE USED FY=24.5 KN/cm2. 2-WELDING HAS BEEN APPLIED IN ACCIRDANCE WITH AWS D1.1.96 AMERCAN WELDING SOCIETY STRUCTURAL WELDING CODE-STEEL MANUAL.
- 3-WELD ELECTROD ARE USED E70.
- 4-MINIMUM SIZE OF WELD S=6MM. 5-BOLTS ARE USED GRADE A325=8.8 OTHERWISE NOTED. (High Strength Bolts ASTM A325M type 1 Hot Dip Galvanized
- ft=303 KN/mm2 fu=72-83 KN/mm2.6- THE STEEL GRADE OF PIPES AND PURLINS ST 37 (DIN 17100)
- 7- CORROSION PROTECTION (PIPES) :
- 8- HOT DIP GALVANIZING 80 MICRON (DIN 50976) 9- ELECTROSTATIC POWDER COAT PAINTING 80 MICRON (DIN 55928)
- 10- ALL DIMENSIONS ARE IN (mm)
- 11- THE DIMENSIONS AND LEVELS GIVEN ON THE DRAWINGS SHALL BE CHECKED BY THE CLIENT/CONSULTANT/CONTRACTOR TO SEE WHETHER THESE ARE THE SAME AS THE "SITE AS-BUILT"

MEASUREMENTS. THE DIMENSIONS WHICH ARE NOT CORRECTED DURING

APPROVAL WILL BE CONSIDERED AS DEFINITE DIMENSIONS AND LEVELS BASIC FOR FABRICATION.

SYMBOLS & ABBREVIATIONS

1	BAR DIAMETER	d _b /D
2	FOOTING	F
3	COLUMN	С
4	TYPICAL	TYP
5	MINIMUM	MIN
6	MAXIMUM	MAX
7	BEAM	В
8	RIB	R
9	@	AT
10	DEFORMED BAR DIAMETER IN mm	Τ
11	PLAIN STEEL BAR	Ø
12	NOT TO SCALE	NTS
13	THICKNESS	TH
14	SOLID SLAB	SS
15	DRAWING	DWG
16	REINFORCEMENT	REINF
17	STIRRUP	STIR

NGL

CONT

STD

OPNG

18 NATURAL GROUND /GRADE LEVEL 19 CONTINUOUS 20 STANDARD 21 OPENING

22 CONCRETE LEVEL 23 TOP STEEL IN SOLID SLAB 24 BOTTOM STEEL IN SOLID SLAB

25 LEVEL 26 WALL FOOTING 27 TIE-BEAM 28 COUNTERFORT 29 TANK WALL 30 EXCAVATION LEVEL 31 BOTTOM REINFT

32 TOP REINFT 33 2nd LAYER OF EXTRA BOTTPM REINFT 34 2nd LAYER OF EXTRA TOP REINFT 35 3rd LAYER OF EXTRA BOTTOM REINFT

<u>LEGEND</u>

36 3rd LAYER OF EXTRA TOP REINFT

R.C. Column or Wall R.C. Column or Wall stopped at below level

implanted R.C. Column or Wall

Note:

- all dimensions in (cm)
- all levels in meter (m)

PROJECT TITLE:

YORKVILLE HOTEL & APARTMENTS LIMITED

CLIENT:

DELOMIS

	DESIGNED	
	DRAWN	
	CHECKED	
	SCALE	
	DATE	17 JAN. 2022

DRAWING TITLE: **GENERAL NOTES** CONSULTANT OFFICE Java Design Concepts LTD

SIZE: A1

DRAWING no:

PAD AND CURB — TYPICAL DETAILS

PLAN DIMENSIONS TO SUIT EQUIPMENT

FOR LOCATION AND SIZE SEE

T10@200 CONTINUOUS——

T12 CONTINUOUS

ELECTRICAL DRAWINGS

FOR LOCATION AND SIZE SEE ARCHITECTURAL, MECHANICAL AND/OR

<u>CURBS</u>

TYPICAL SUMP PIT DETAIL

CONTRACTOR SHALL CO-ORDINATE L's COVER INSTALLATION DETAIL

WITH MANUFACTURERS REQUIRMENT

T10 @ 200

ELECTRICAL DRAWINGS

T10 @ 200 EACH WAY

ARCHITECTURAL, MECHANICAL AND/OR ADDITIONAL T12

EQUIPMENT

(TYPICAL)

--- STANDARI

UNLESS OTHERWISE SPECIFIED

STANDARD HOOK

EACH END

T12 @ 200 — CONTINUOUS

Z 98: 0

STANDARD

FOR L's COVER, ETC
SEE ARCHITECTURAL AND
MECHANICAL DRAWINGS

GENERAL DETAILS-1-

DETAILS FOR OPENINGS AND SLEEVES IN SLAB

- 1. UNLESS OTHERWISE NOTED ON STRUCTURAL DRAWINGS:
- A) REINFORCEMENT AROUND OPENINGS AND SLEEVES SHALL BE AS PER DETAILED BELOW
- B) DO NOT MAKE OPENINGS OR SLEEVES LARGER THAN THE MAXIMUM DIMENSIONS NOTED BELOW AND DO NOT LOCATE OPENINGS OR SLEEVES OTHER THAN WHERE INDICATED ON PLAN WITHOUT PRIOR APPROVAL
- 2. OPENINGS, SLEEVE SIZES AND LOCATIONS TO BE RESTRICTED TO THE FOLLOWING :
- A) ONE WAY AND TWO WAY SLABS:
- (1) MAXIMUM OPENING SIZE 75 CM. SQUARE. (2) MAXIMUM SLEEVE SIZE 25 CM. Ø 4 IN A GROUP.
- (3) NO RESTRICTION ON LOCATION.

B) FLAT SLABS :

(1) DO NOT MAKE OPENINGS OR PLACE SLEEVES WITH IN TWICE THE SLAB DEPTH FROM THE FACE OF A COLUMN OR EDGE OF A CAPITAL. (2) MAXIMUM WIDTH OF STRIP INTERRUPTED BY OPENINGS OR SLEEVES. -IN AREAS COLUMN TO 2 COLUMN STRIPS NOT GREATER THAN 1/8 OF COLUMN STRIP WITH IN EITHER SPAN.

NOTE :-


- -IN AREAS COLUMN TO 1 COLUMN STRIP AND 1 MIDDLE STRIP NOT GREATER THAN 1/4 OF STRIP WIDTH IN EITHER DIRECTION. -IN AREAS COLUMN TO 2 MIDDLE STRIPS, NOT GREATER THAN 1/2 OF
- △ Aa (TOP&BOT) Aa (TOP&BOT)

PROVIDE HOOK AT END OF TRANSVERSE

b/2 + LAP


ADD. REINF TO BE PROVIDED AT TOP & BOTTOM LAYERS.					
а	Aa (TOP & BOT.)	b	Ab (TOP & BOT.)		
a ≤ 400	2T16	b ≤ 400	2T16		
400< a <1000	3T16	400< b <1000	3T16		
1000< a <1500	5T16	1000< b <1500	5T16		
a ≥ 1500	7T16	b ≥ 1500	7T16		

*MAY PROVIDE EQUIVALENT AREA OF CUT STEEL ON BOTH SIDES PER ACI REQUIREMENTS CALCULATIONS SHALL BE SUBMITTED FOR APPROVAL

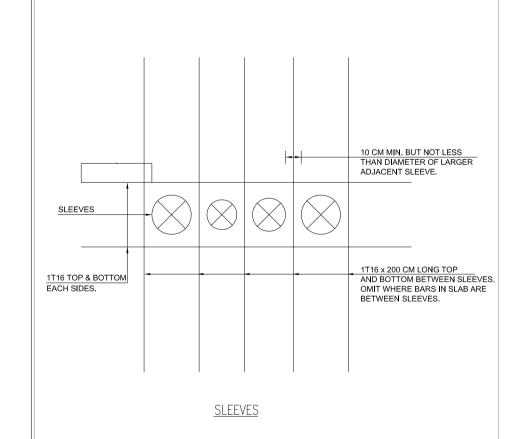

REINFORCING AT STEPPED STRUCTURAL SLAB

SEE NOTE 4 — SEE NOTE 2

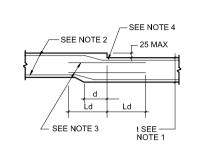

CONSTRUCTION JOINT - TYPICAL DETAIL

LONG at 600 IN SLABS

CONTINUOUS BARS

IN ADDITION TO SLAB

1ST POUR

- SPRAY SURFACE WITH CURING COMPOUND

OR FORM OIL AFTER REMOVAL OF FORMS

SLABS OVER 150 DEEP

BEAMS OVER 450 DEEP SAME AS BEAMS UP TO 450 DEEP

BUT USE MULTIPLE KEYS AS SHOWN

NOTED ON PLAN 2ND POUR


SLABS UP TO 150 IN DEPTH


OF STIRRUP OR AS SHOWN IN

STIRRUP EACH SIDE OF JOINT FOR EACH

0.05m²OF BEAM AREA OR PORTION THEREOF


BEAMS UP TO 450 IN DEPTH

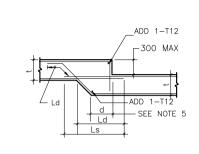

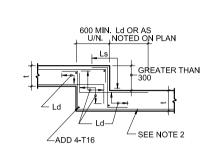


- 1. SLAB THICKNESS t TO BE GREATER OR EQUAL TO THE THICKNESS REQUIRED FOR FIRE RESISTANCE RATING.
- 2. SLAB MAIN REINFORCEMENT (REFER TO DWGS.) WHERE SLAB SOFFIT VARIES DROP REINFORCING STEEL AS REQUIRED.
- 3. ADDITIONAL REINFORCING TOI BE ADDED AT CHANGE IN THICKNESS, PROVIDE T12 @ 200 4. MAINTAIN REQUIRED CONCRETE COVER TO REINFORCING STEEL.
- 5. THE DISTANCE d=t EXCEPT THAT d SHALL NOT BE LESS THAN 300 6. Ld — TENSION EMBEDMENT LENGTH, BUT GREATER THAN 600
- 7. Ls TENSION LAP SPLICE LENGTH


ONE-WAY SLAB REINFORCEMENT - TYPICAL DETAIL SUPPORTED ON CONCRETE BEAMS OR WALLS

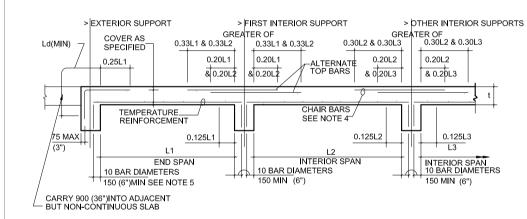

- 1. UNLESS OTHERWISE SHOWN OR NOTED ON PLAN, PLACE REINFORCING IN ONE-WAY SLABS
- AS SHOWN IN THIS DETAIL. 2. MAXIMUM BAR SPACING IS 3t BUT NOT GREATER THAN 500, WHERE t IS THE SLAB THICKNESS.
- 3. PROVIDE 2-T16 x 1800 LONG TOP BARS ACROSS RE-ENTRANT CORNERS UNLESS
- 4. PROVIDE BAR SUPPORTS AND ACCESSORIES TO THE REQUIREMENTS OF CODE.
- 6. WHERE MINIMUM EMBEDMENT IS NOT POSSIBLE PROVIDE A STANDARD 90° HOOK LAID FLAT.

TYPICAL PARAPET DETAIL

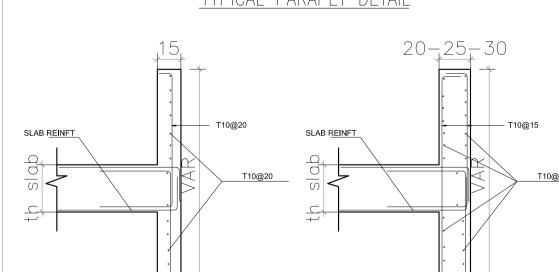

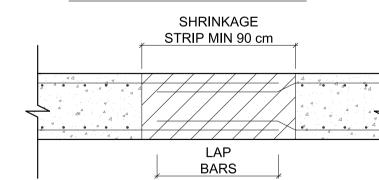

PROJECT TITLE:

Note: - all dimensions in (cm)

- all levels in meter (m)

YORKVILLE HOTEL & APARTMENTS LIMITED

WALL REINFORCING DETAILS

FOR OPENINGS UNDER 45x45 CM. RESPACE MAIN REINFORCING AND ADD 1T16 x 120 CM LONG DIAGONAL

OPENINGS IN WALLS

AT EACH CORNER FOR EVERY 20 CM. OF WALL THICKNESS OR PORTION THEREOF.

REINFORCEMENT ARRANGEMENT FLAT SLABS W/O DROP PANELS

SCHEMATIC PLAN

TOP MAIN BARS

0.30 Lc1

MAX 0.125 L1

0.30 Lc2

TOP ADDITIONAL BARS

MAX 0.125 L2

LAP SPLICE

L<u>AP SPLIÇ</u>E

TOP ADDITIONAL BARS

BOTTOM ADDITIONAL BARS BOTTOM MAIN BARS

AND Lc4 IN THE SPAN DIRECTION.

FROM FACE OF CAPITALS.

OTHERWISE ON PLAN.

OR L2 AND L3 RESPECTIVELY.

OR COLUMN CAPITAL WIDTH.

1. REFER TO PLAN FOR PLACING ORDER OF BARS

2. Lc IS LONGER OF ADJACENT CLEAR SPANS Lc1 AND Lc2 OR Lc3

4. Ls IS SHORTER OF SPANS IN BAY BEING CONSIDERED L1 AND L3

6. PROVIDE 5016 MINIMUM BOTTOM SPLICE BARS OVER EACH COLUMN

7. PROVIDE 5016 MINIMUM BOTTOM SPLICE BARS OVER EACH COLUMN OR COLUMN CAPITAL WIDTH UNLESS NOTED OTHERWISE ON PLAN. LAP SPLICE BARS A MINIMUM 2Ld WITH THE MAIN SLAB STEEL. PROVIDE A STANDARD HOOK AT DISCONTINUOUS EDGES.

8. REFER TO PLAN FOR SIZE OF TOP AND BOTTOM BARS.

3. FOR COLUMNS WITH CAPITALS, CLEAR SPAN TO BE MEASURED

5. BAR LENGTHS AND DIMENSIONS ARE MINIMUM UNLESS NOTED

ADD REINFORCEMENT ON EACH SIDE OF OPENING EQUIVALENT TO 1/2 OF

INTERRUPTED BY THE OPENING BUT

ADD 1T16 x 150 CM LONG FOR WALLS 20 CM AND UNDER, AND 1T46 x 150 CM

LONG EACH FACE FOR WALLS OVER 20 CM.

THE AREA OF REINFORCEMENT

CLIENT:

DELOMIS

DESIGNED		
DRAWN		
CHECKED		
SCALE		
DATE	17 JAN. 2022	

DRAWING TITLE:

CONSULTANT OFFICE Java Design Concepts GENERAL DETAILS -1-LTD




S-300

DRAWING no:

SHRINKAGE STRIP IN SLABS

GENERAL DETAILS-2-

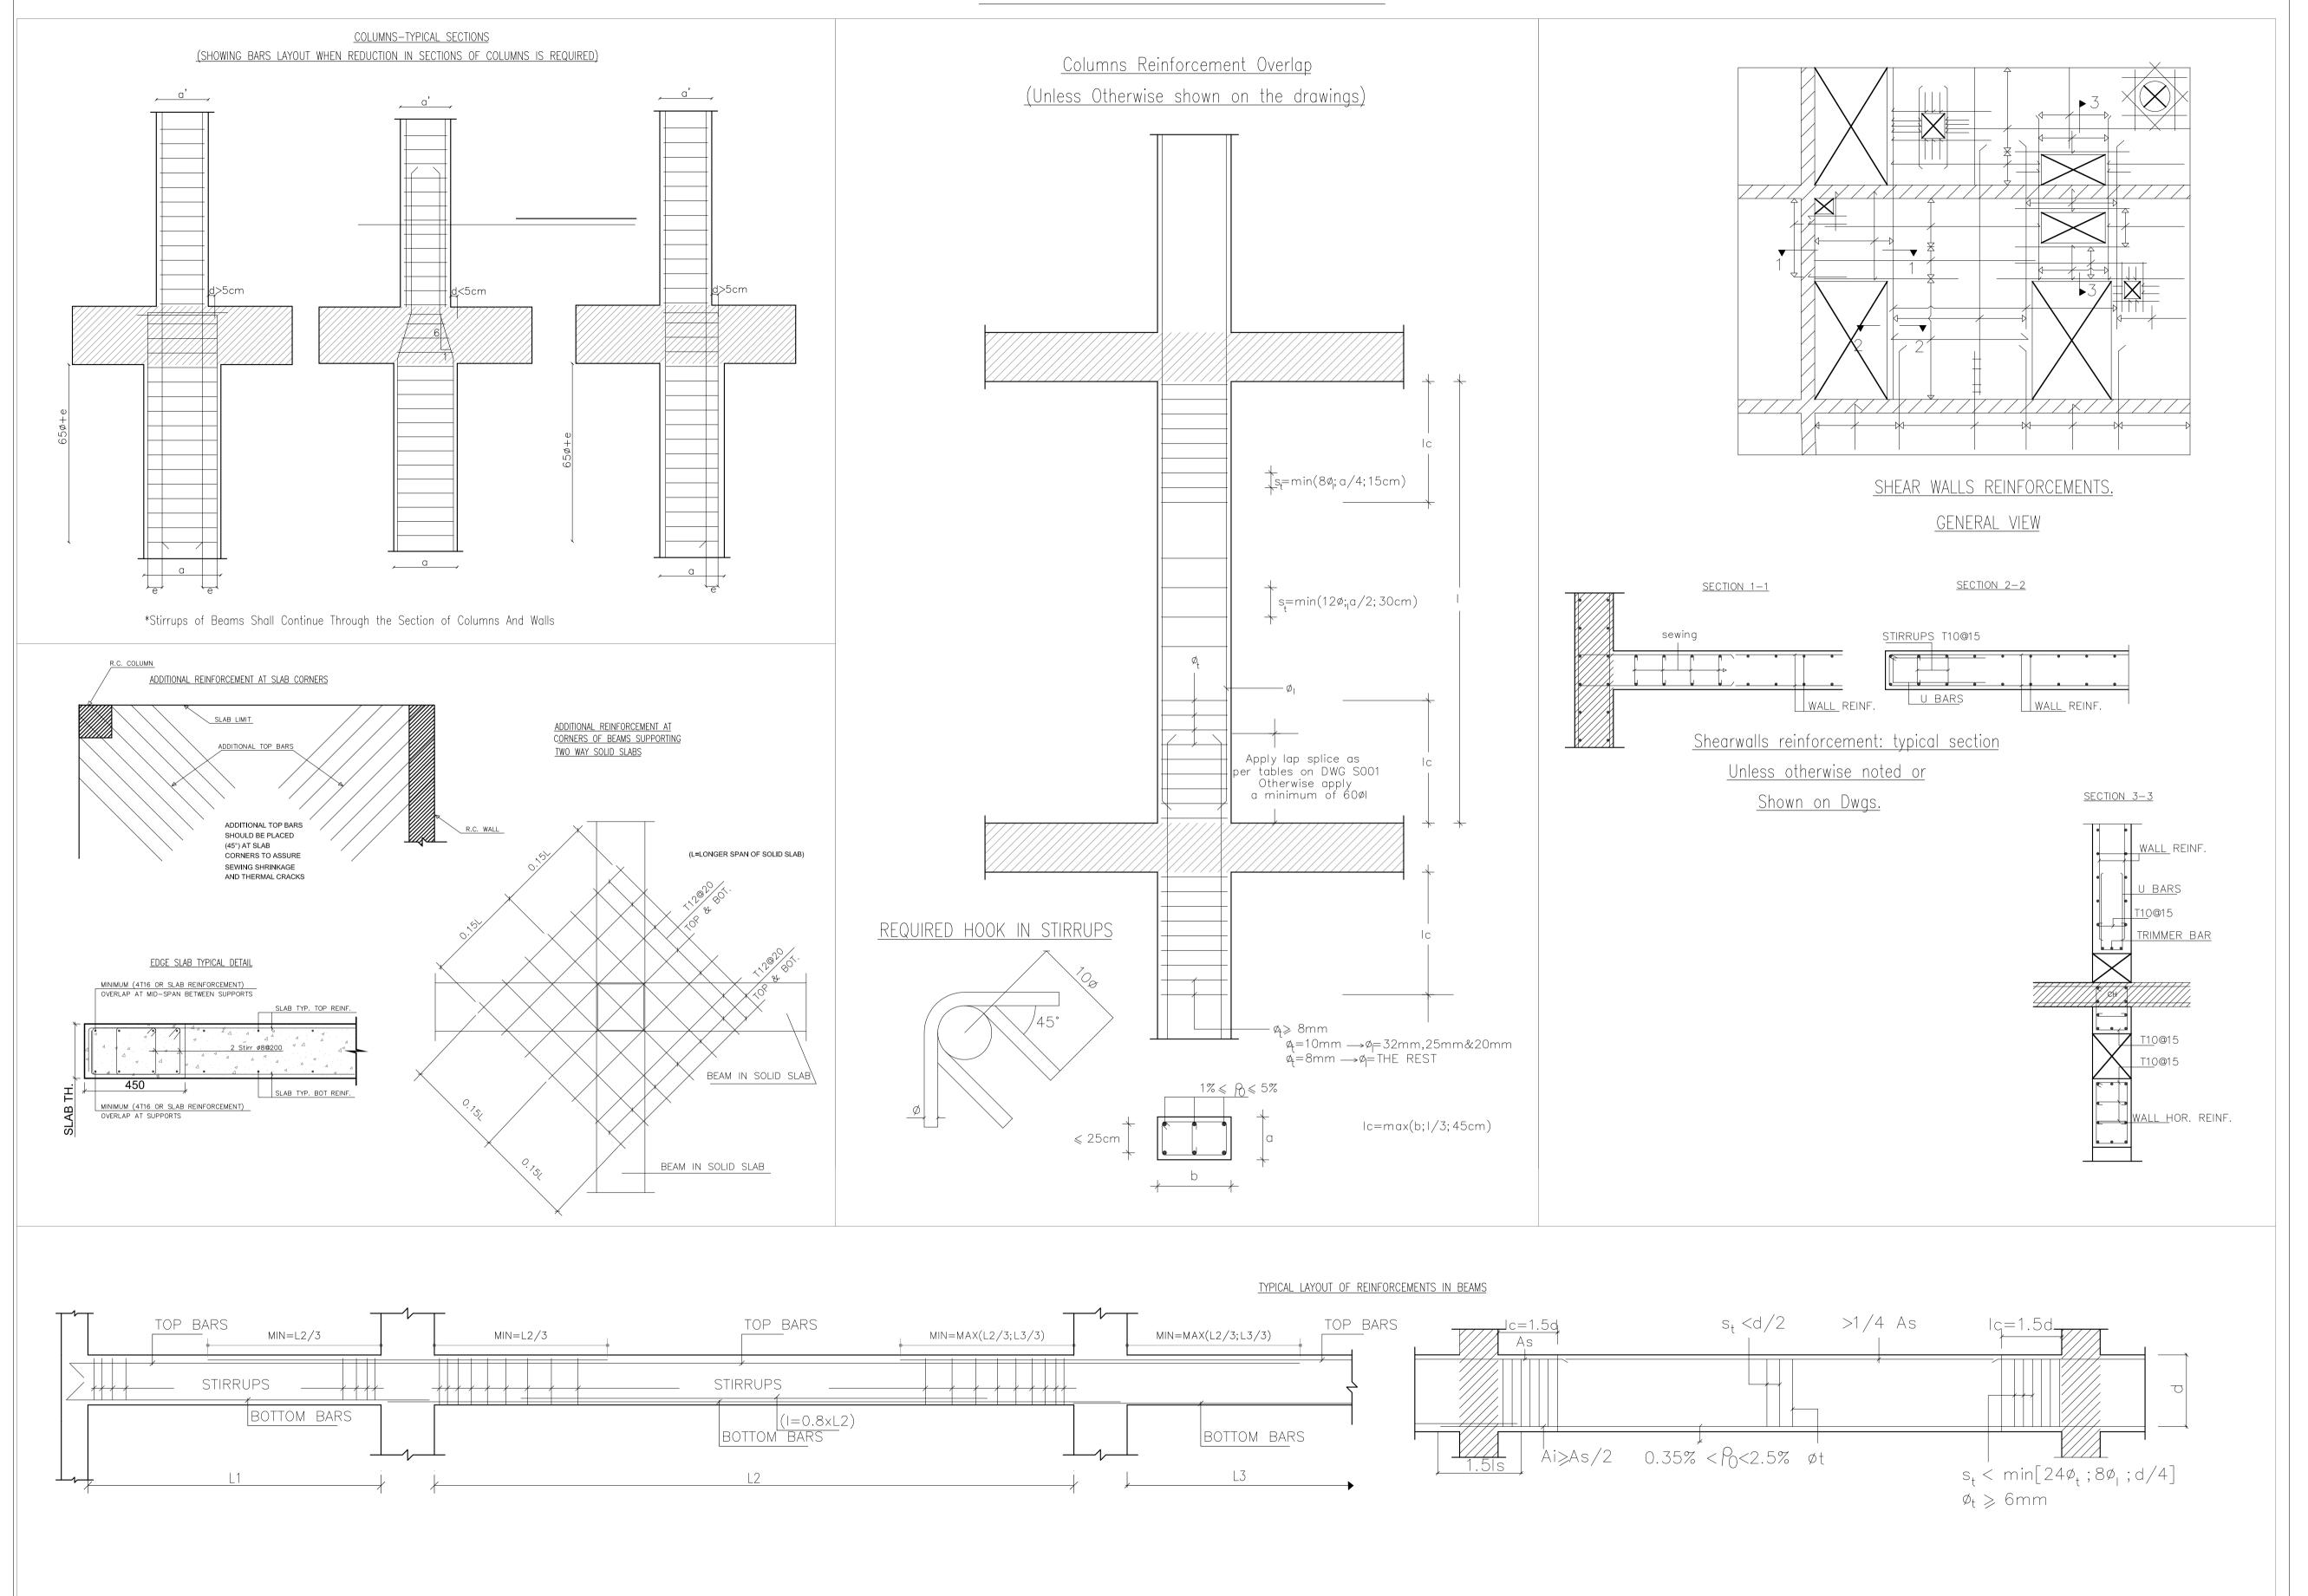

Note:

- all dimensions in (cm)

- all levels in meter (m)

YORKVILLE HOTEL & **APARTMENTS LIMITED**

PROJECT TITLE:

CLIENT: **DELOMIS** DESIGNED DRAWN CHECKED SCALE 17 JAN. 2022 DATE


DRAWING TITLE: GENERAL DETAILS -2-

CONSULTANT OFFICE Java Design Concepts LTD



SIZE: A1

DRAWING no: S-301

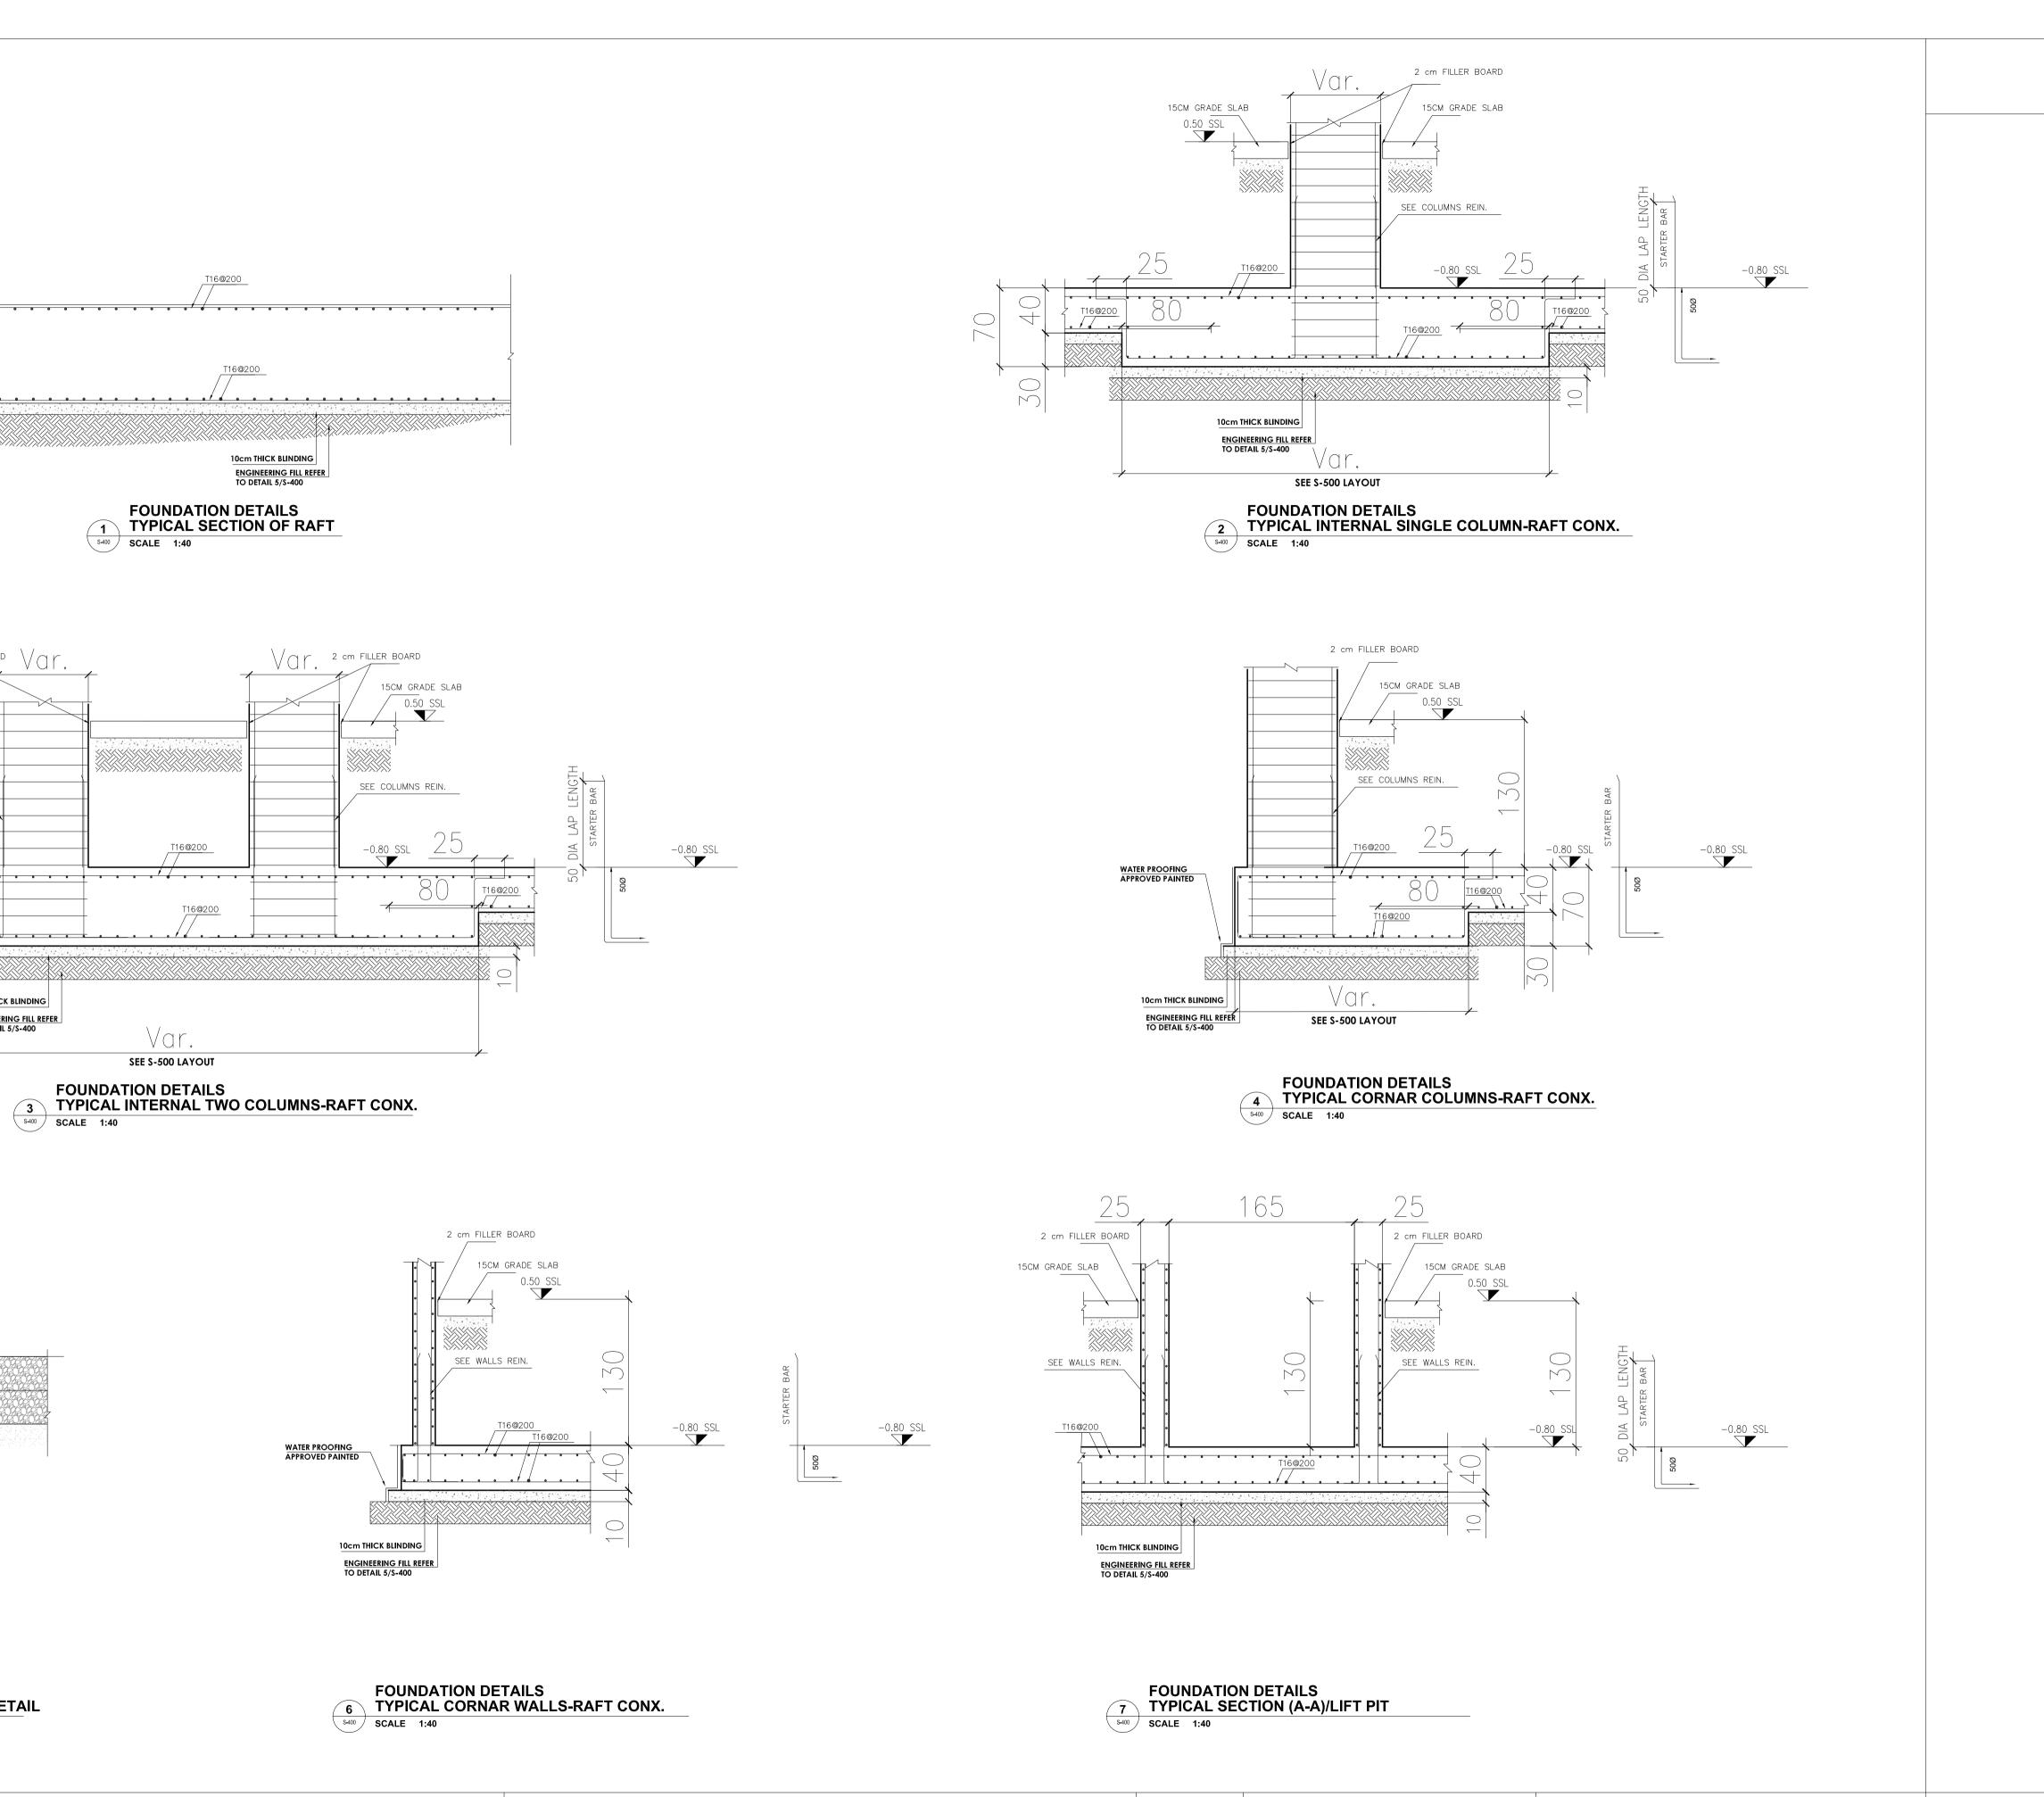

Note		
INOIG	•	

- all dimensions in (cm) - all levels in meter (m)

PROJECT TITLE: YORKVILLE HOTEL &

APARTMENTS LIMITED

2 cm_FILLER_BOARD \

ENGINEERING FILL REFER
TO DETAIL 5/S-400

15CM GRADE SLAB

SEE COLUMNS REIN.

COMPACTED ENGINEERING FILL (30 cm EACH LAYER) -95% PROCTOR

COMPACTED NATURAL SOIL

FOUNDATION DETAILS
TYPICAL BACKFILLING DETAIL

SCALE 1:40

CLIENT:

DELOMIS


DESIGNED	
DRAWN	
CHECKED	
SCALE	
DATE	17 JAN. 2022

DRAWING TITLE: FOUNDATION DETAIL CONSULTANT OFFICE Java Design Concepts LTD

APPROVAL



DRAWING no: S-400 SIZE: A1

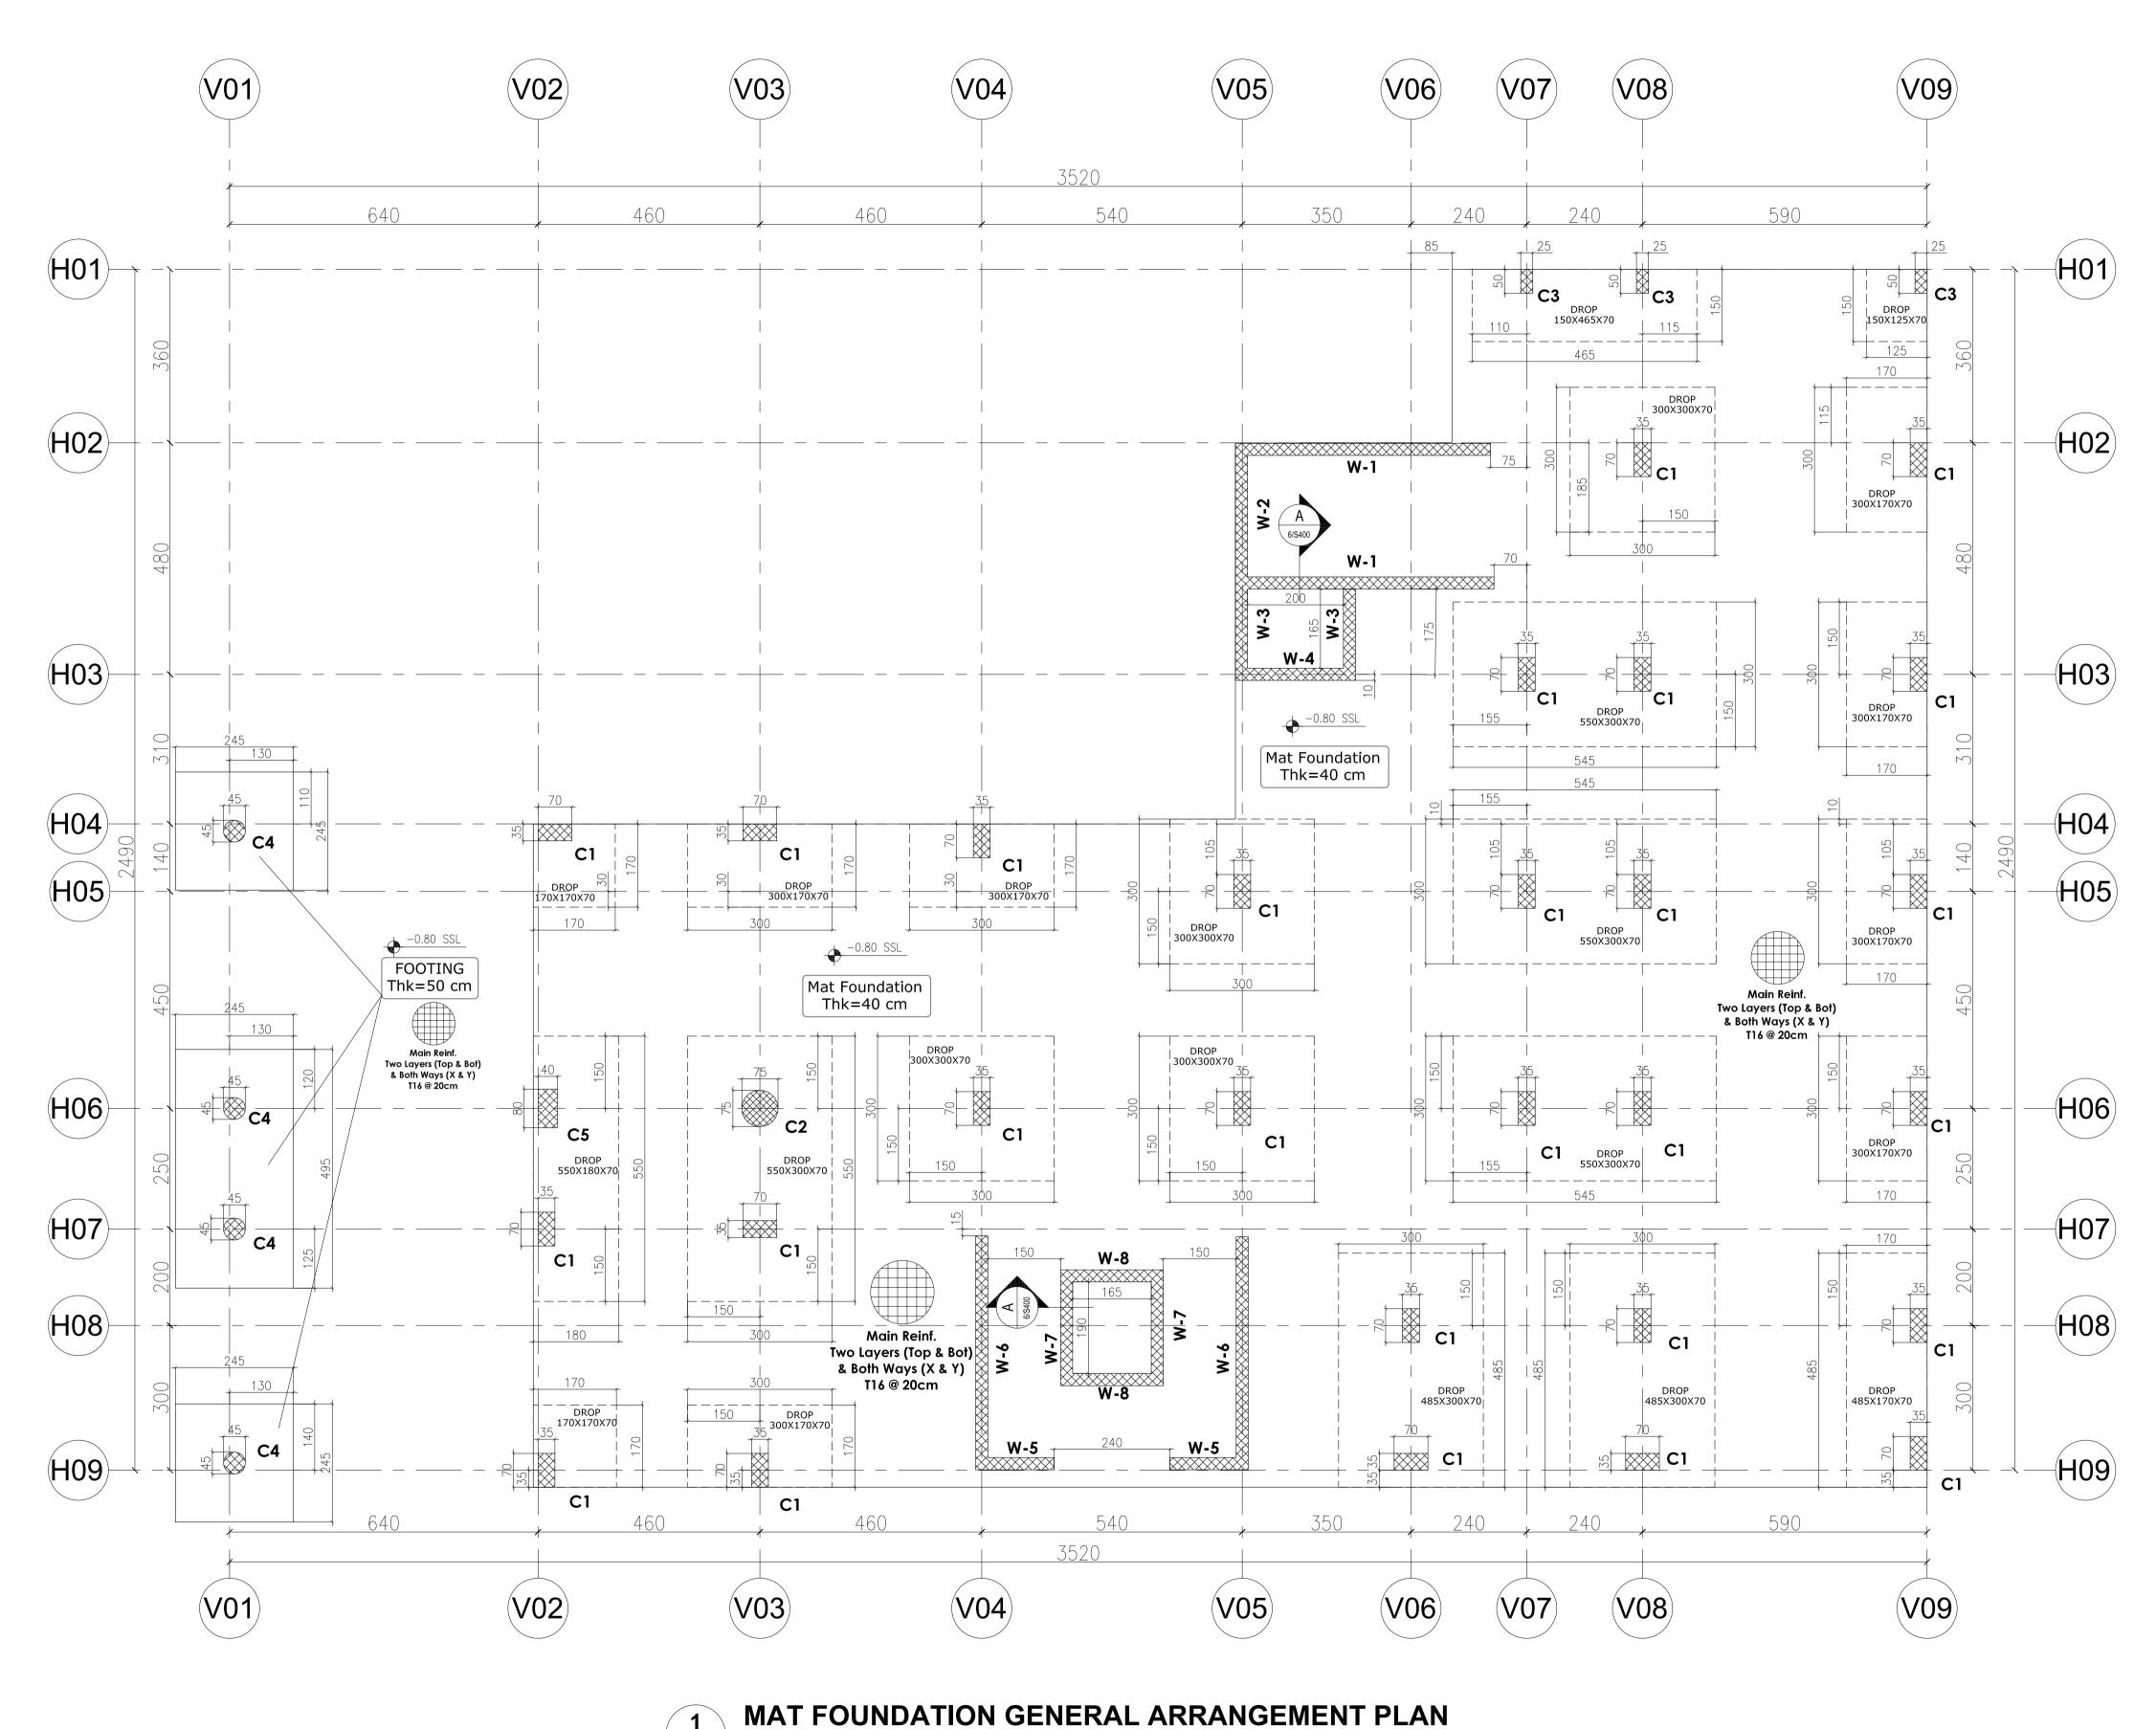

S-500 SCALE 1:75

Note:

all dimensions in (cm)all levels in meter (m)

YORKVILLE HOTEL & APARTMENTS LIMITED

PROJECT TITLE:

CLIENT: **DELOMIS**

DESIGNED

DRAWING TITLE:

MAT FOUNDATION
GENERAL
ARRANGEMENT PLAN

DATE 17 JAN. 2022

DRAWING TITLE:

MAT FOUNDATION
GENERAL


CONSULTANT OFFICE


Java Design Concepts

LTD



SIZE: A1 DRAWING no:

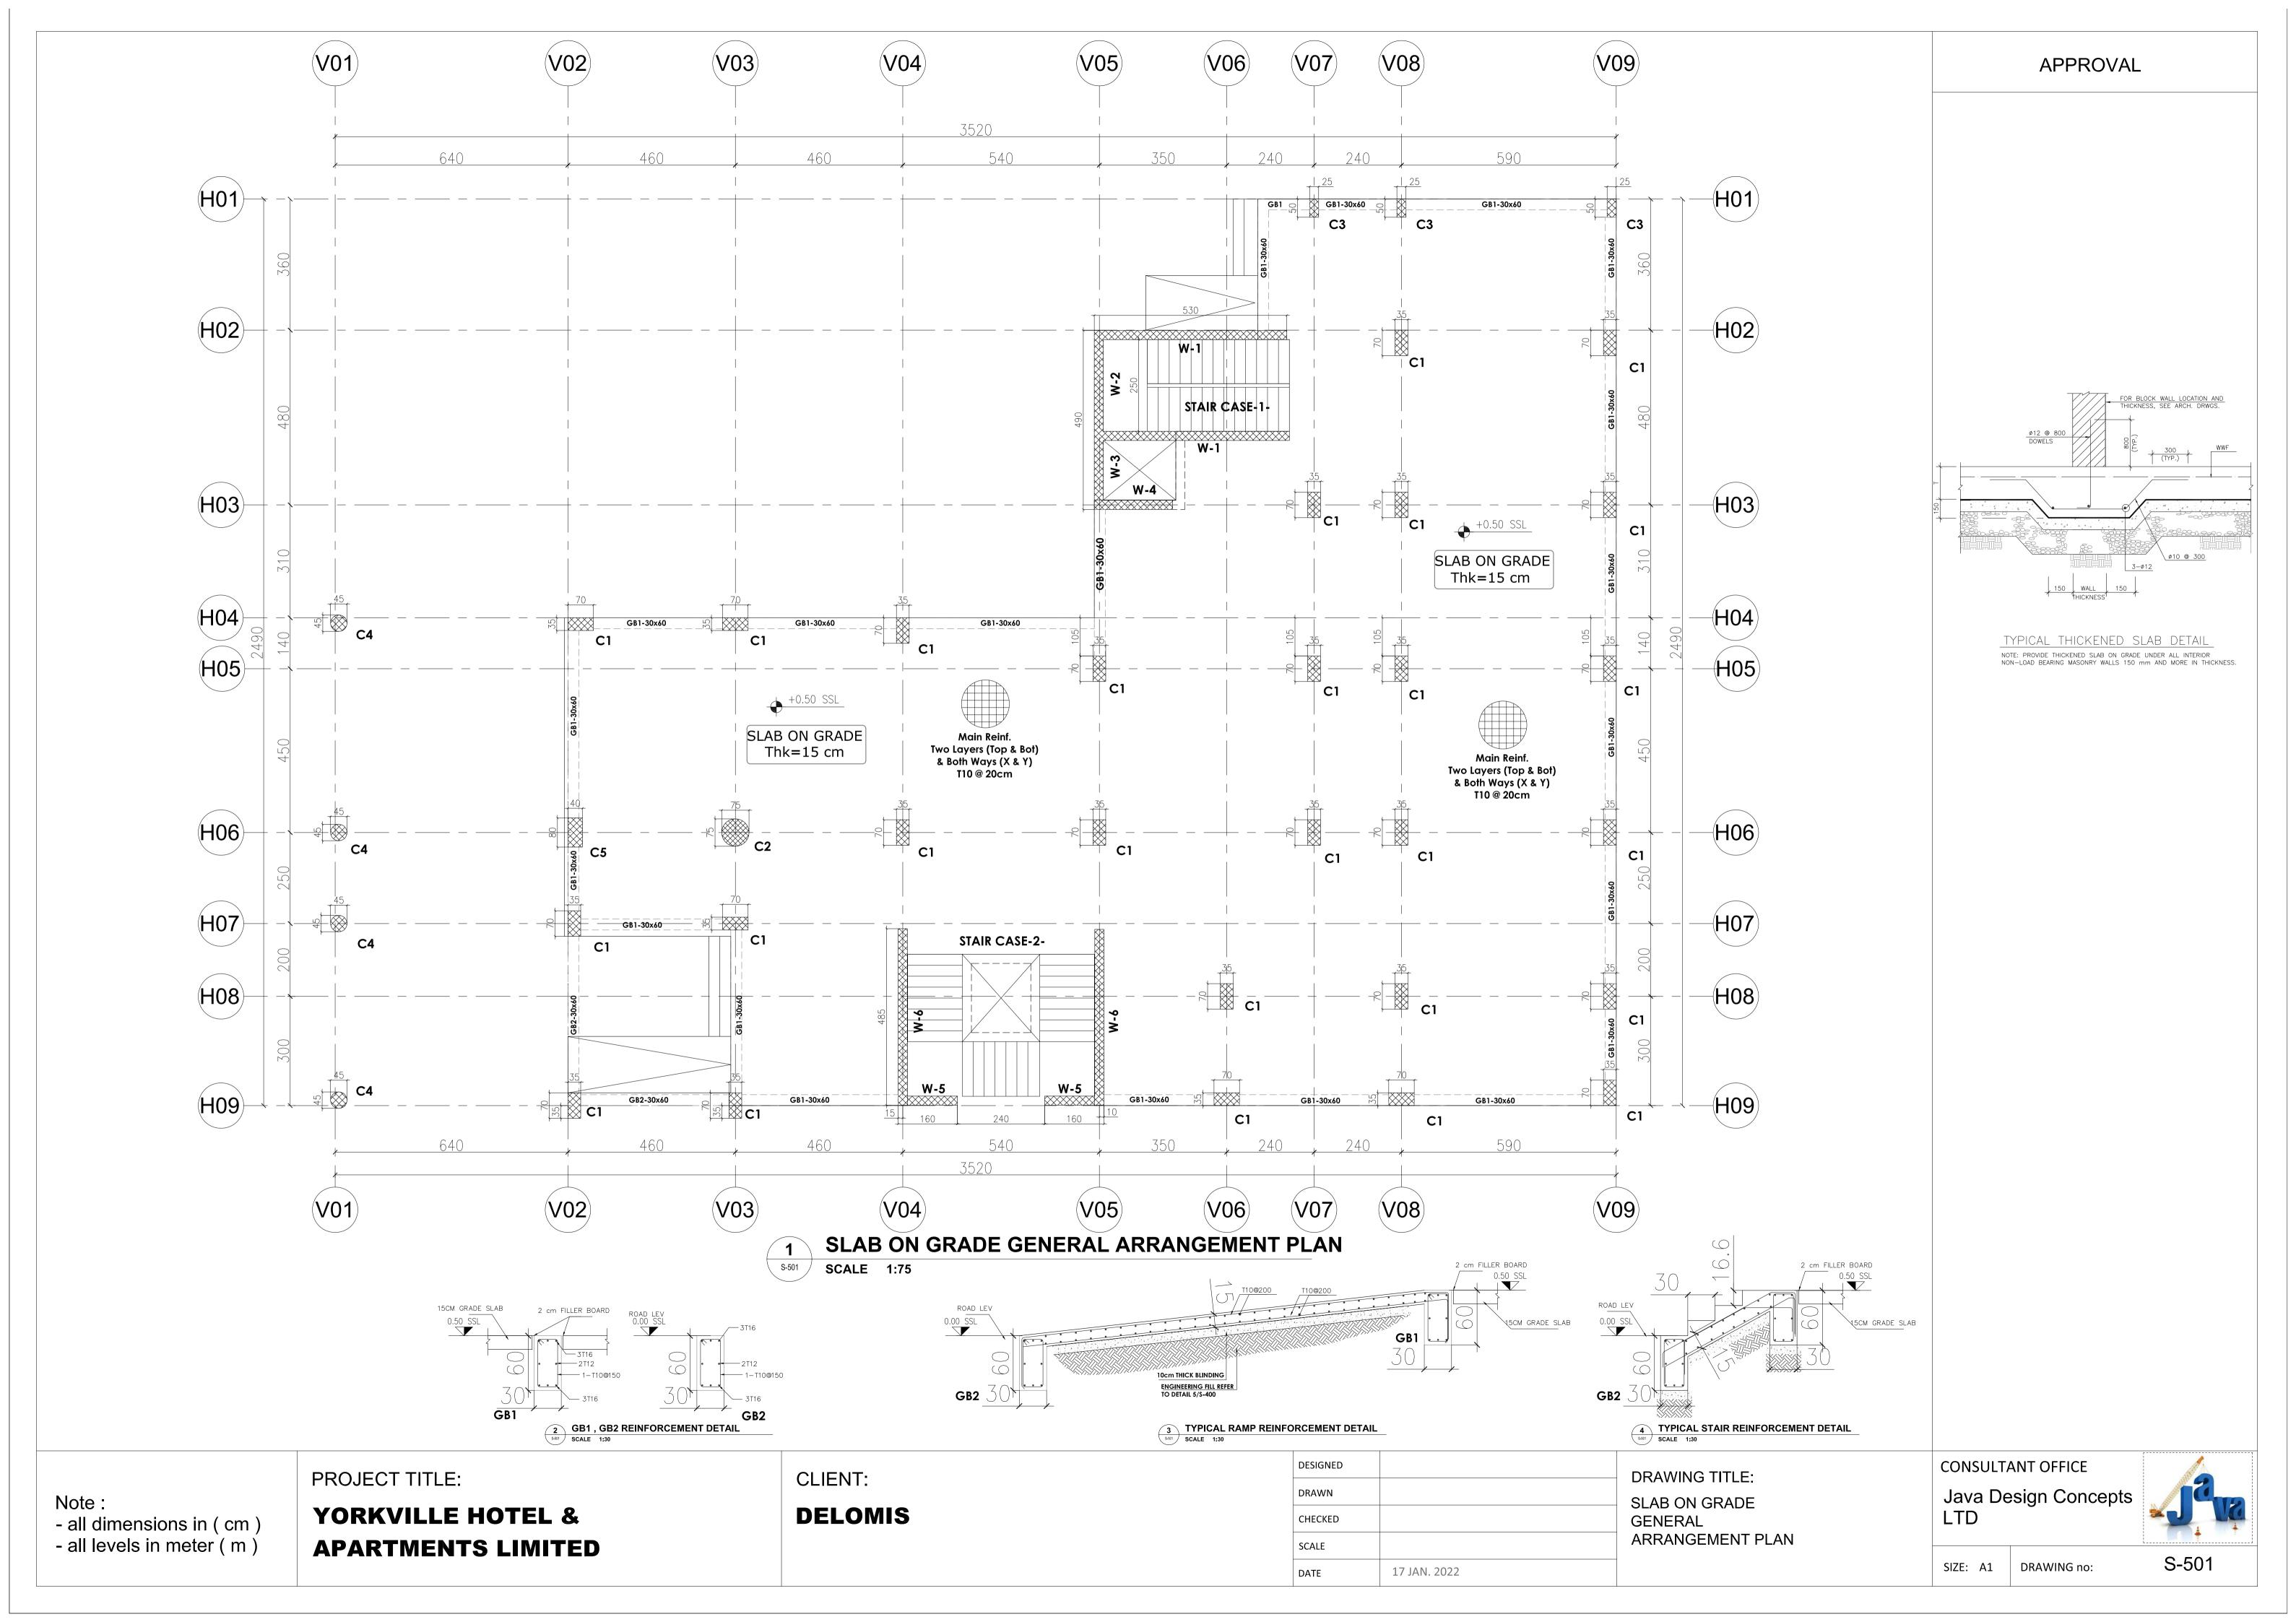

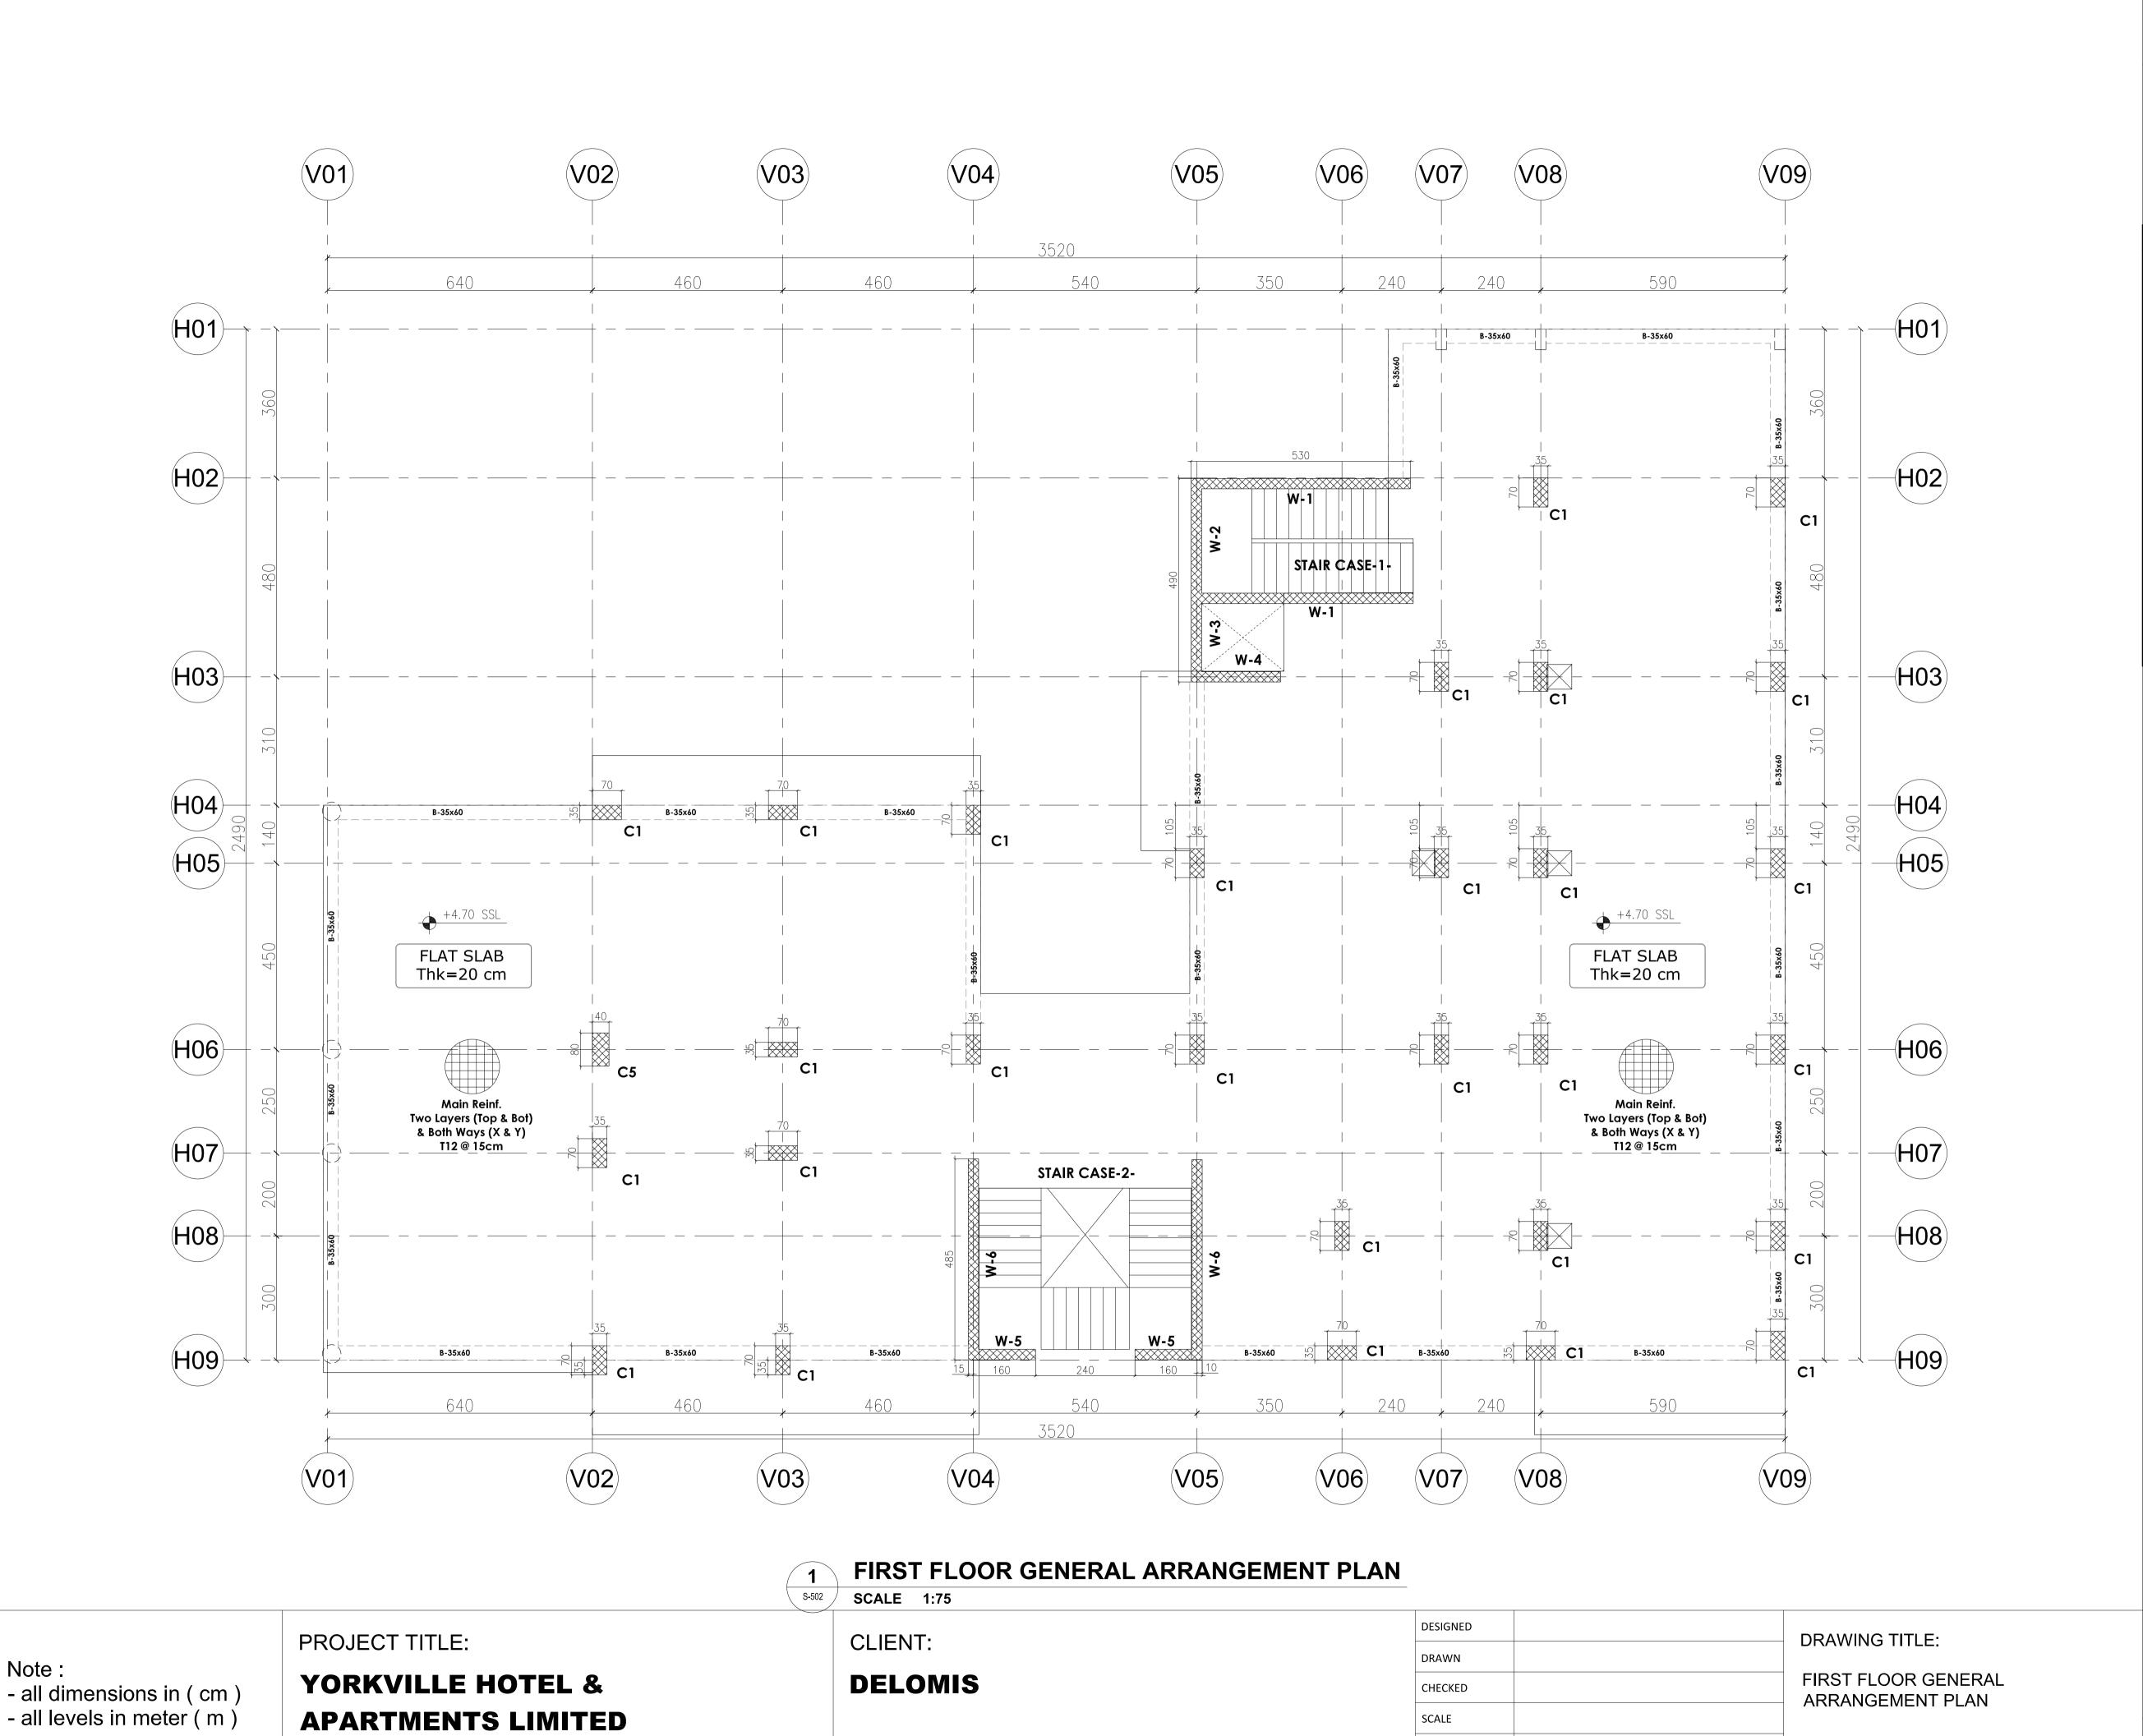

17 JAN. 2022

DATE

Note:

APPROVAL

BEAMS SCHEDULE

B 40X60 TYPE SECTION AND DETAILS

TOP BOTTOM LINKS REINFORCEMENT DETAILS 2T8@150 3T16


1T8@150 L=120

CONSULTANT OFFICE

Java Design Concepts LTD



SIZE: A1 DRAWING no:

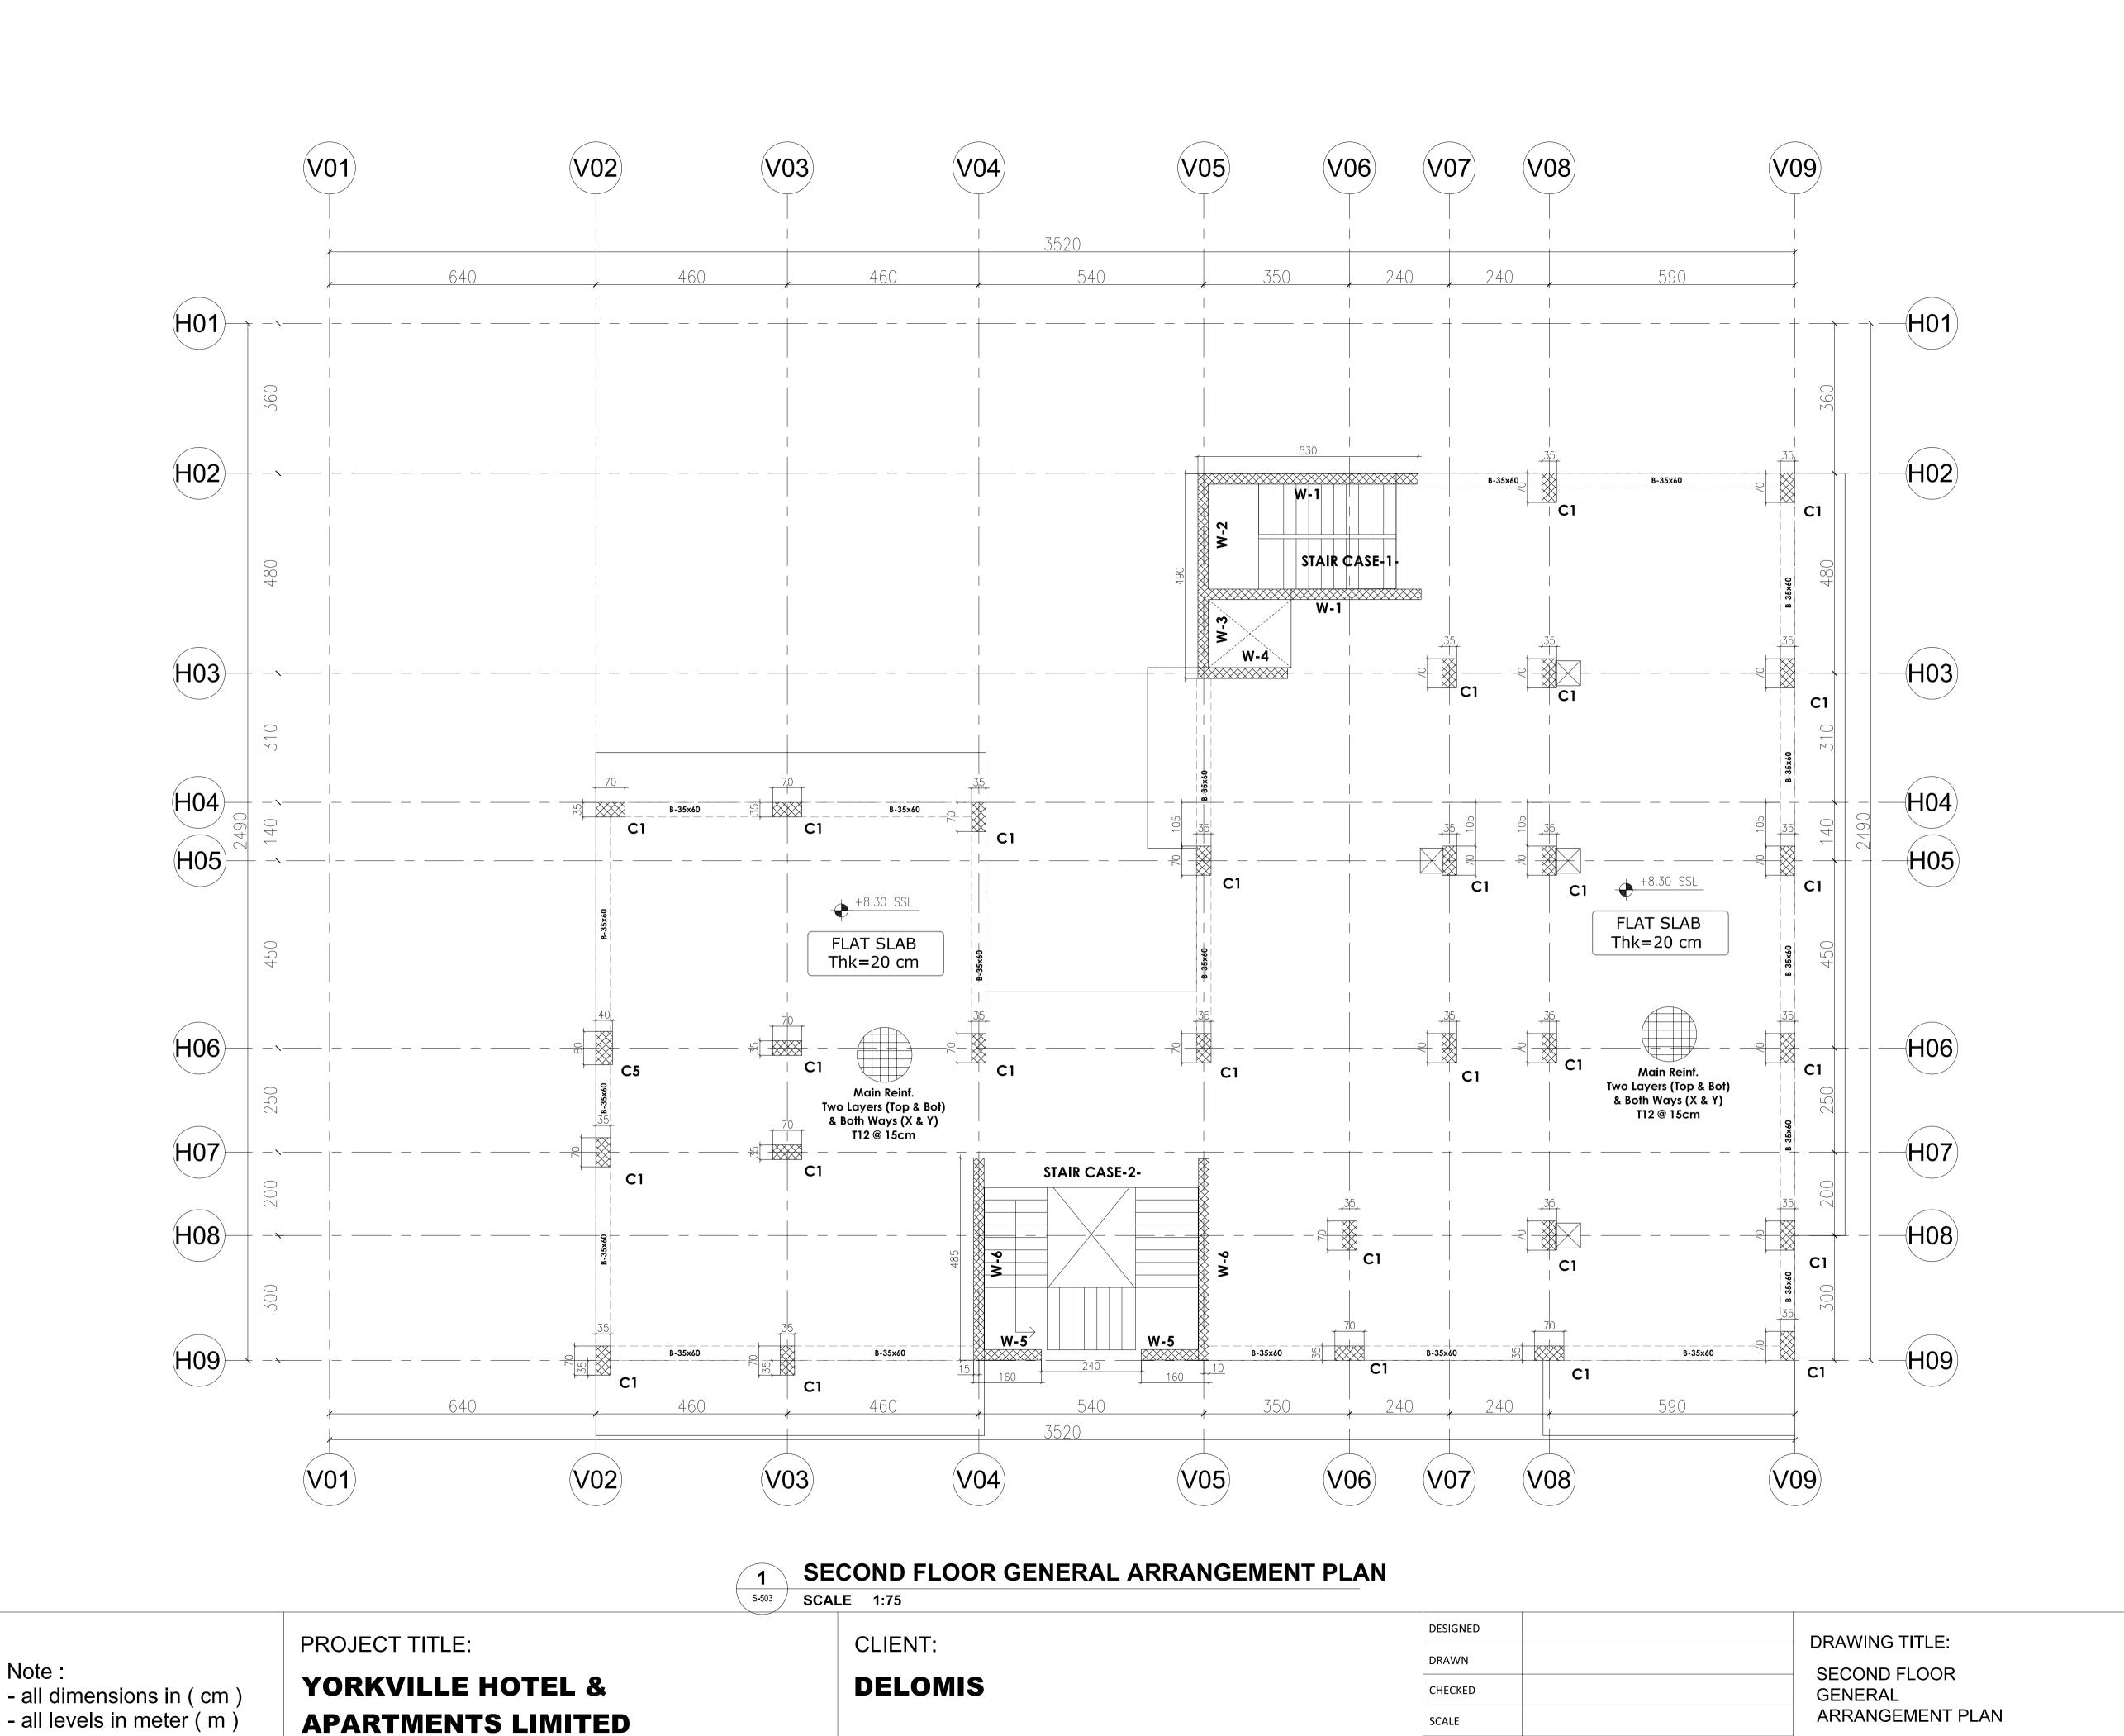

APPROVAL

BEAMS SCHEDULE

B 40X60

SECTION AND

DETAILS

TYPE

1T8@150 L=120 TOP BOTTOM LINKS

REINFORCEMENT **DETAILS** 3T16 2T8@150

CONSULTANT OFFICE


Java Design Concepts

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17 JAN. 2022

DATE

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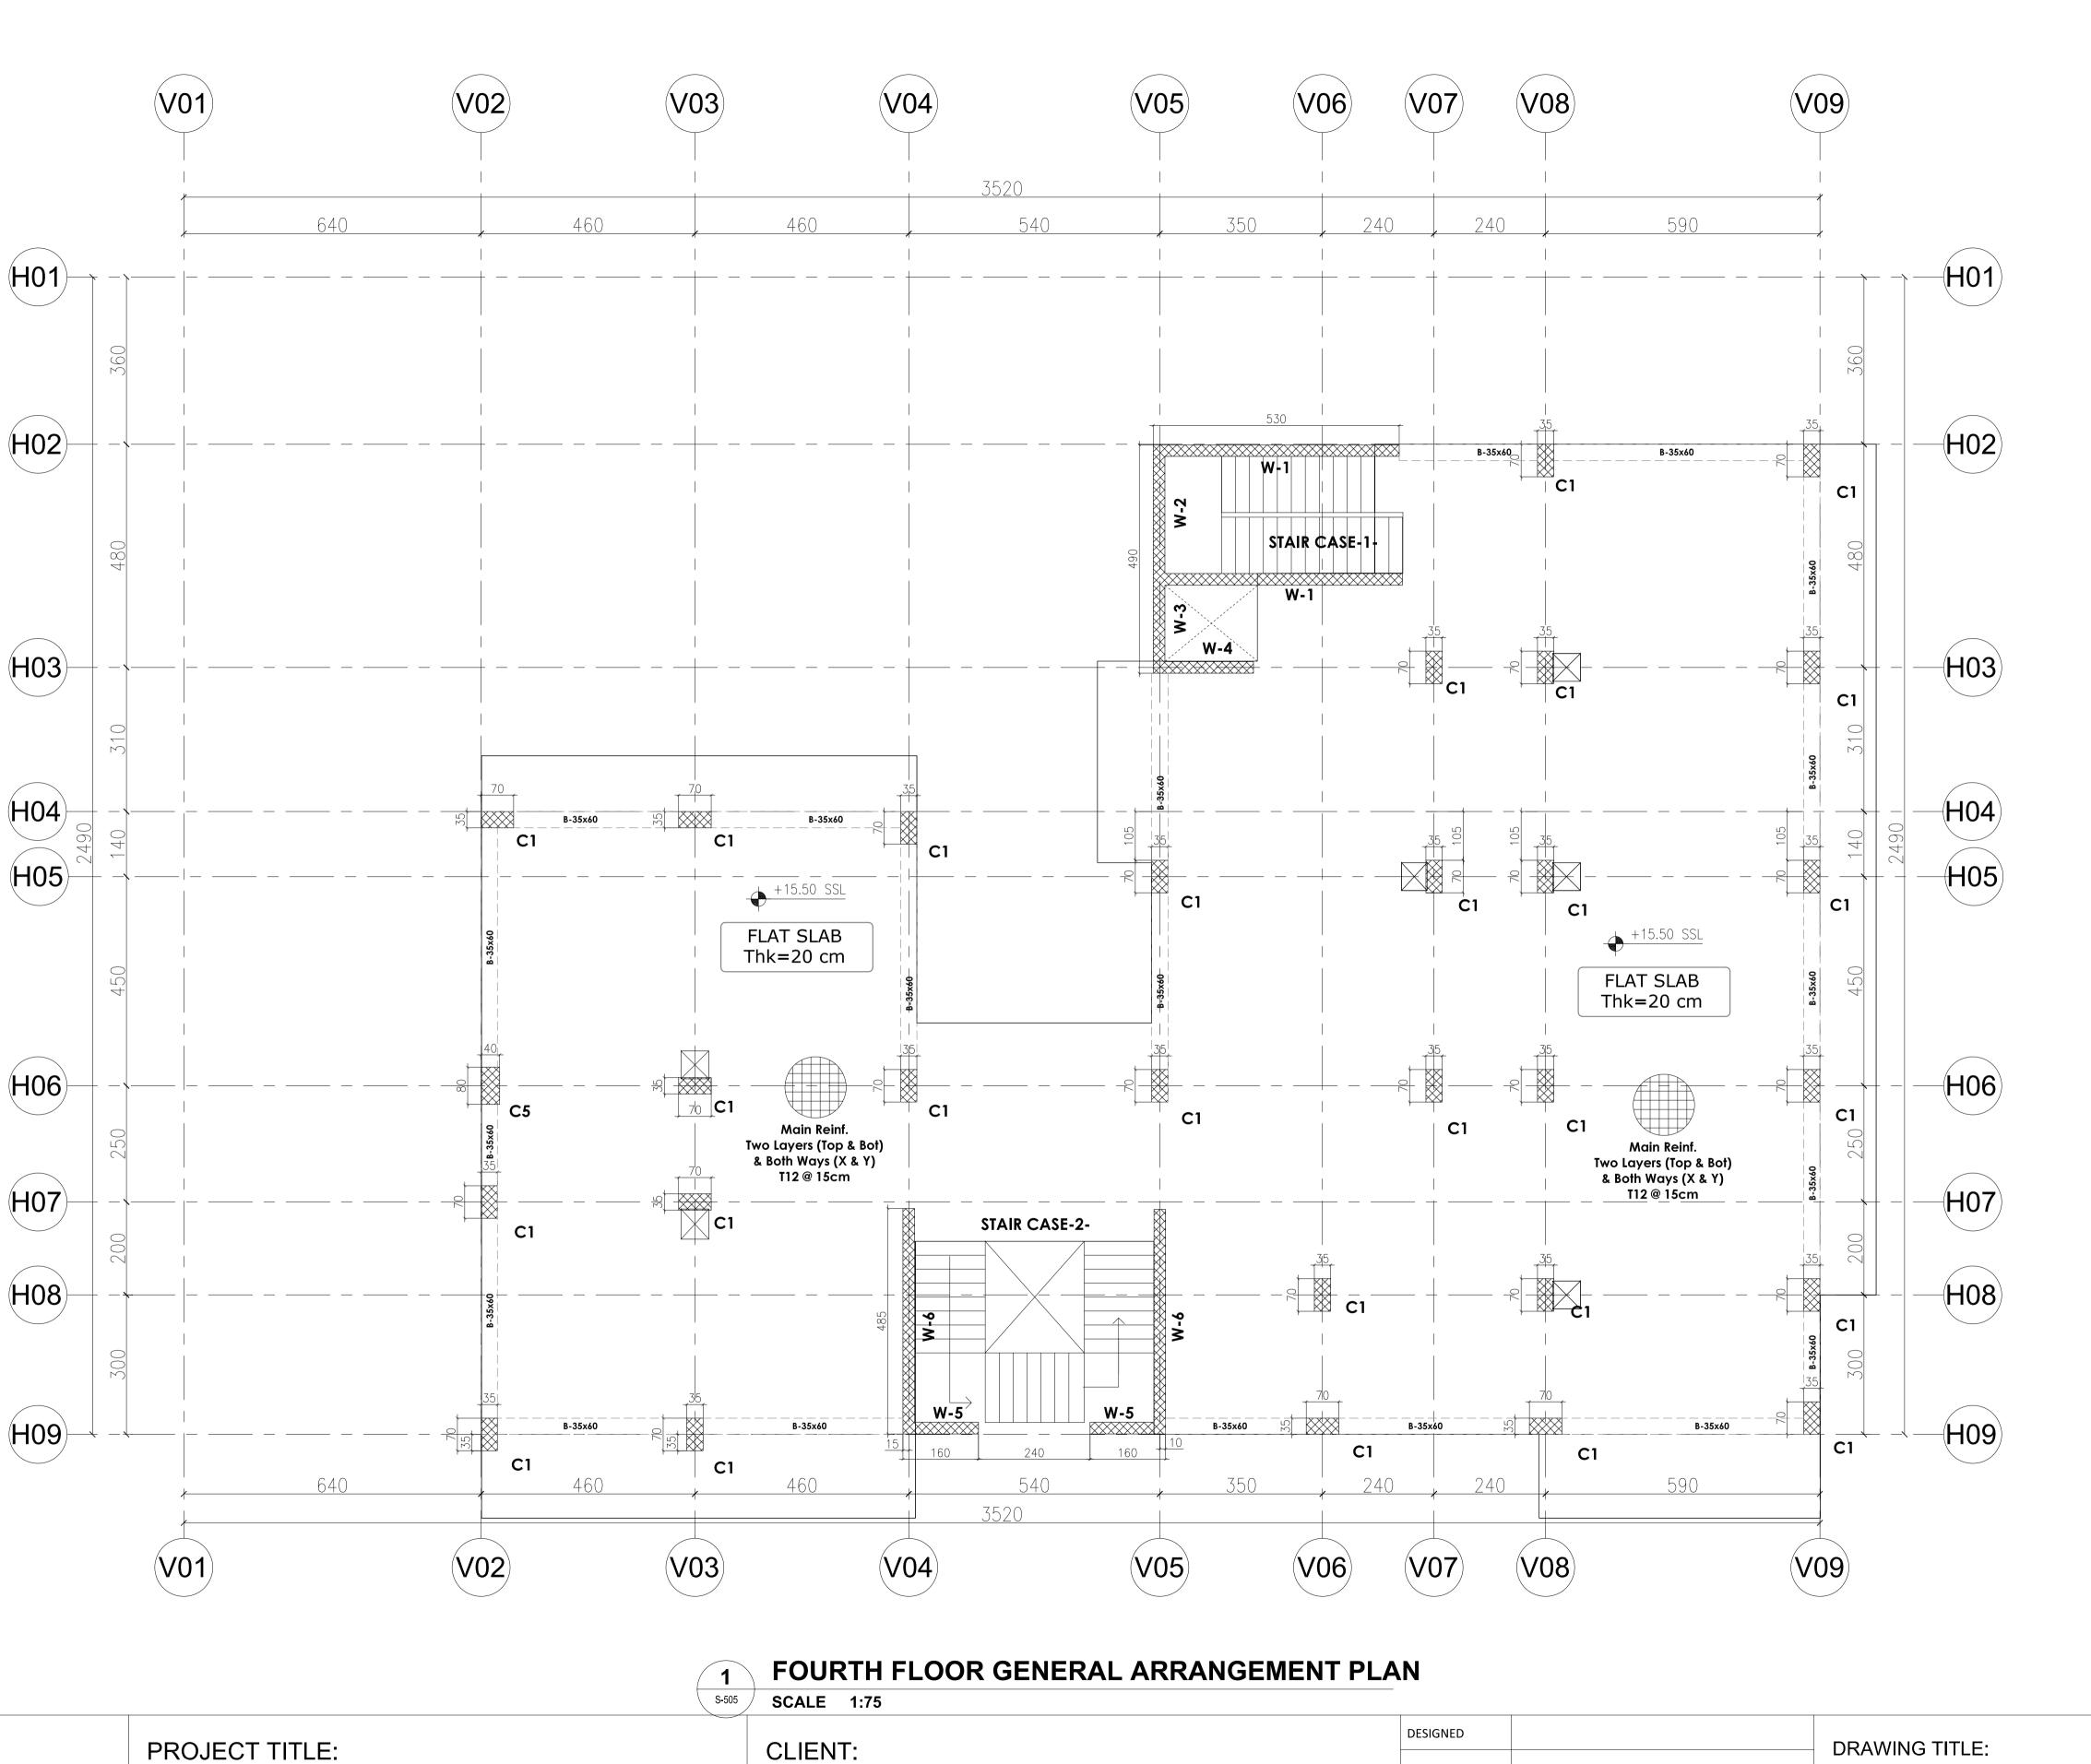


1T8@150 L=120

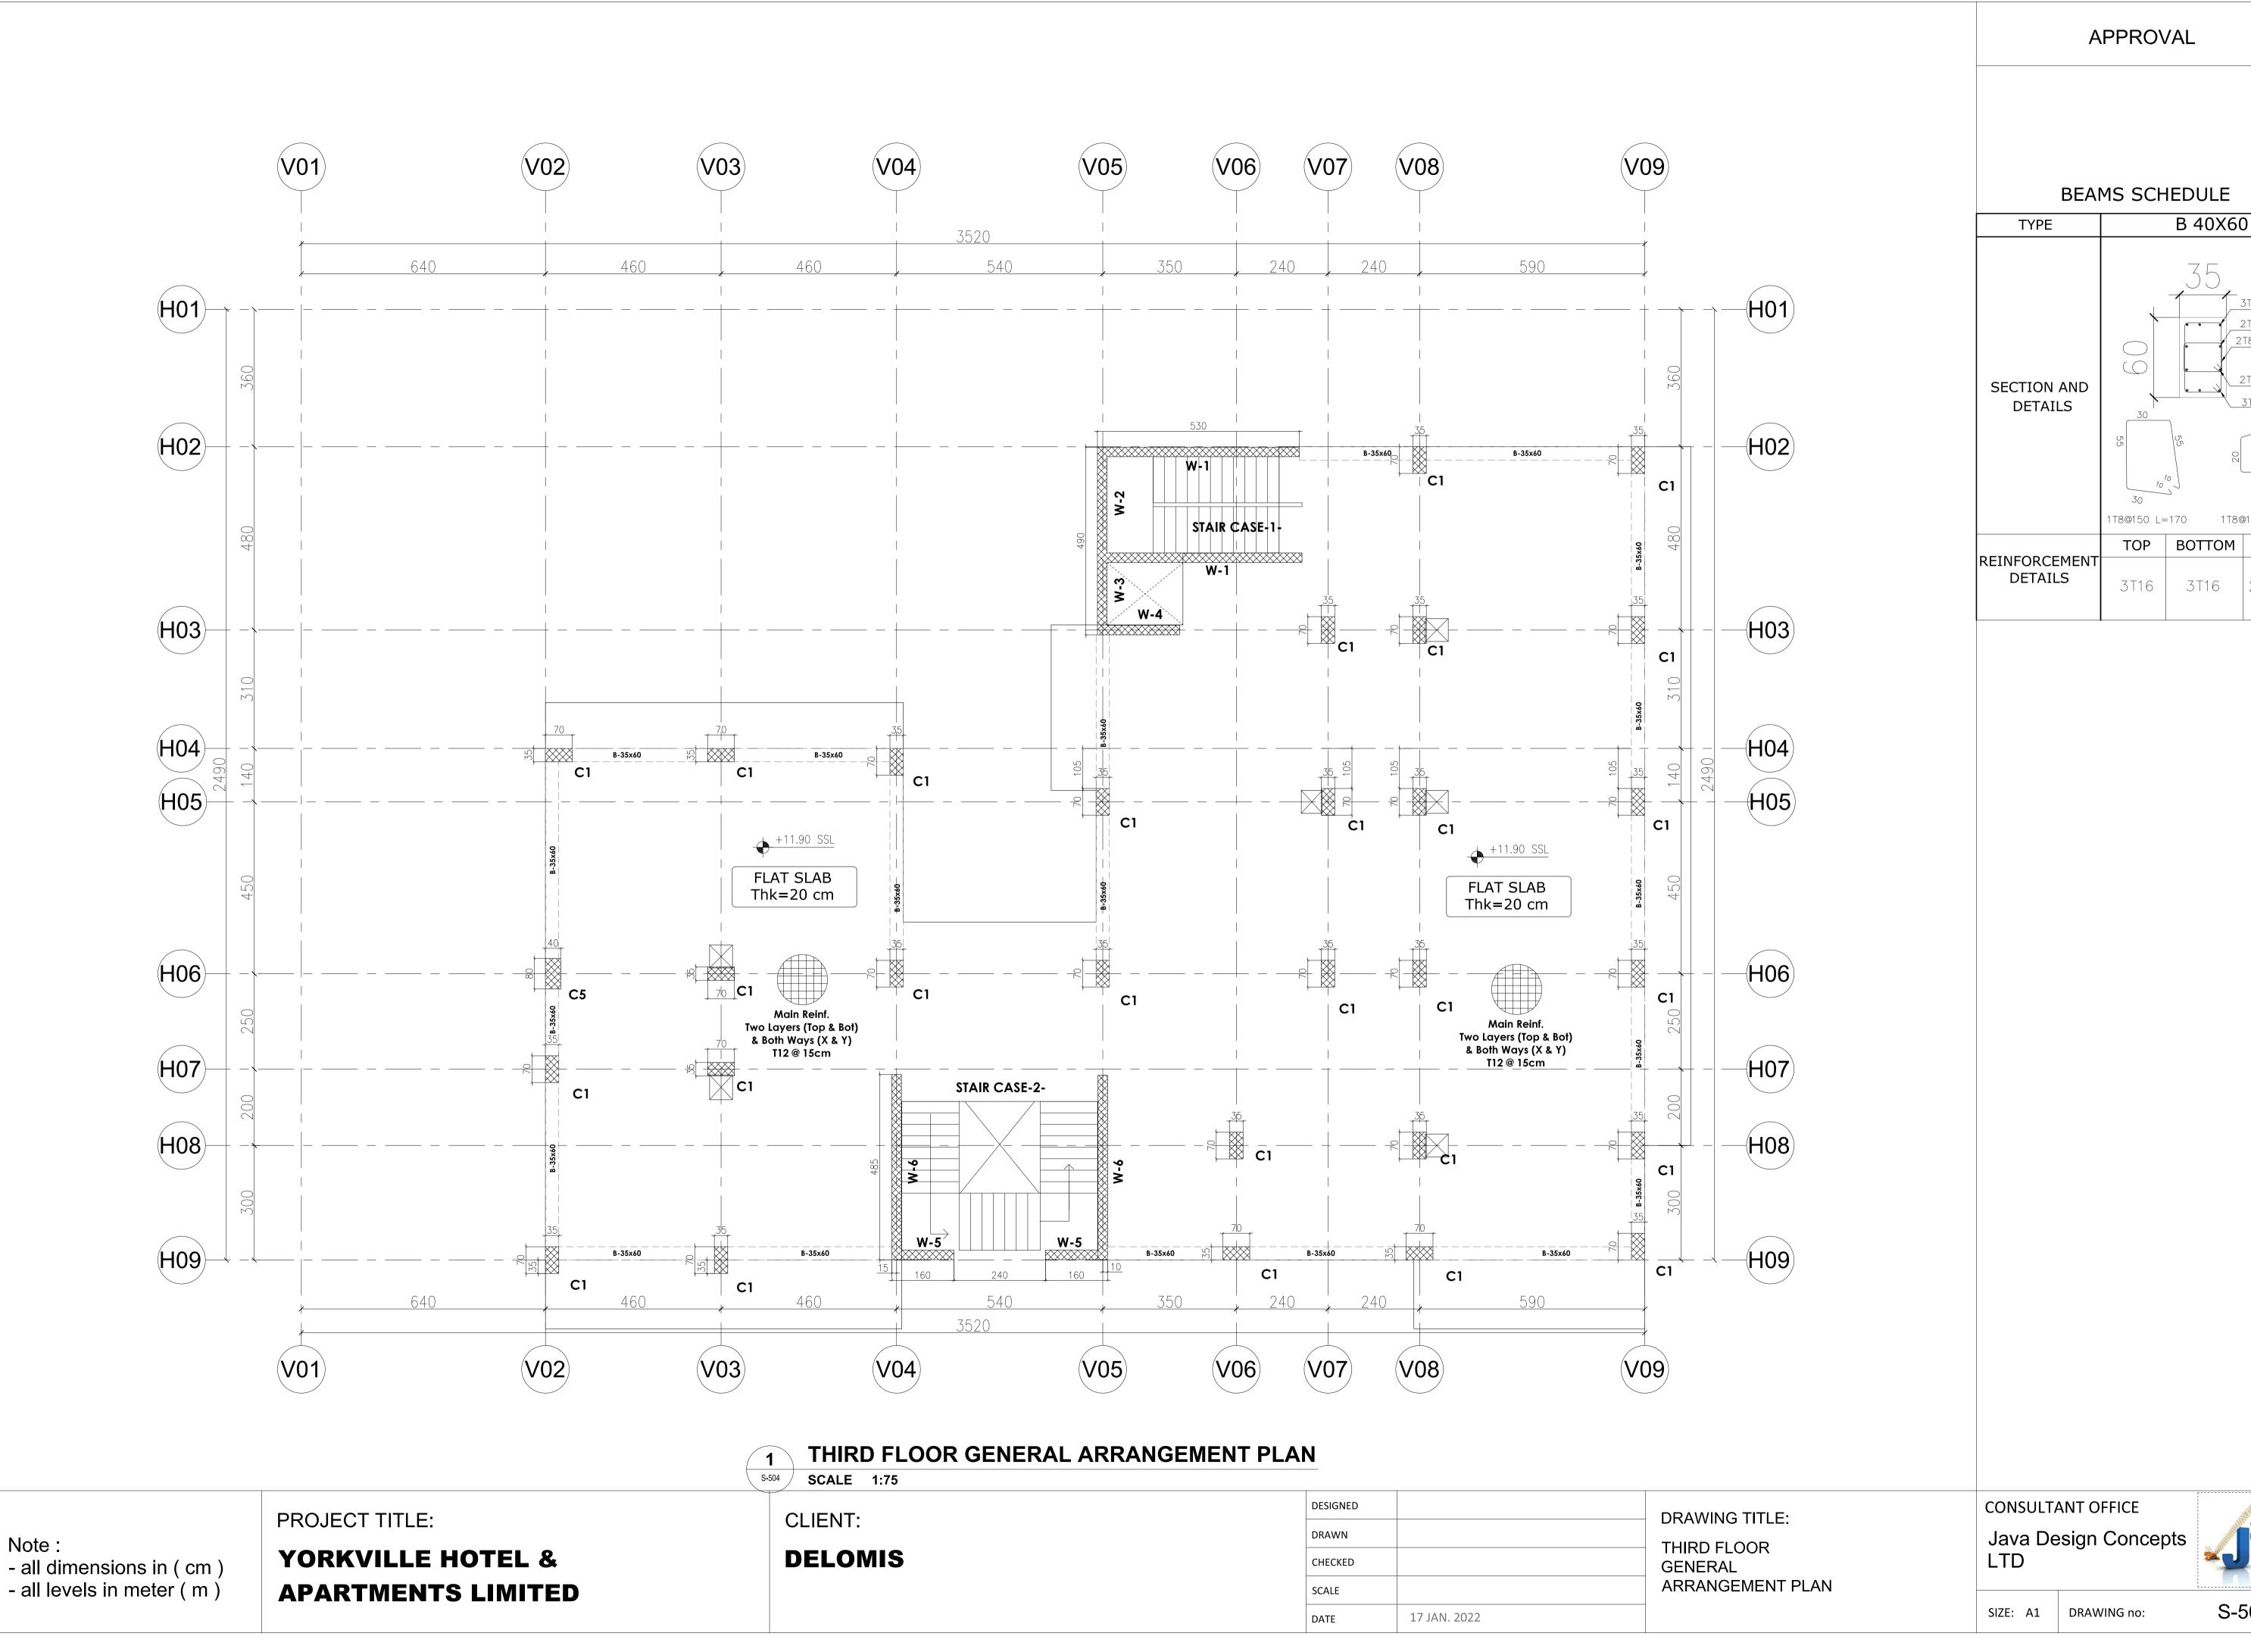S-504

LINKS

2T8@150



APPROVAL

BEAMS SCHEDULE

B 40X60 TYPE SECTION AND

DETAILS

1T8@150 L=120

TOP BOTTOM LINKS

REINFORCEMENT DETAILS

3T16

2T8@15C

Note:

- all dimensions in (cm) - all levels in meter (m)

YORKVILLE HOTEL & **APARTMENTS LIMITED** **DELOMIS**

DRAWN CHECKED SCALE 17 JAN. 2022 DATE


FOURTH FLOOR **GENERAL** ARRANGEMENT PLAN CONSULTANT OFFICE

Java Design Concepts LTD

SIZE: A1

S-505

DRAWING no:

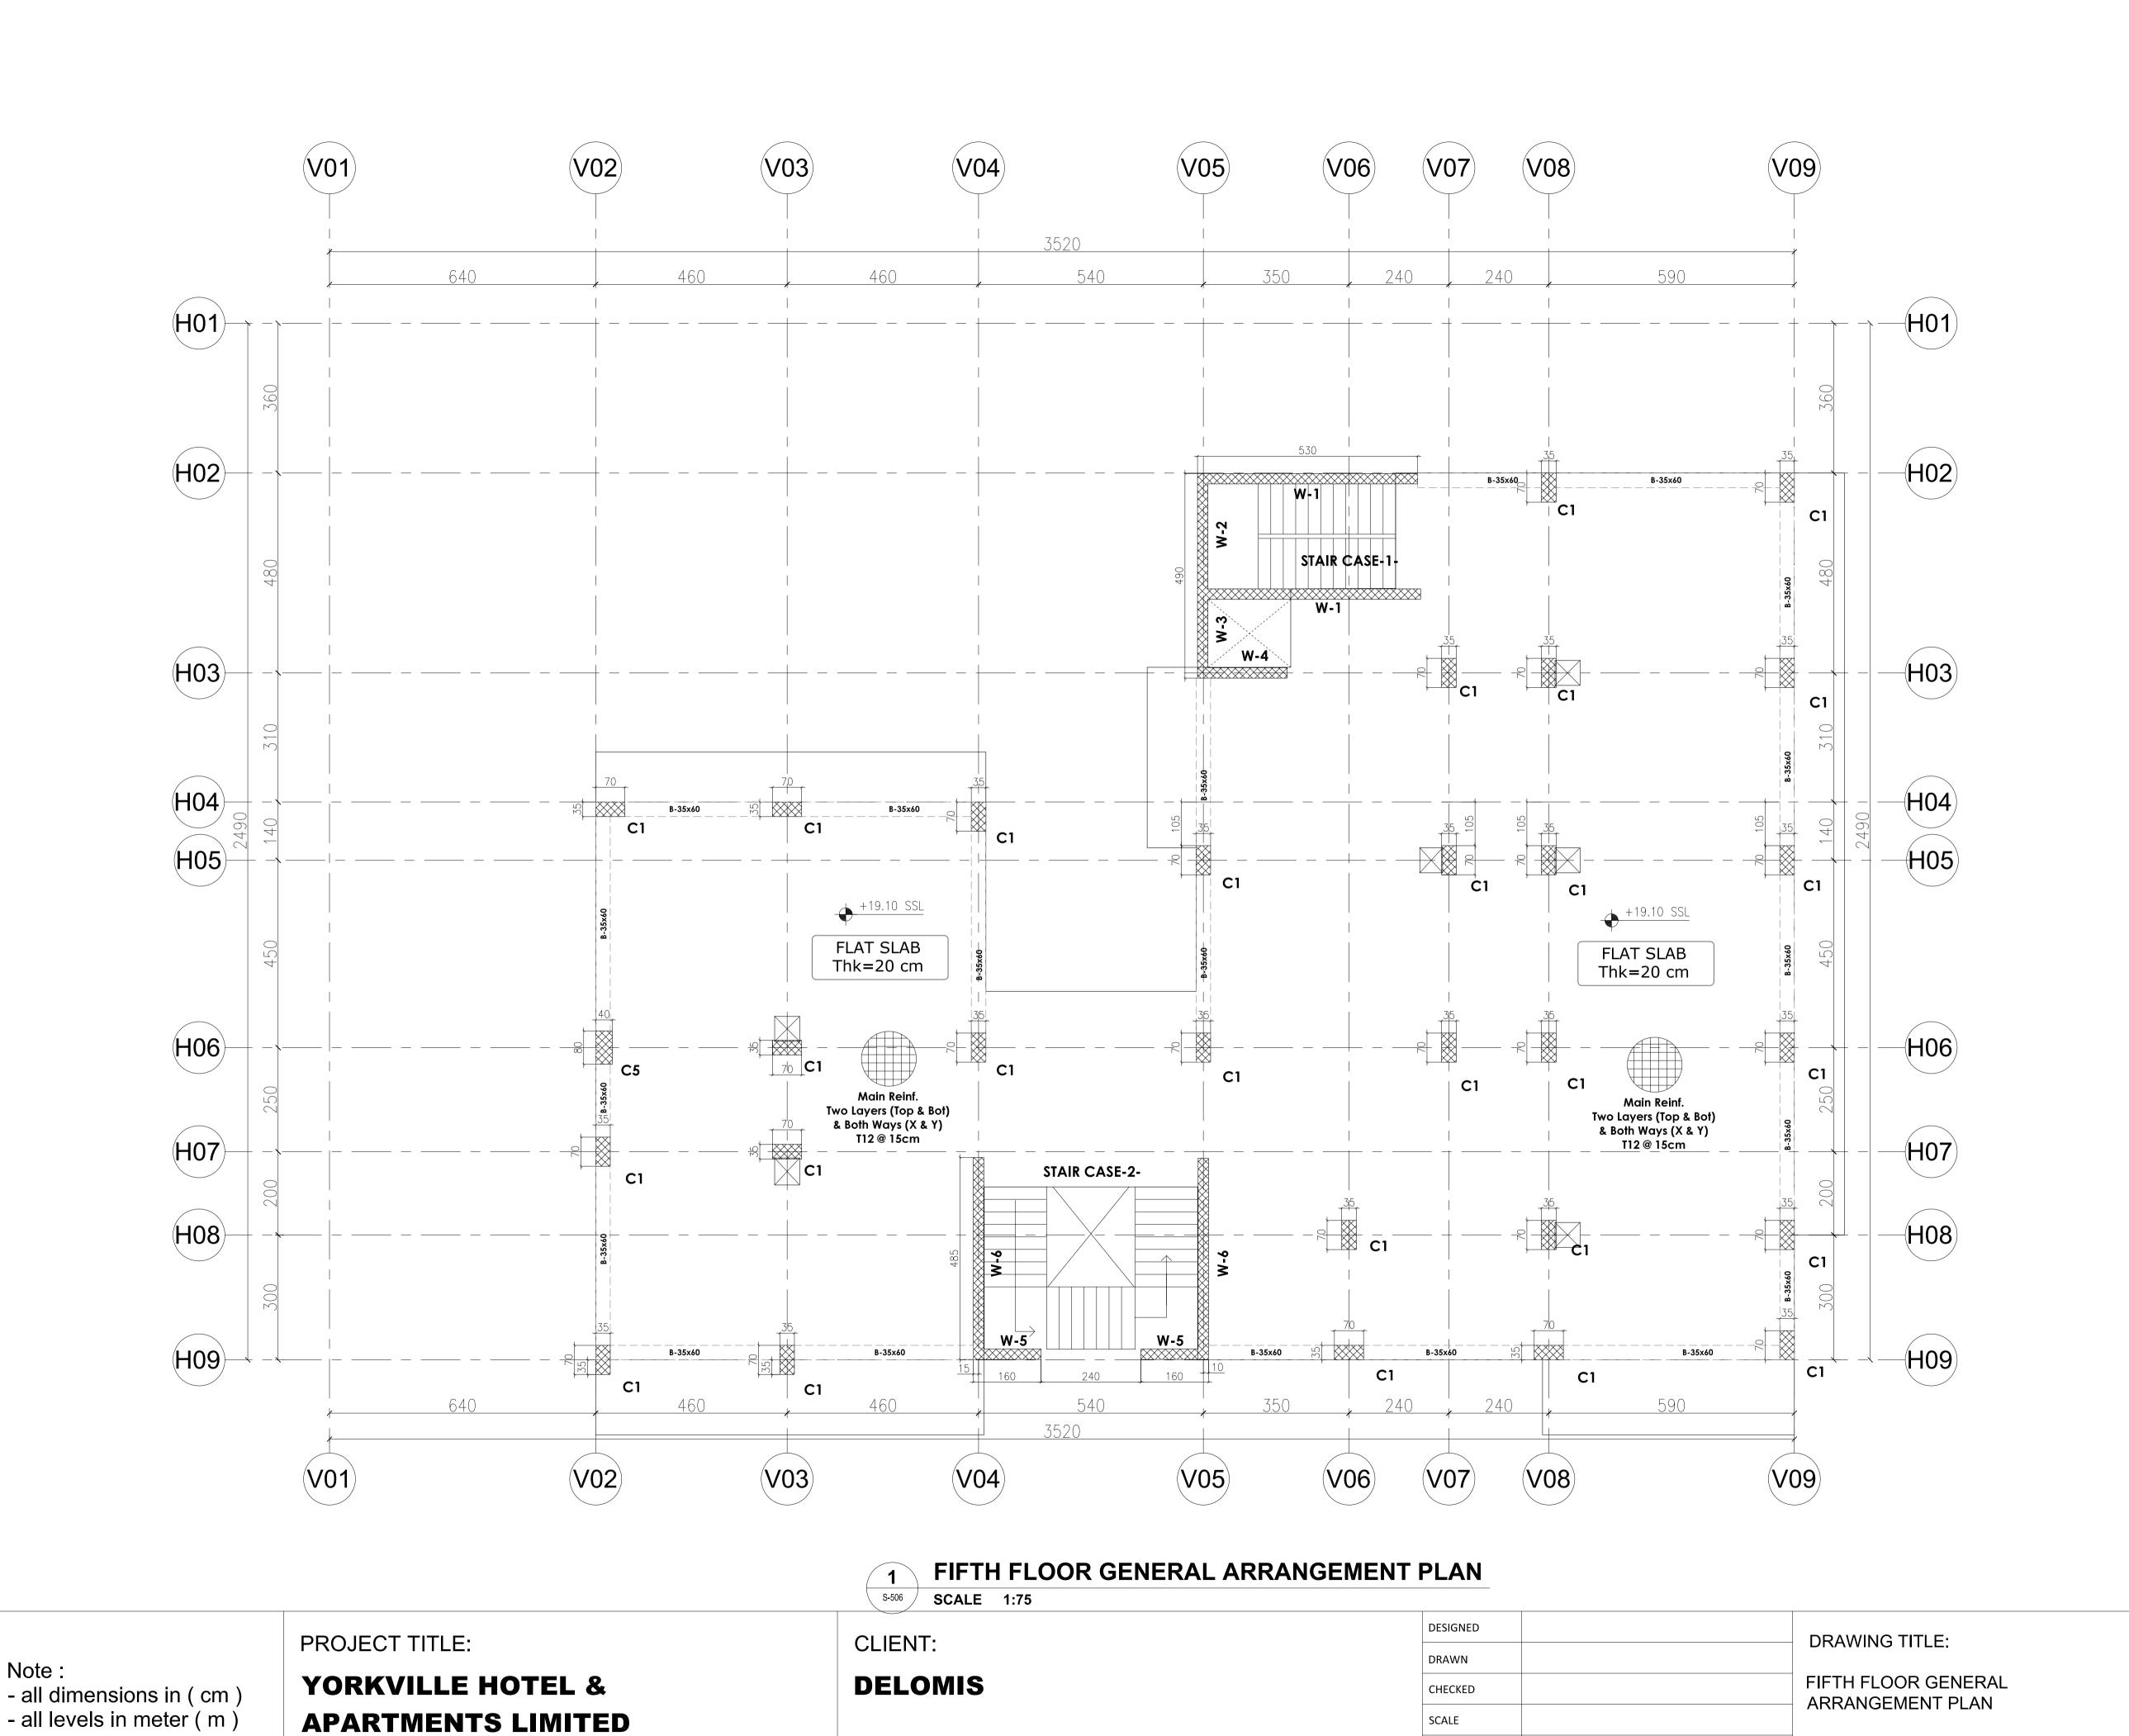

17 JAN. 2022

DATE

Note:

APPROVAL

BEAMS SCHEDULE

B 40X60

SECTION AND DETAILS

TYPE


1T8@150 L=120 TOP BOTTOM LINKS

REINFORCEMENT DETAILS 3T16 2T8@150

CONSULTANT OFFICE

Java Design Concepts LTD

SIZE: A1 DRAWING no:

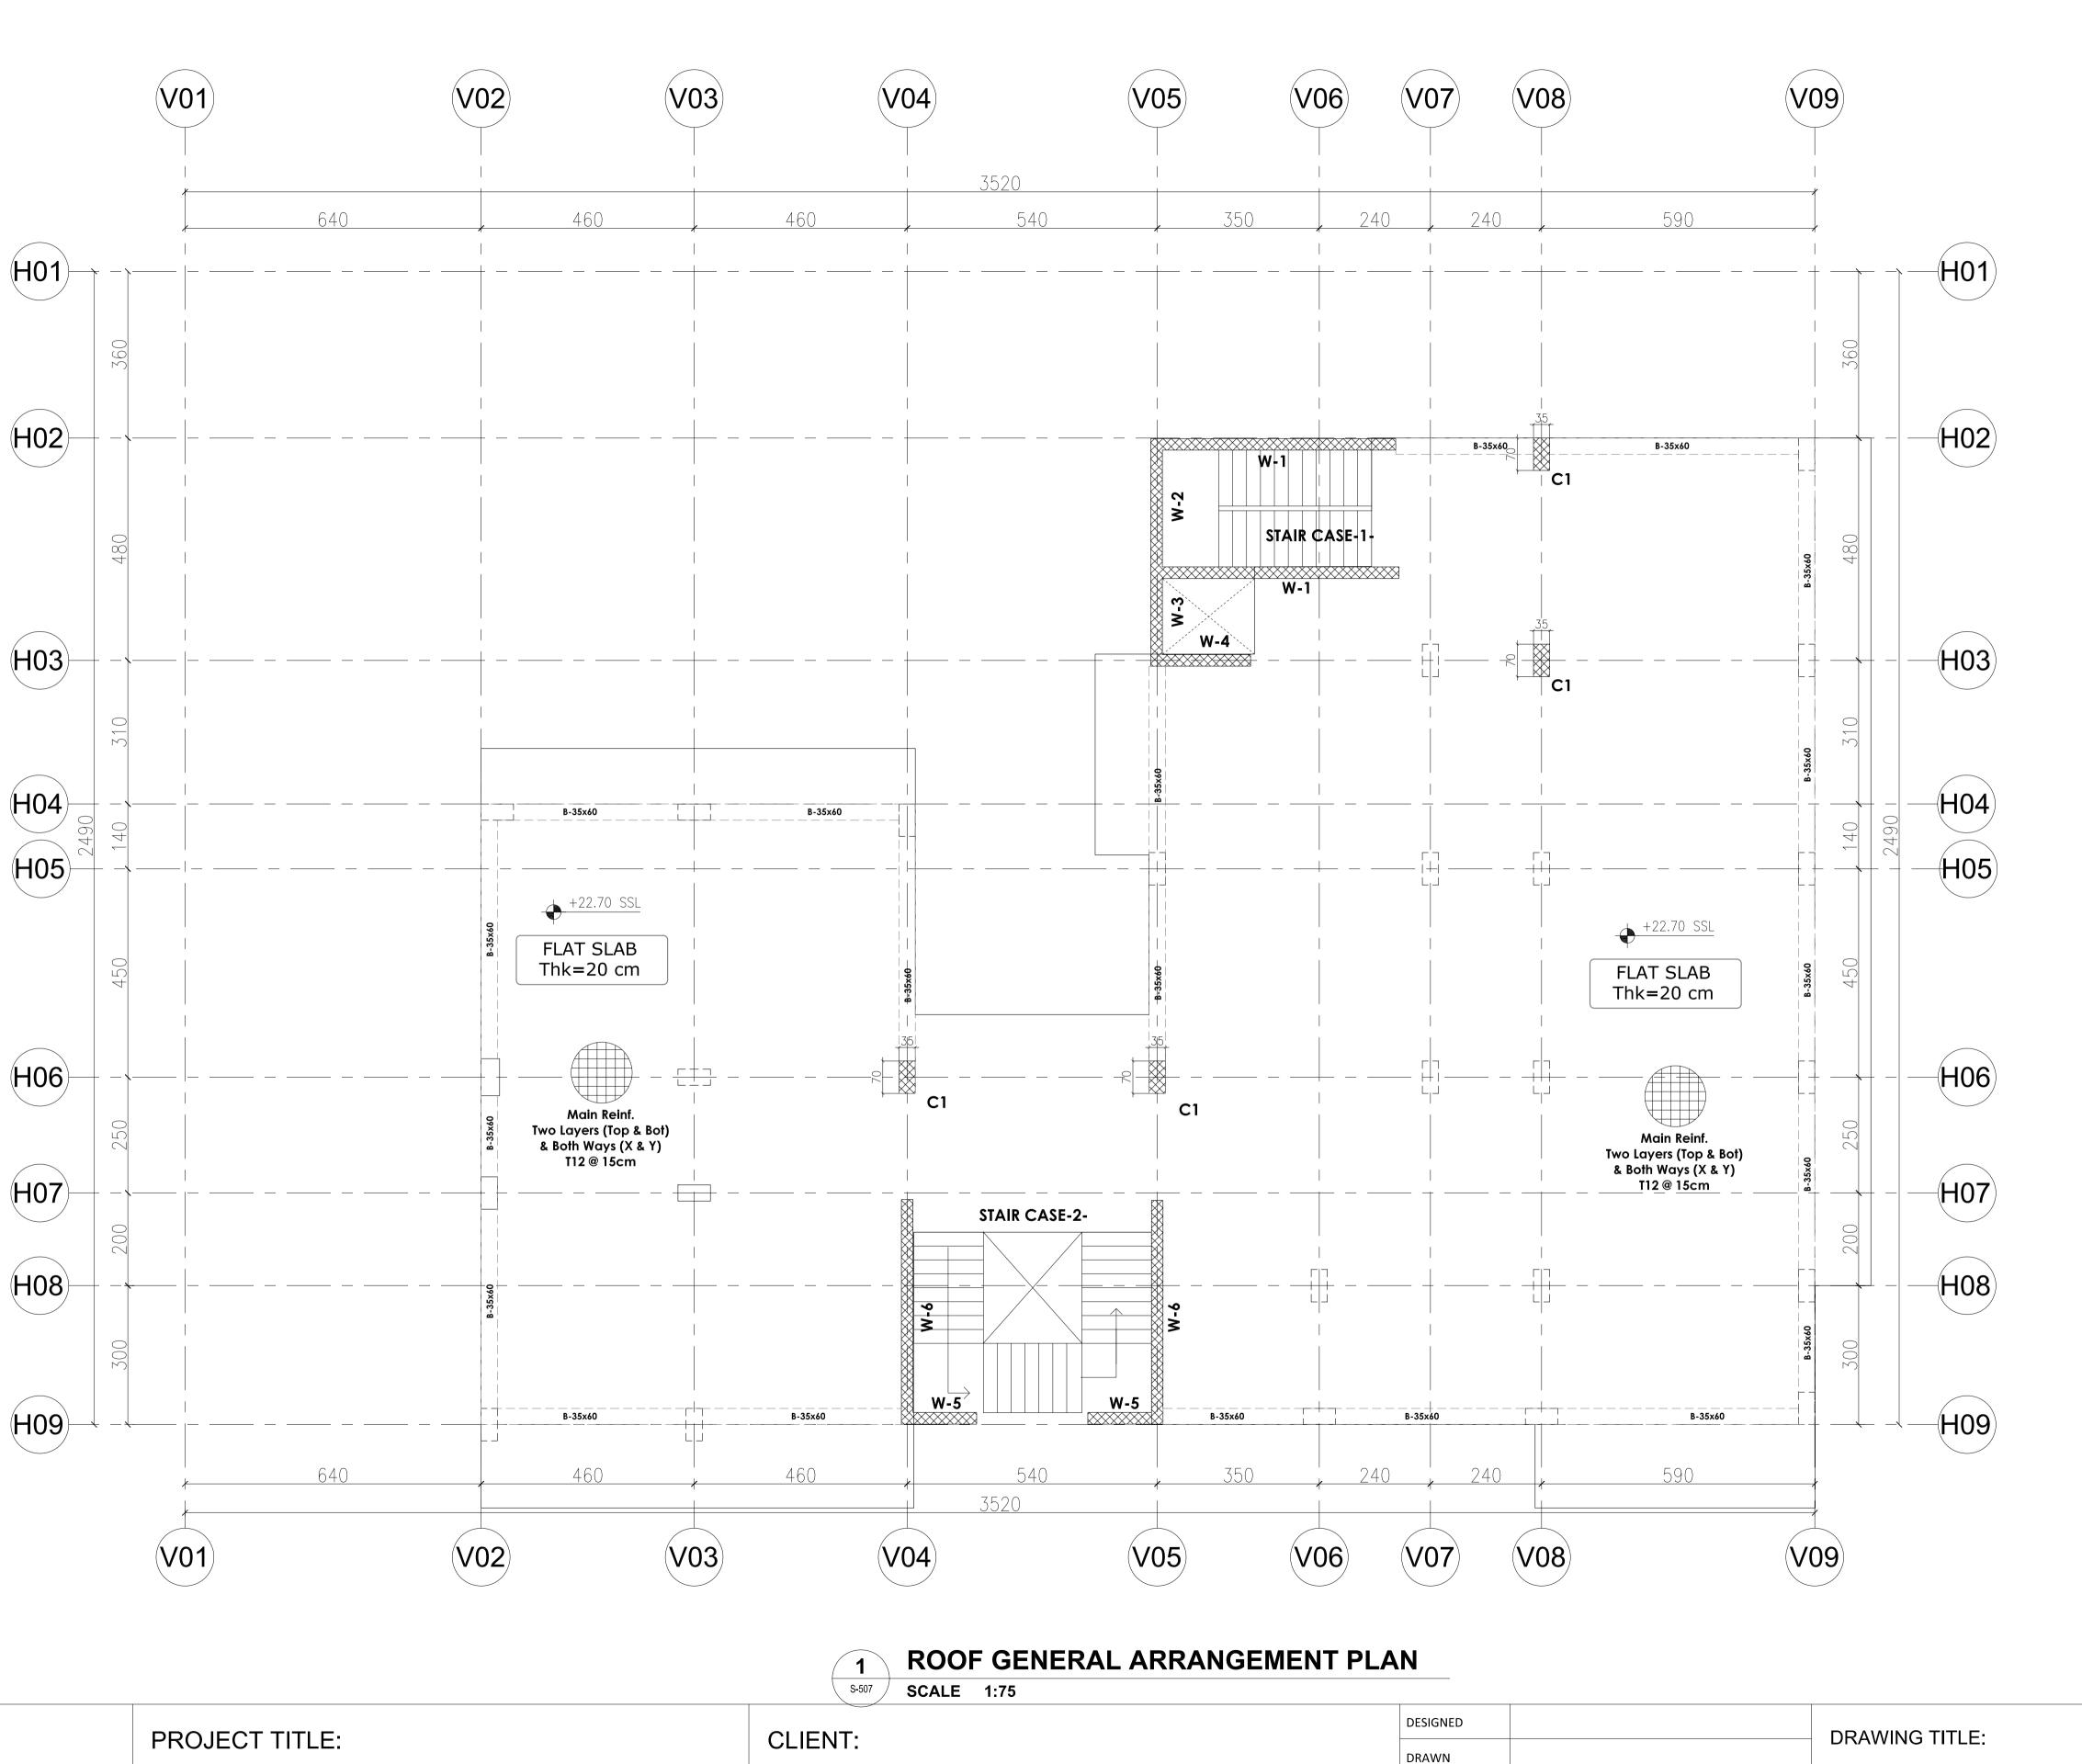

DELOMIS

Note:

- all dimensions in (cm)

- all levels in meter (m)

YORKVILLE HOTEL &

APARTMENTS LIMITED

APPROVAL

BEAMS SCHEDULE

B 40X60

SECTION AND

DETAILS

TYPE

1T8@150 L=120

TOP BOTTOM LINKS REINFORCEMENT DETAILS

2T8@150 3T16

ROOF GENERAL

ARRANGEMENT PLAN

CHECKED

17 JAN. 2022

SCALE

DATE


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Java Design Concepts



SIZE: A1 DRAWING no:

CONSULTANT OFFICE

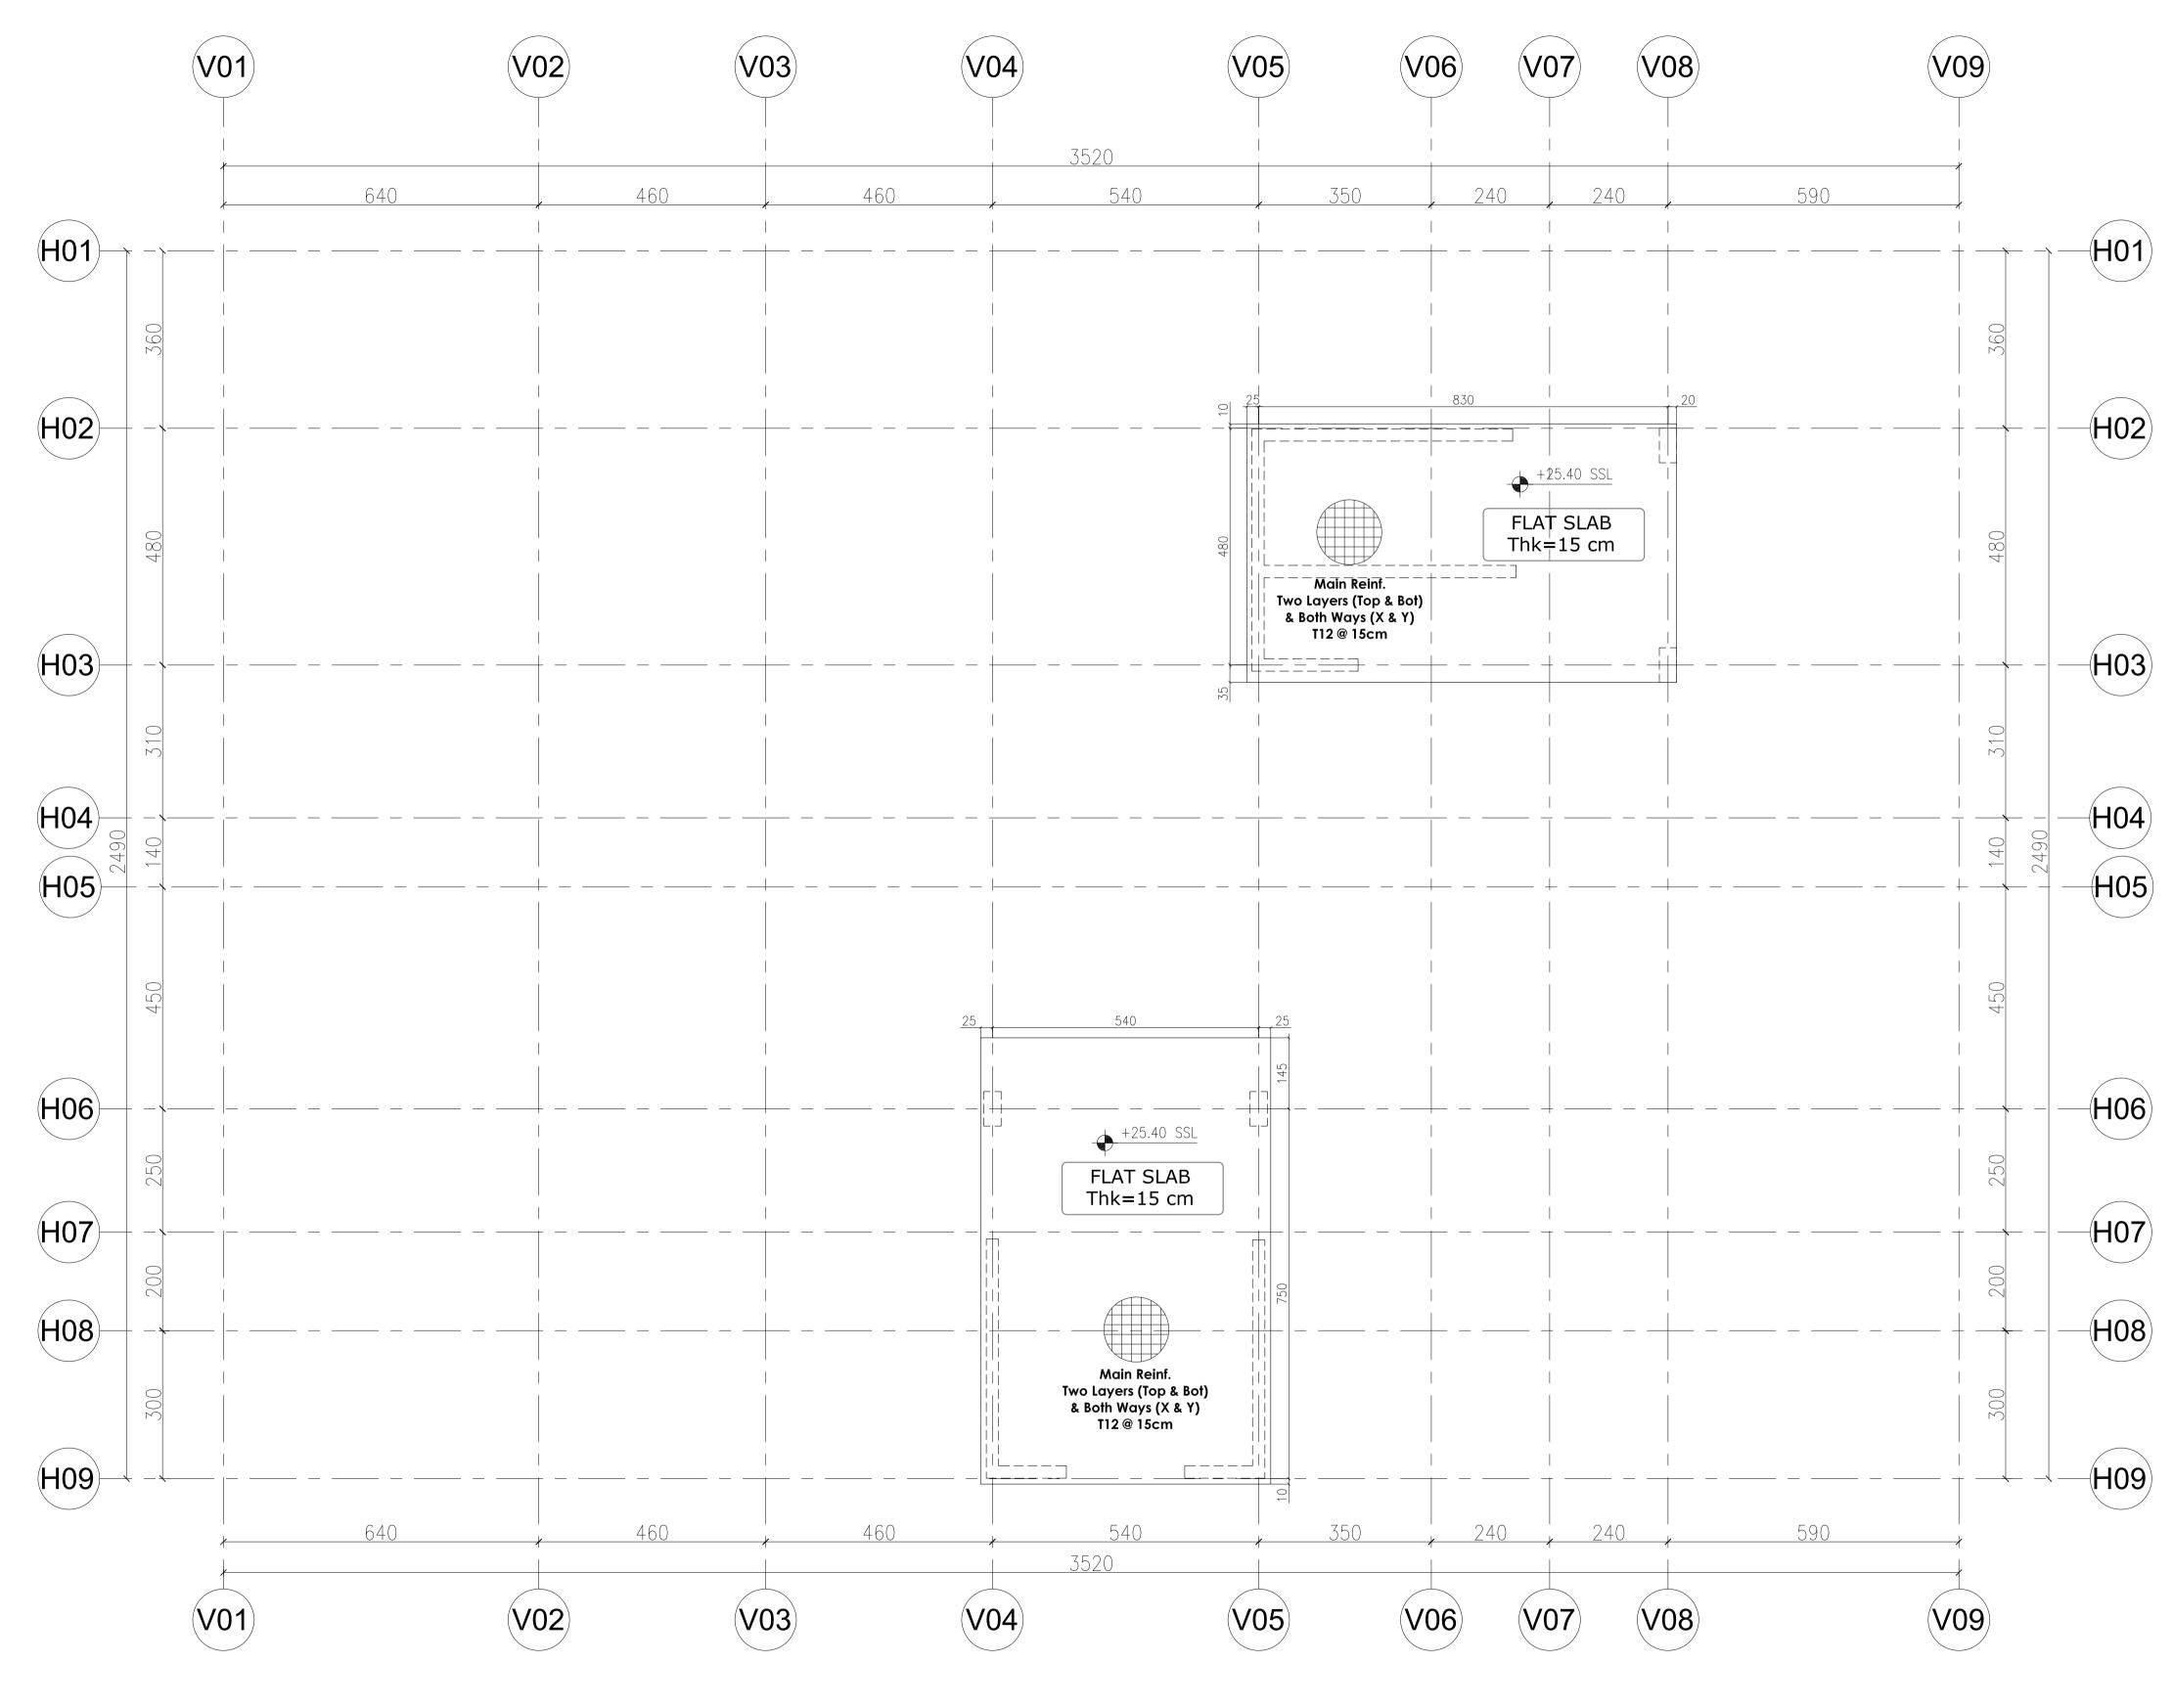

UPPER ROOF GENERAL ARRANGEMENT PLAN SCALE 1:75

Note: - all dimensions in (cm)

- all levels in meter (m)

YORKVILLE HOTEL & **APARTMENTS LIMITED**

PROJECT TITLE:


CLIENT: **DELOMIS** DESIGNED DRAWN CHECKED SCALE 17 JAN. 2022

DRAWING TITLE: UPPER ROOF GENERAL ARRANGEMENT PLAN

CONSULTANT OFFICE Java Design Concepts LTD



SIZE: A1 DRAWING no:

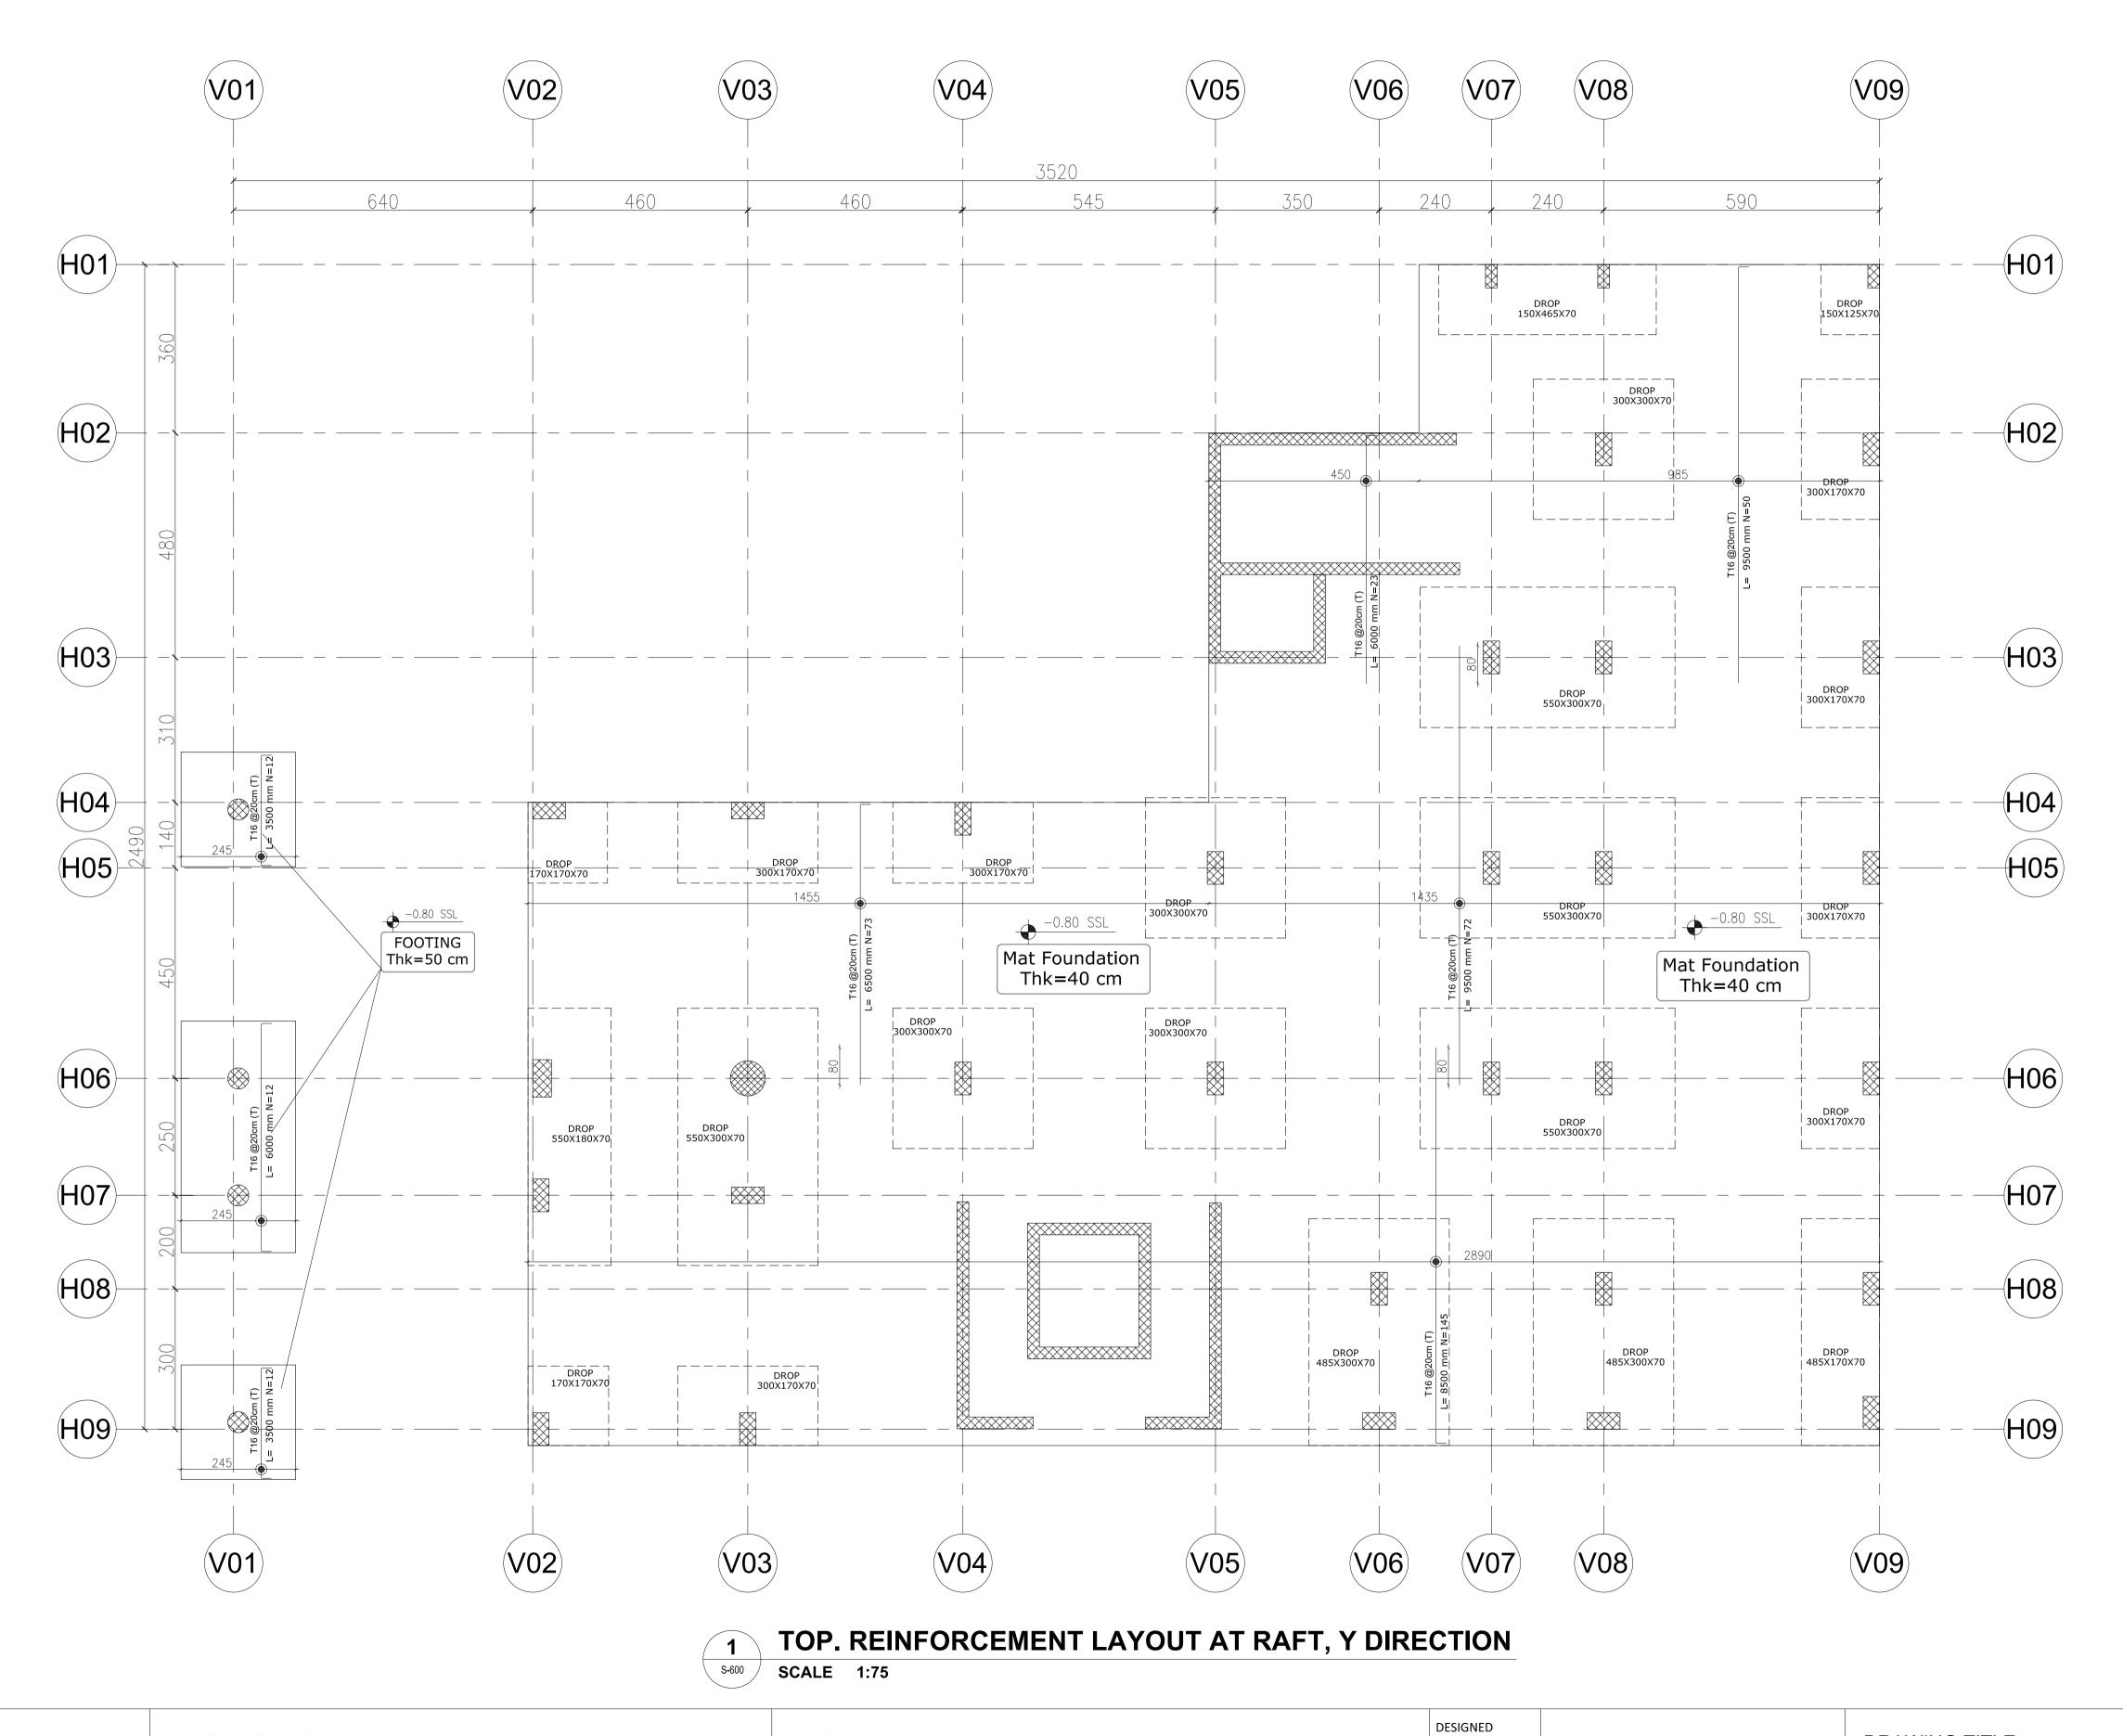

- all dimensions in (cm) - all levels in meter (m)

PROJECT TITLE:

YORKVILLE HOTEL & **APARTMENTS LIMITED** CLIENT: **DELOMIS**

DRAWN CHECKED SCALE 17 JAN. 2022 DATE


DRAWING TITLE:

TOP. REINFORCEMENT LAYOUT AT RAFT, Y DIRECTION

CONSULTANT OFFICE Java Design Concepts LTD

SIZE: A1

DRAWING no:

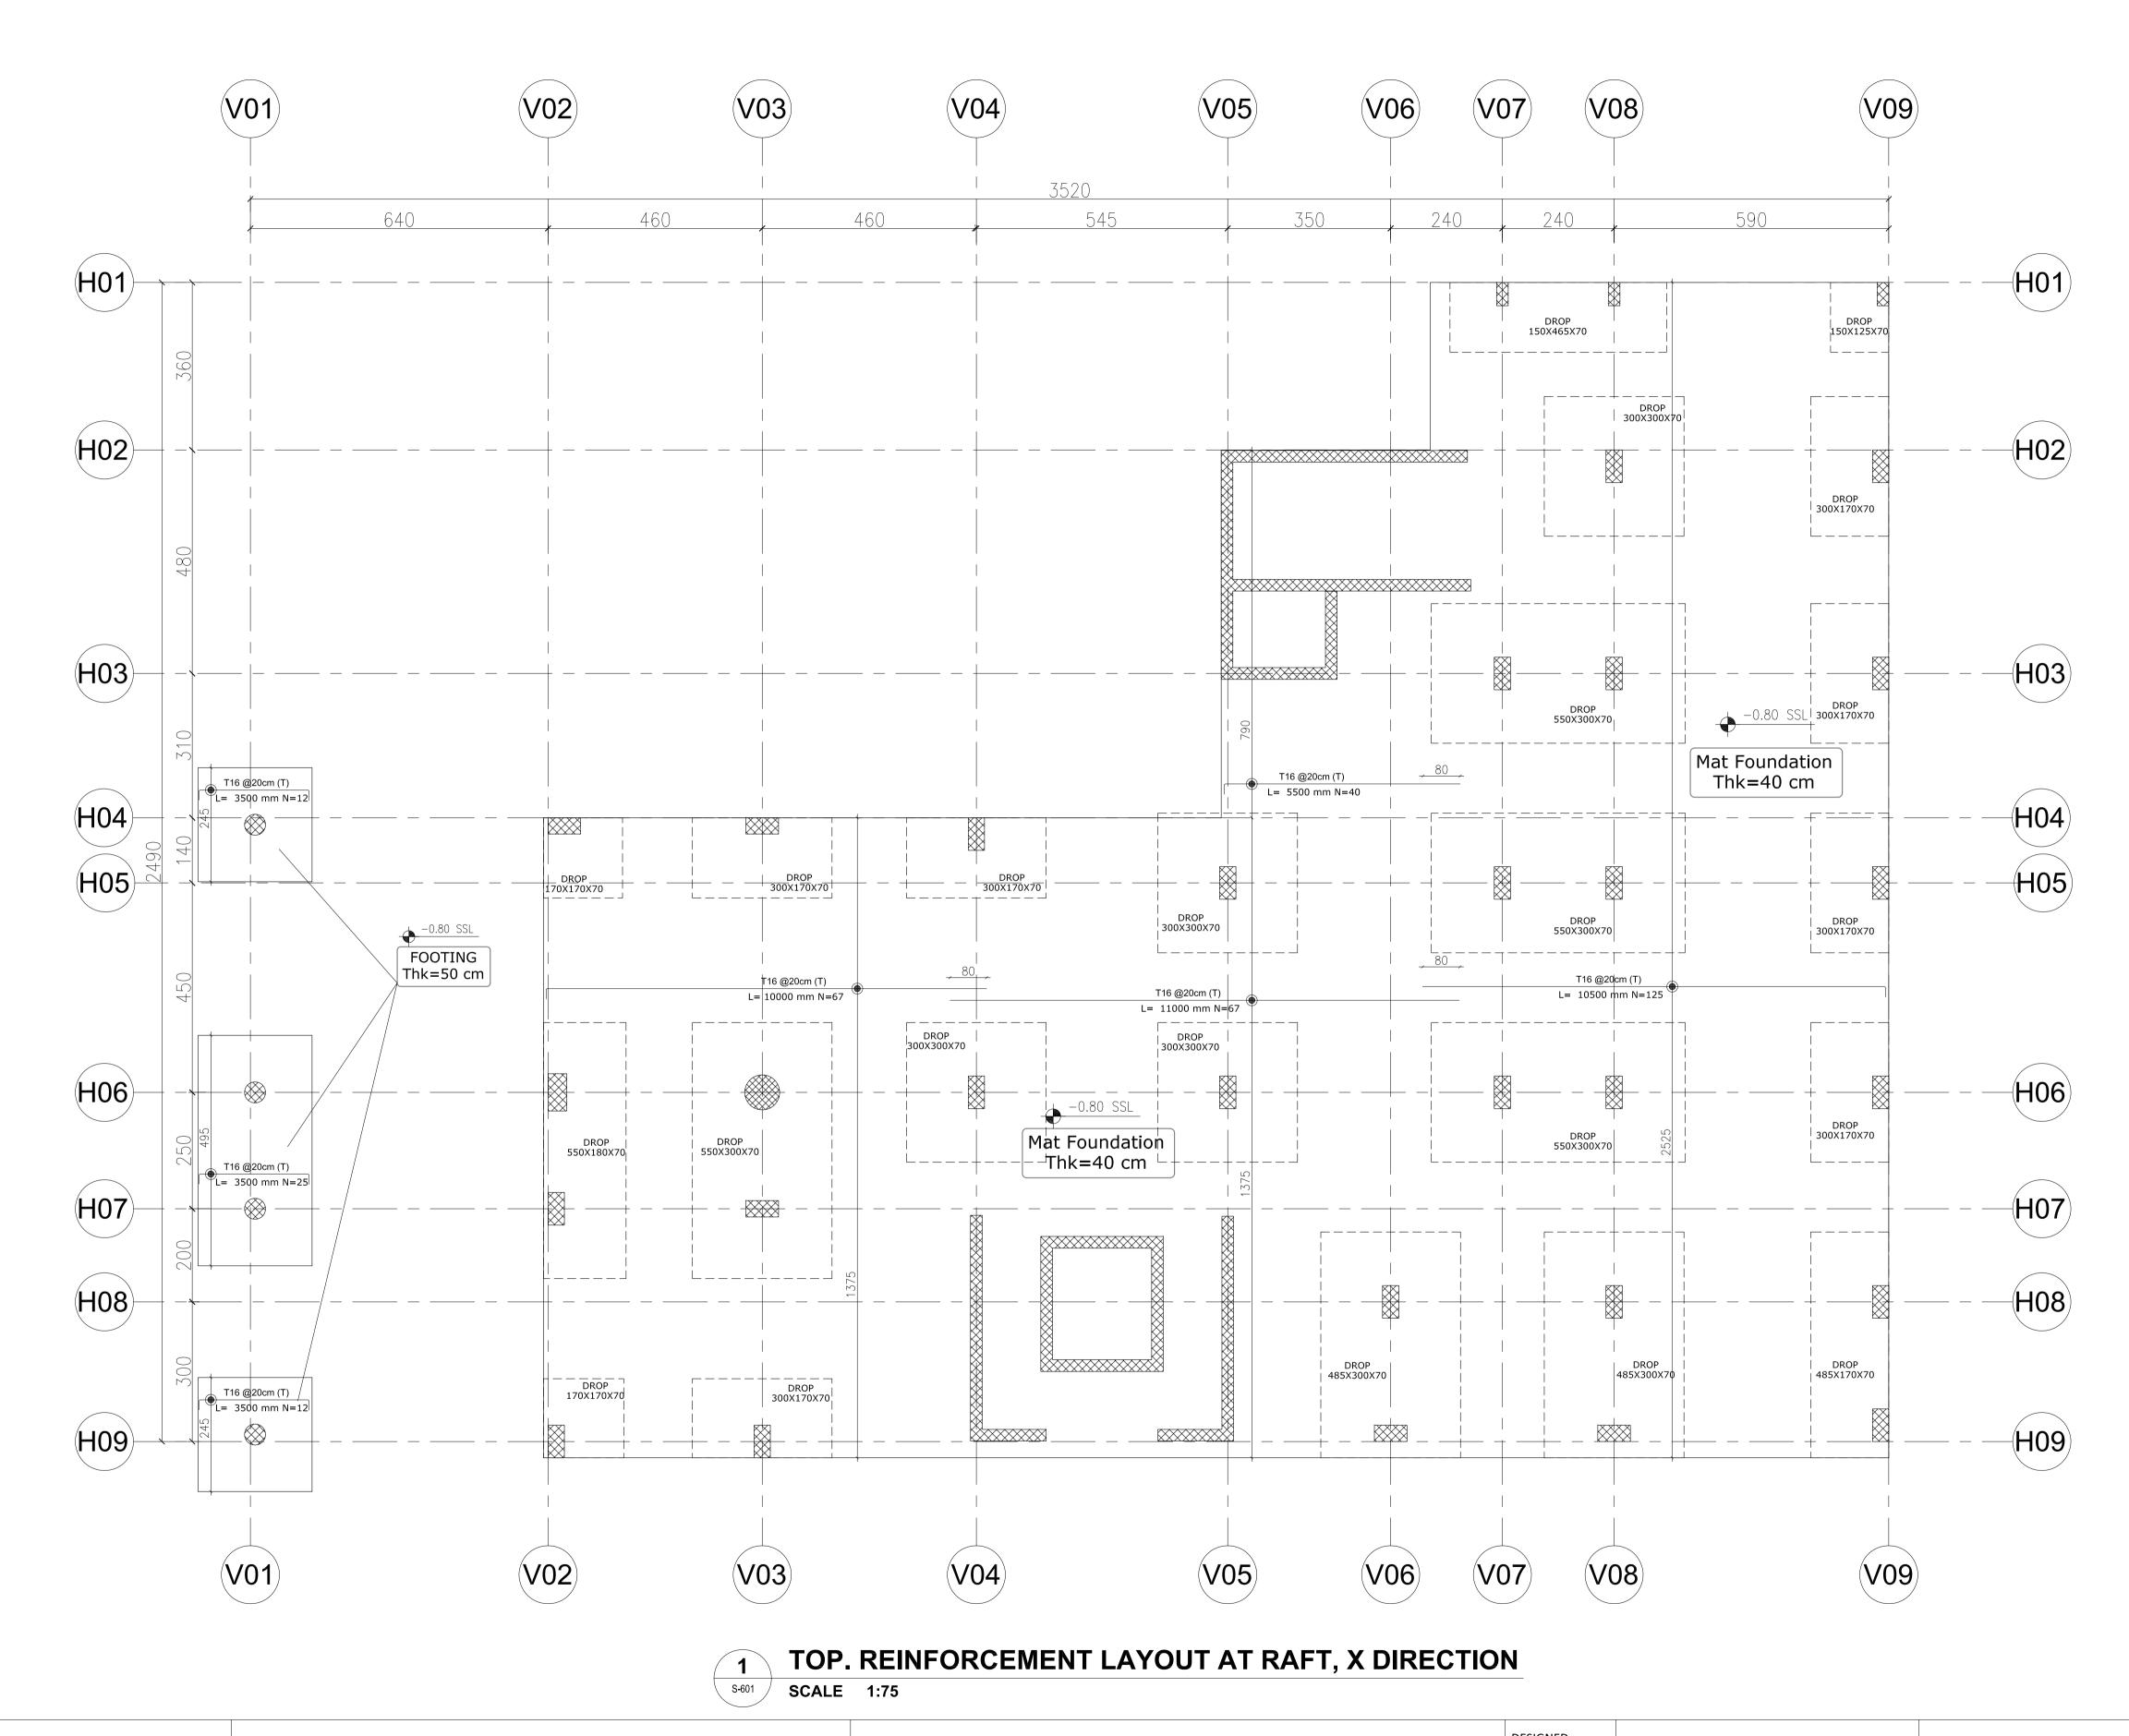

- all dimensions in (cm) - all levels in meter (m)

PROJECT TITLE:

YORKVILLE HOTEL & **APARTMENTS LIMITED** CLIENT:

DELOMIS

DESIGNED DRAWN CHECKED SCALE 17 JAN. 2022 DATE

DRAWING TITLE:


TOP. REINFORCEMENT LAYOUT AT RAFT, X DIRECTION

Java Design Concepts LTD

CONSULTANT OFFICE

SIZE: A1

DRAWING no:

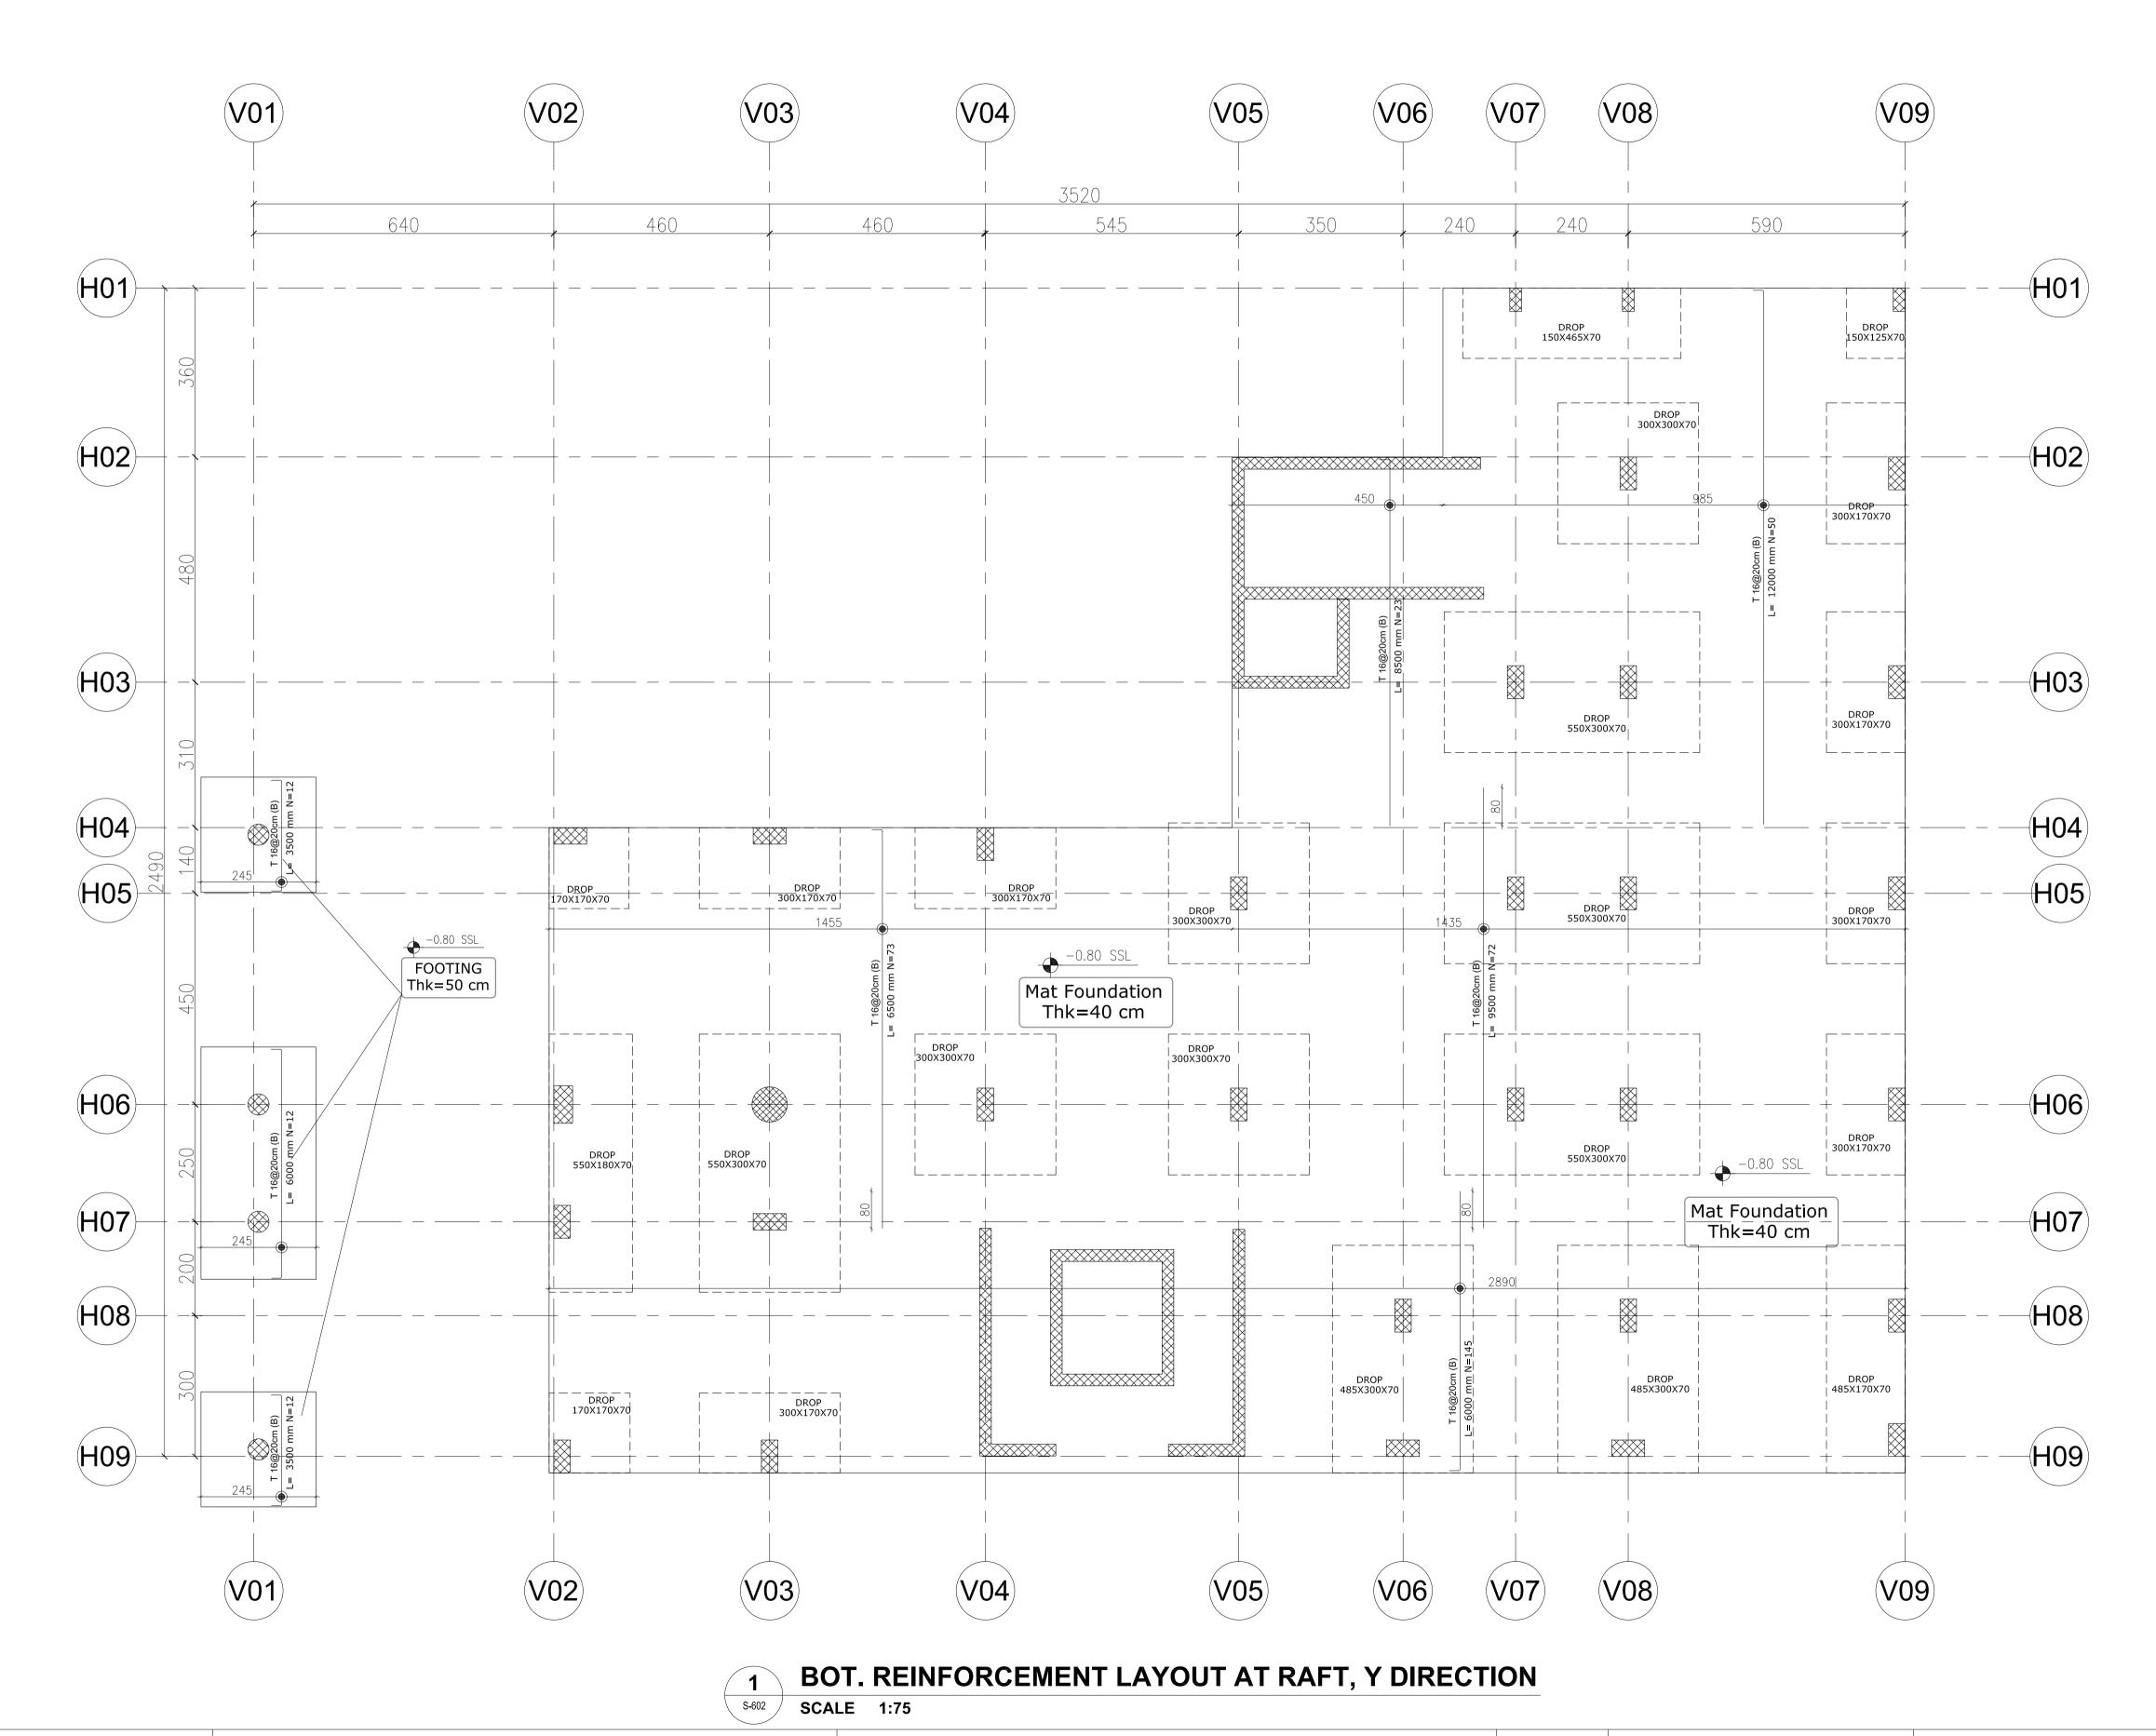

all dimensions in (cm)all levels in meter (m)

YORKVILLE HOTEL & APARTMENTS LIMITED

PROJECT TITLE:

CLIENT: **DELOMIS**

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DRAWN

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SCALE

DATE

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DRAWING TITLE:

BOT. REINFORCEMENT LAYOUT AT RAFT, Y DIRECTION CONSULTANT OFFICE

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SIZE: A1 DRAWING no:



- all dimensions in (cm)
- all levels in meter (m)

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APARTMENTS LIMITED

PROJECT TITLE:
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DELOMIS

CLIENT:

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SCALE

DATE

17 JAN. 2022

DRAWING TITLE:
BOT. REINFORCEMENT
LAYOUT AT RAFT, X
DIRECTION

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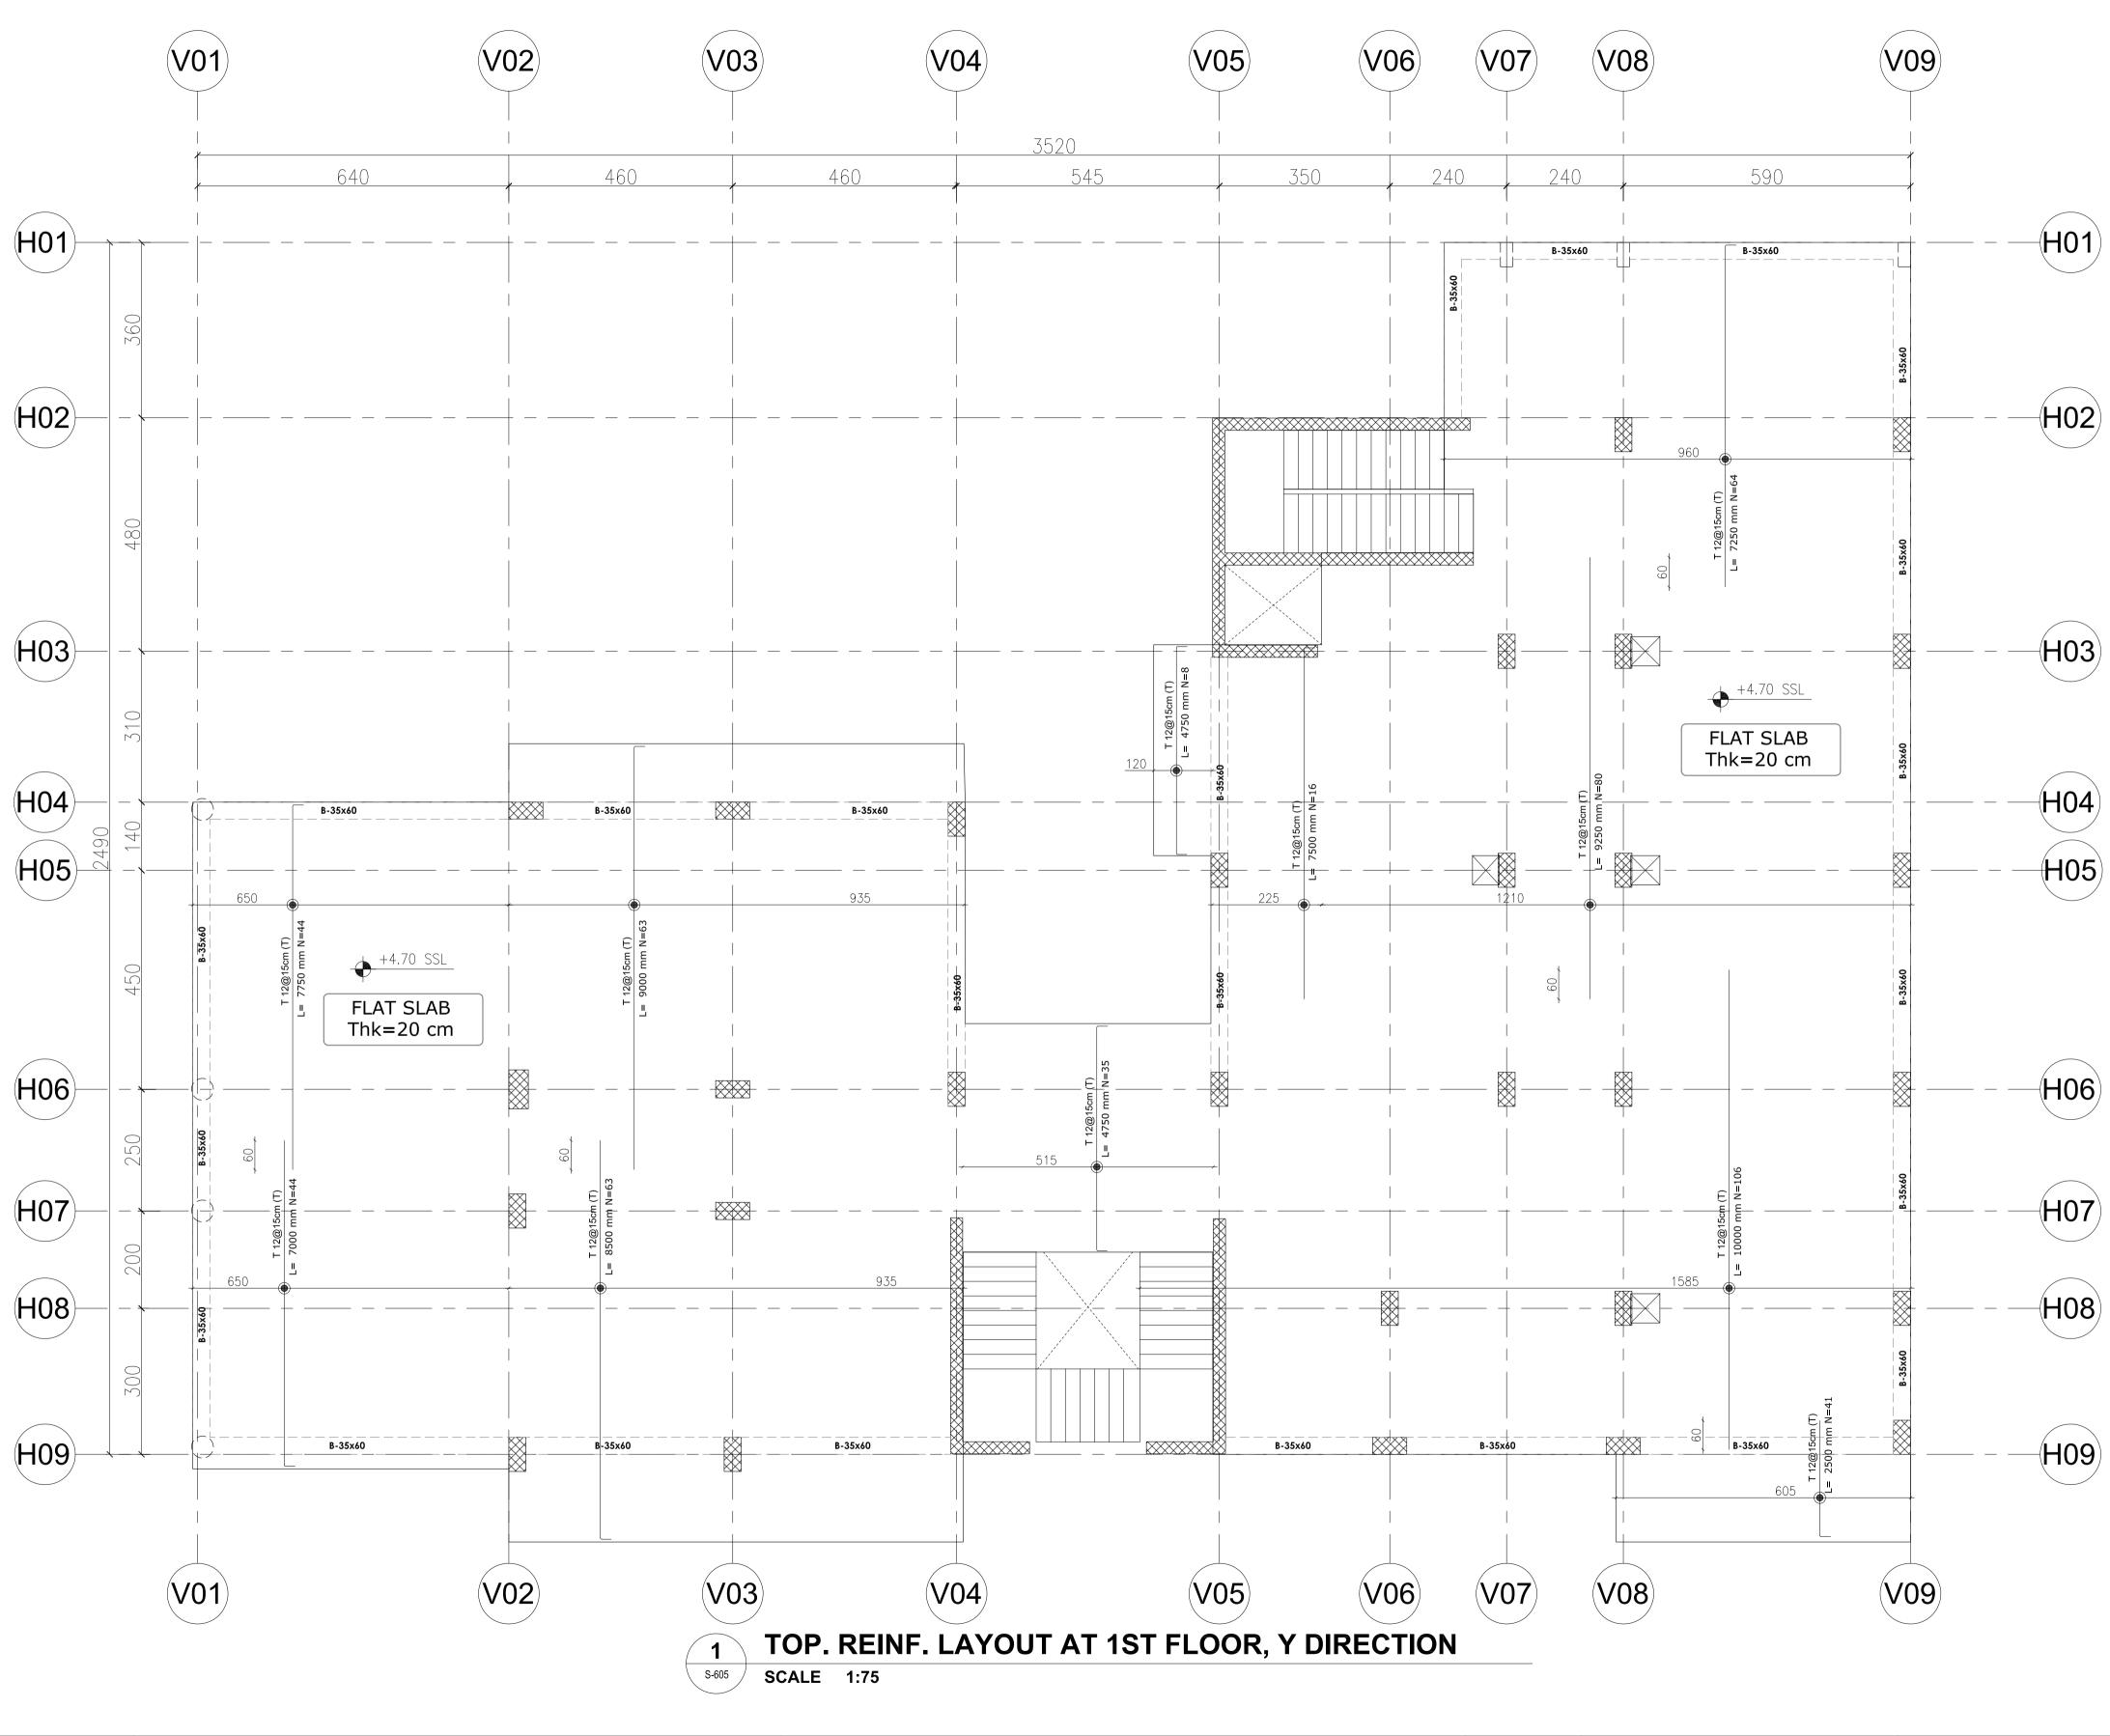


SIZE: A1 DRAWING no:



17 JAN. 2022

SIZE: A1 DRAWING no:



all dimensions in (cm)all levels in meter (m)

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YORKVILLE HOTEL & APARTMENTS LIMITED

PROJECT TITLE:

CLIENT:

DELOMIS

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SCALE

DATE

17 JAN. 2022

DRAWING TITLE:


TOP. REINF. LAYOUT AT 1ST FLOOR, Y DIRECTION CONSULTANT OFFICE

Java Design Concepts

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SIZE: A1 DRAWING no:



- all dimensions in (cm)

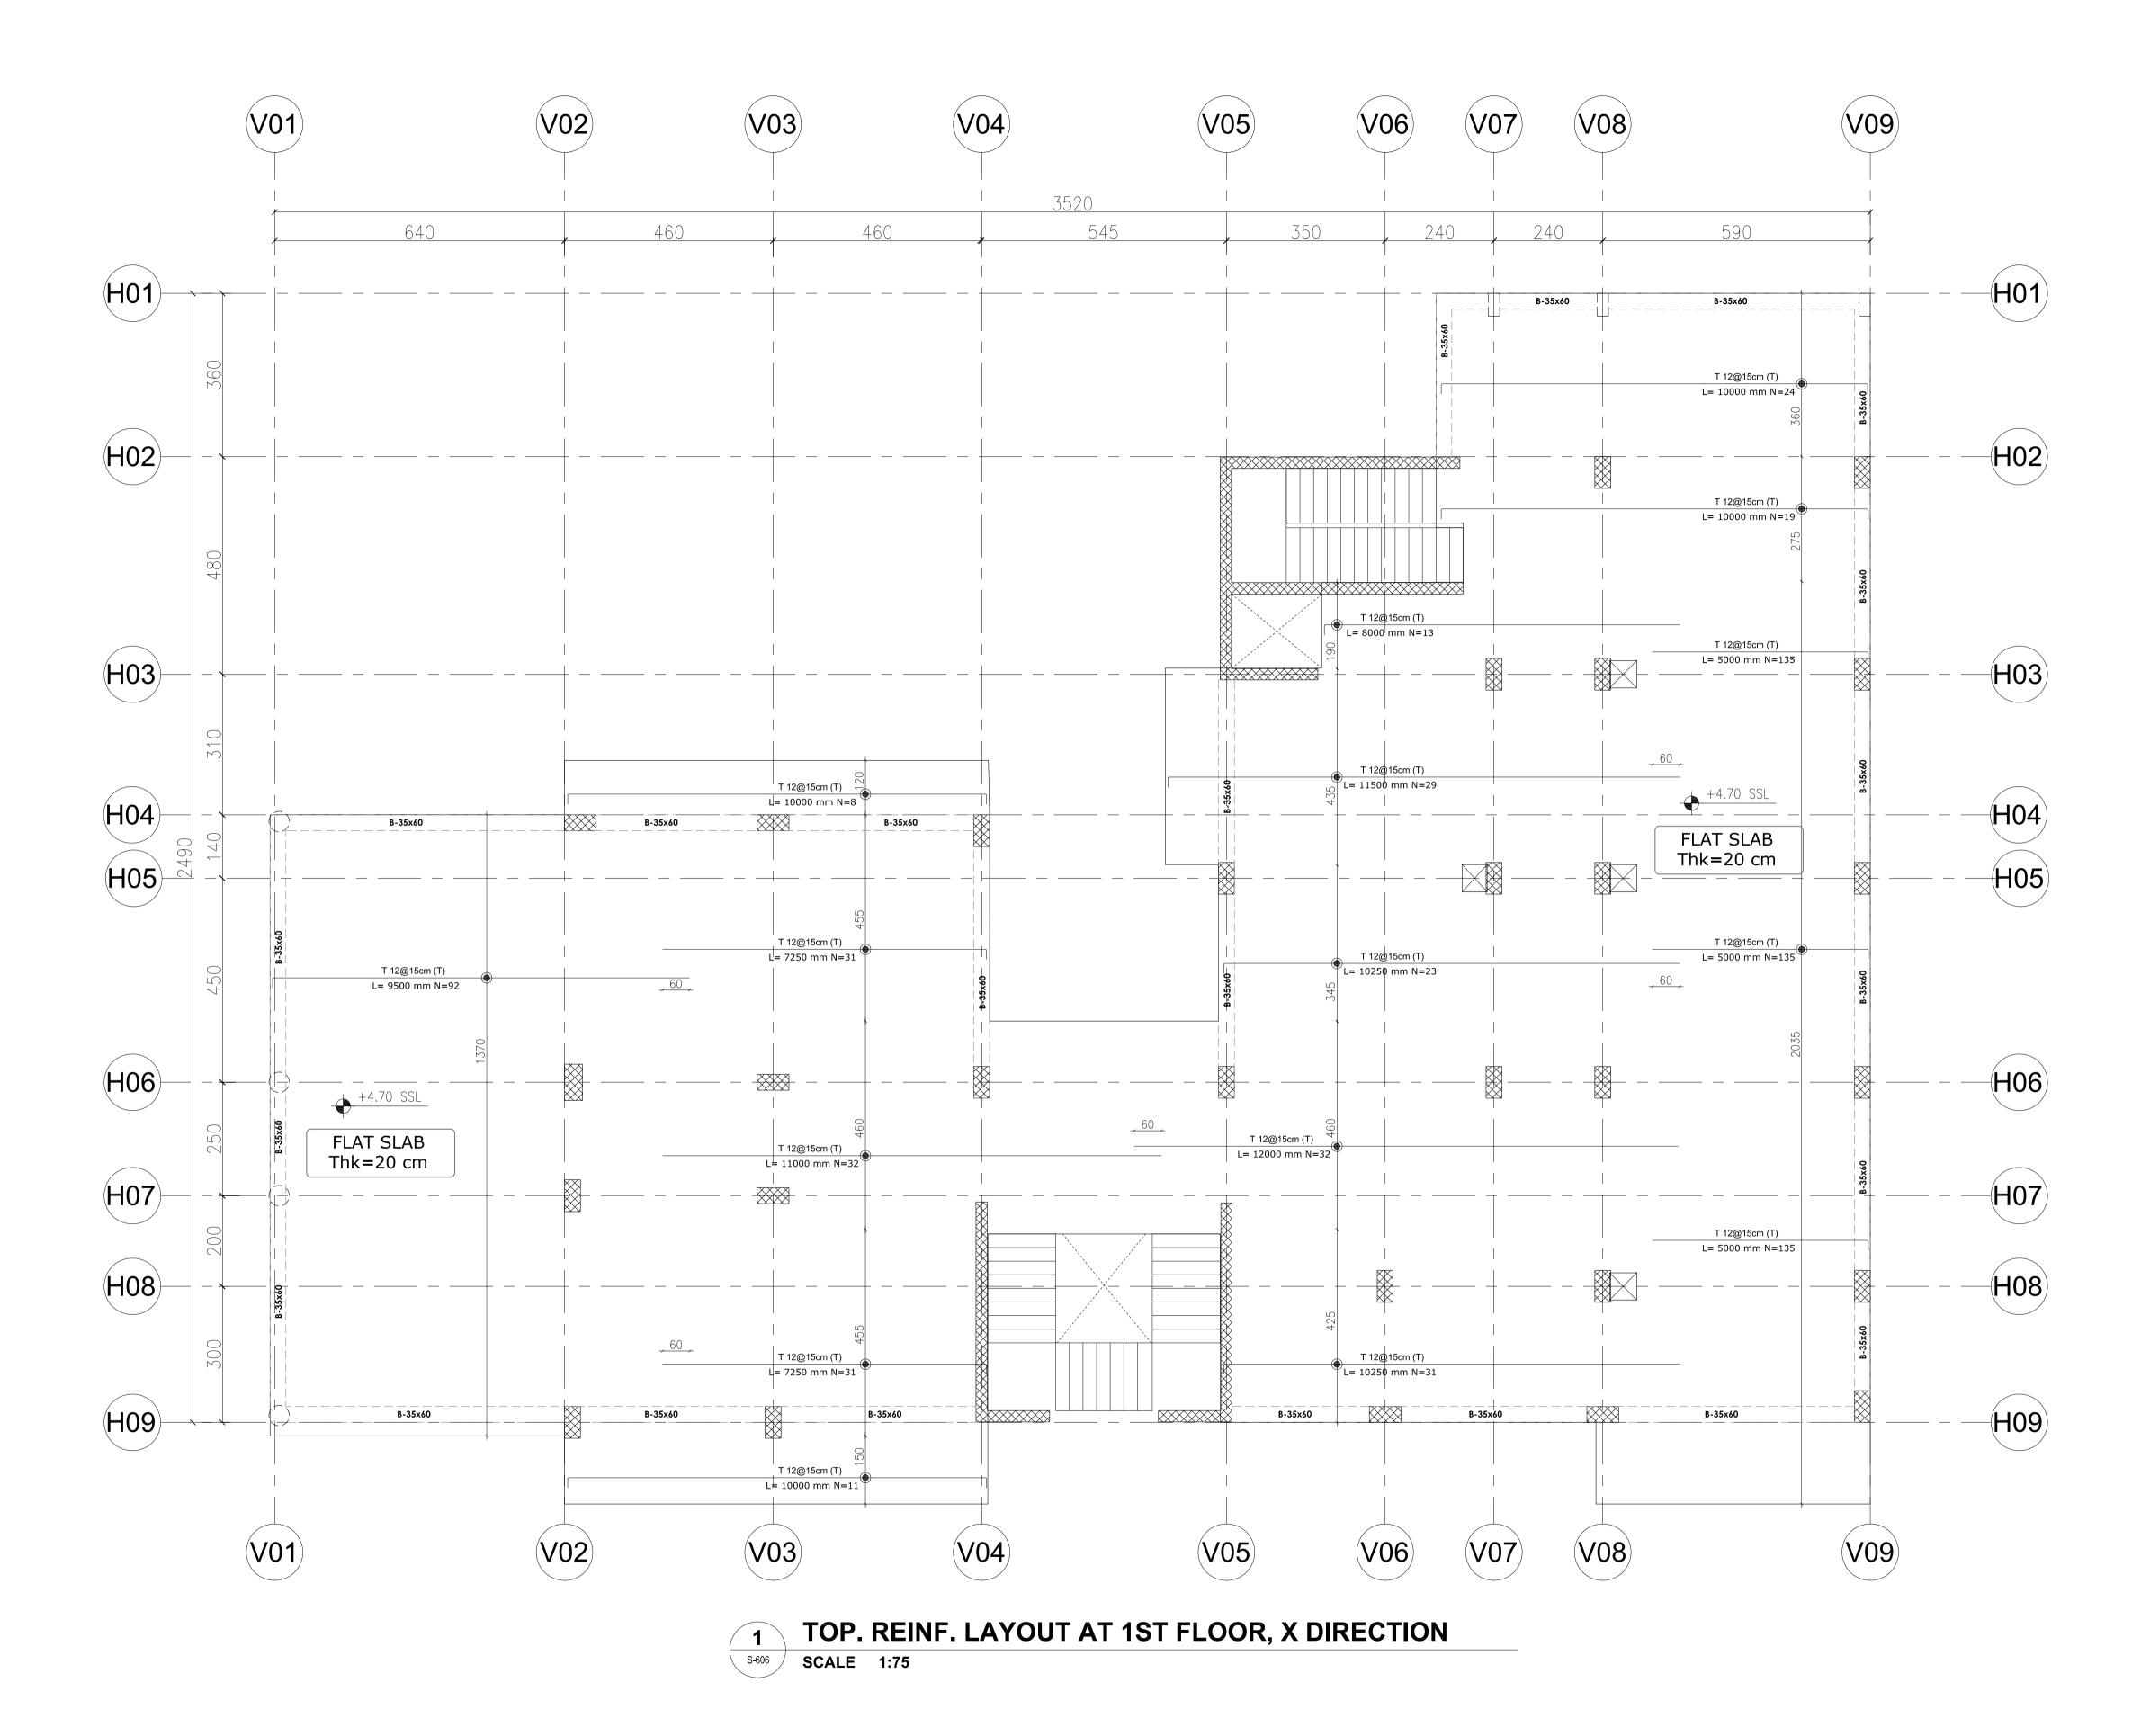- all levels in meter (m)

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PROJECT TITLE:

CLIENT:

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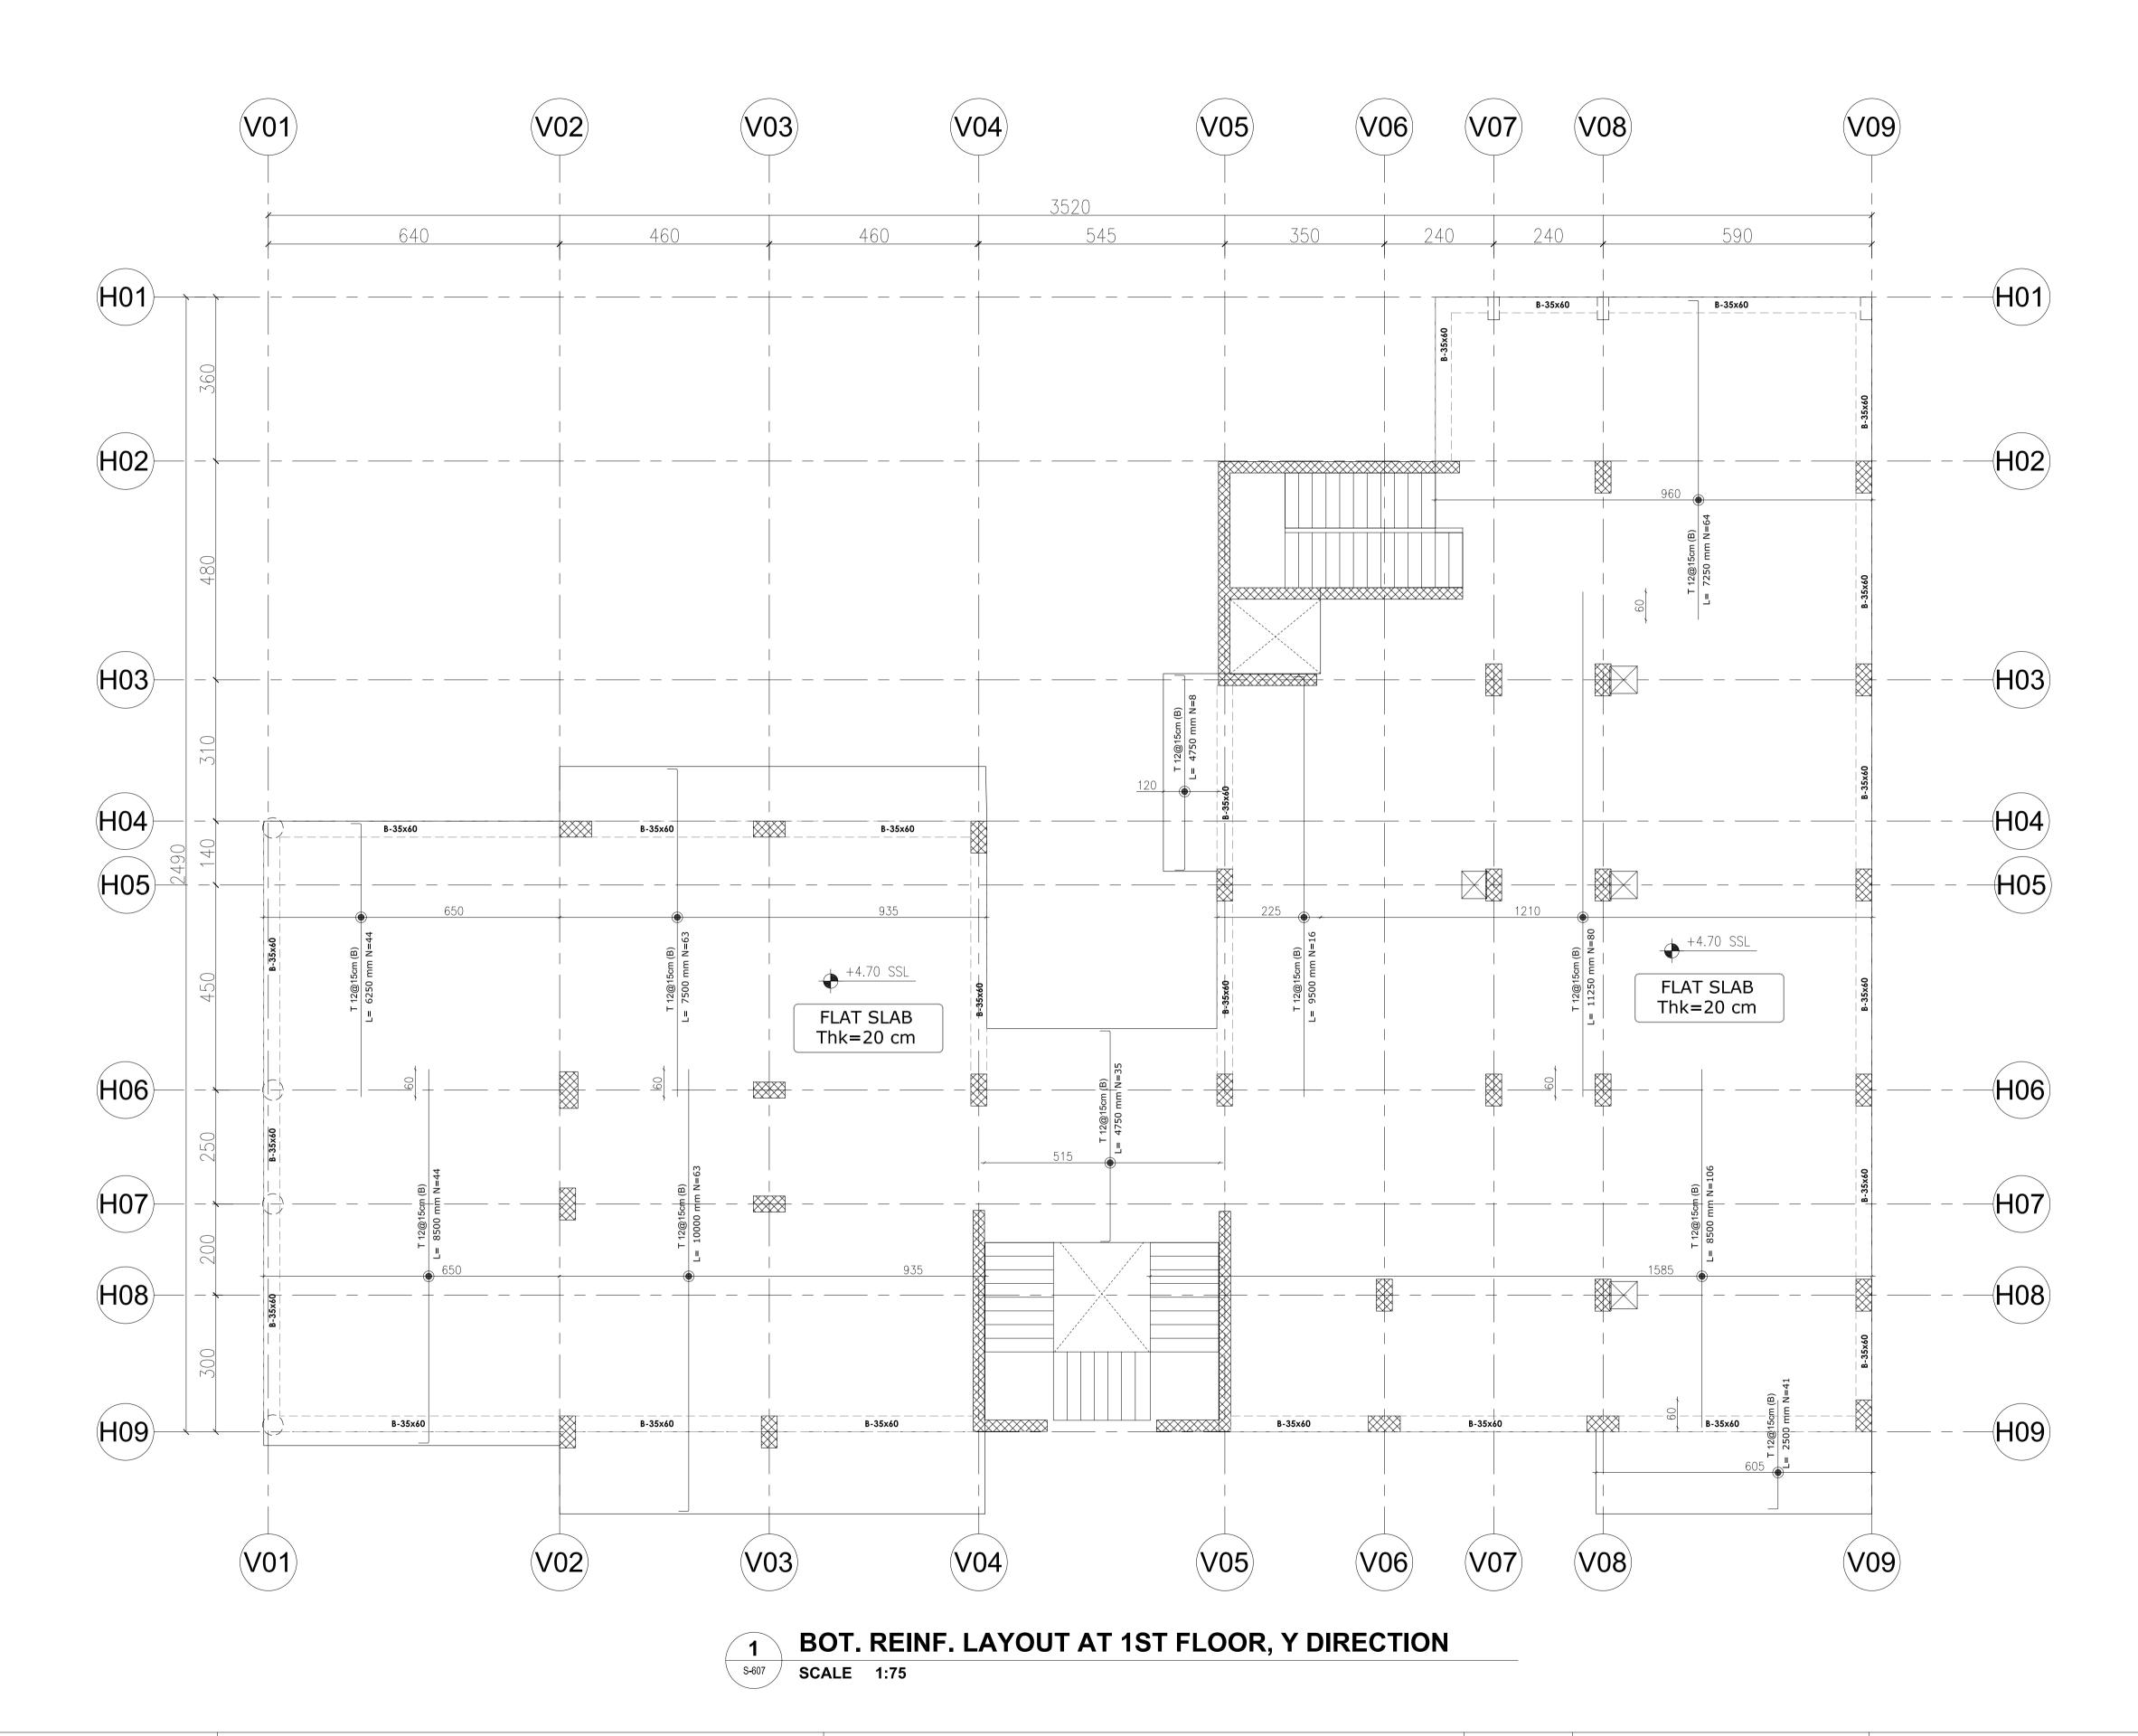
DESIGNED DRAWN CHECKED SCALE 17 JAN. 2022 DATE

DRAWING TITLE: TOP. REINF. LAYOUT AT 1ST FLOOR, X DIRECTION

CONSULTANT OFFICE Java Design Concepts LTD



SIZE: A1 DRAWING no:



- all dimensions in (cm)

- all levels in meter (m)

PROJECT TITLE:

YORKVILLE HOTEL & **APARTMENTS LIMITED** CLIENT:

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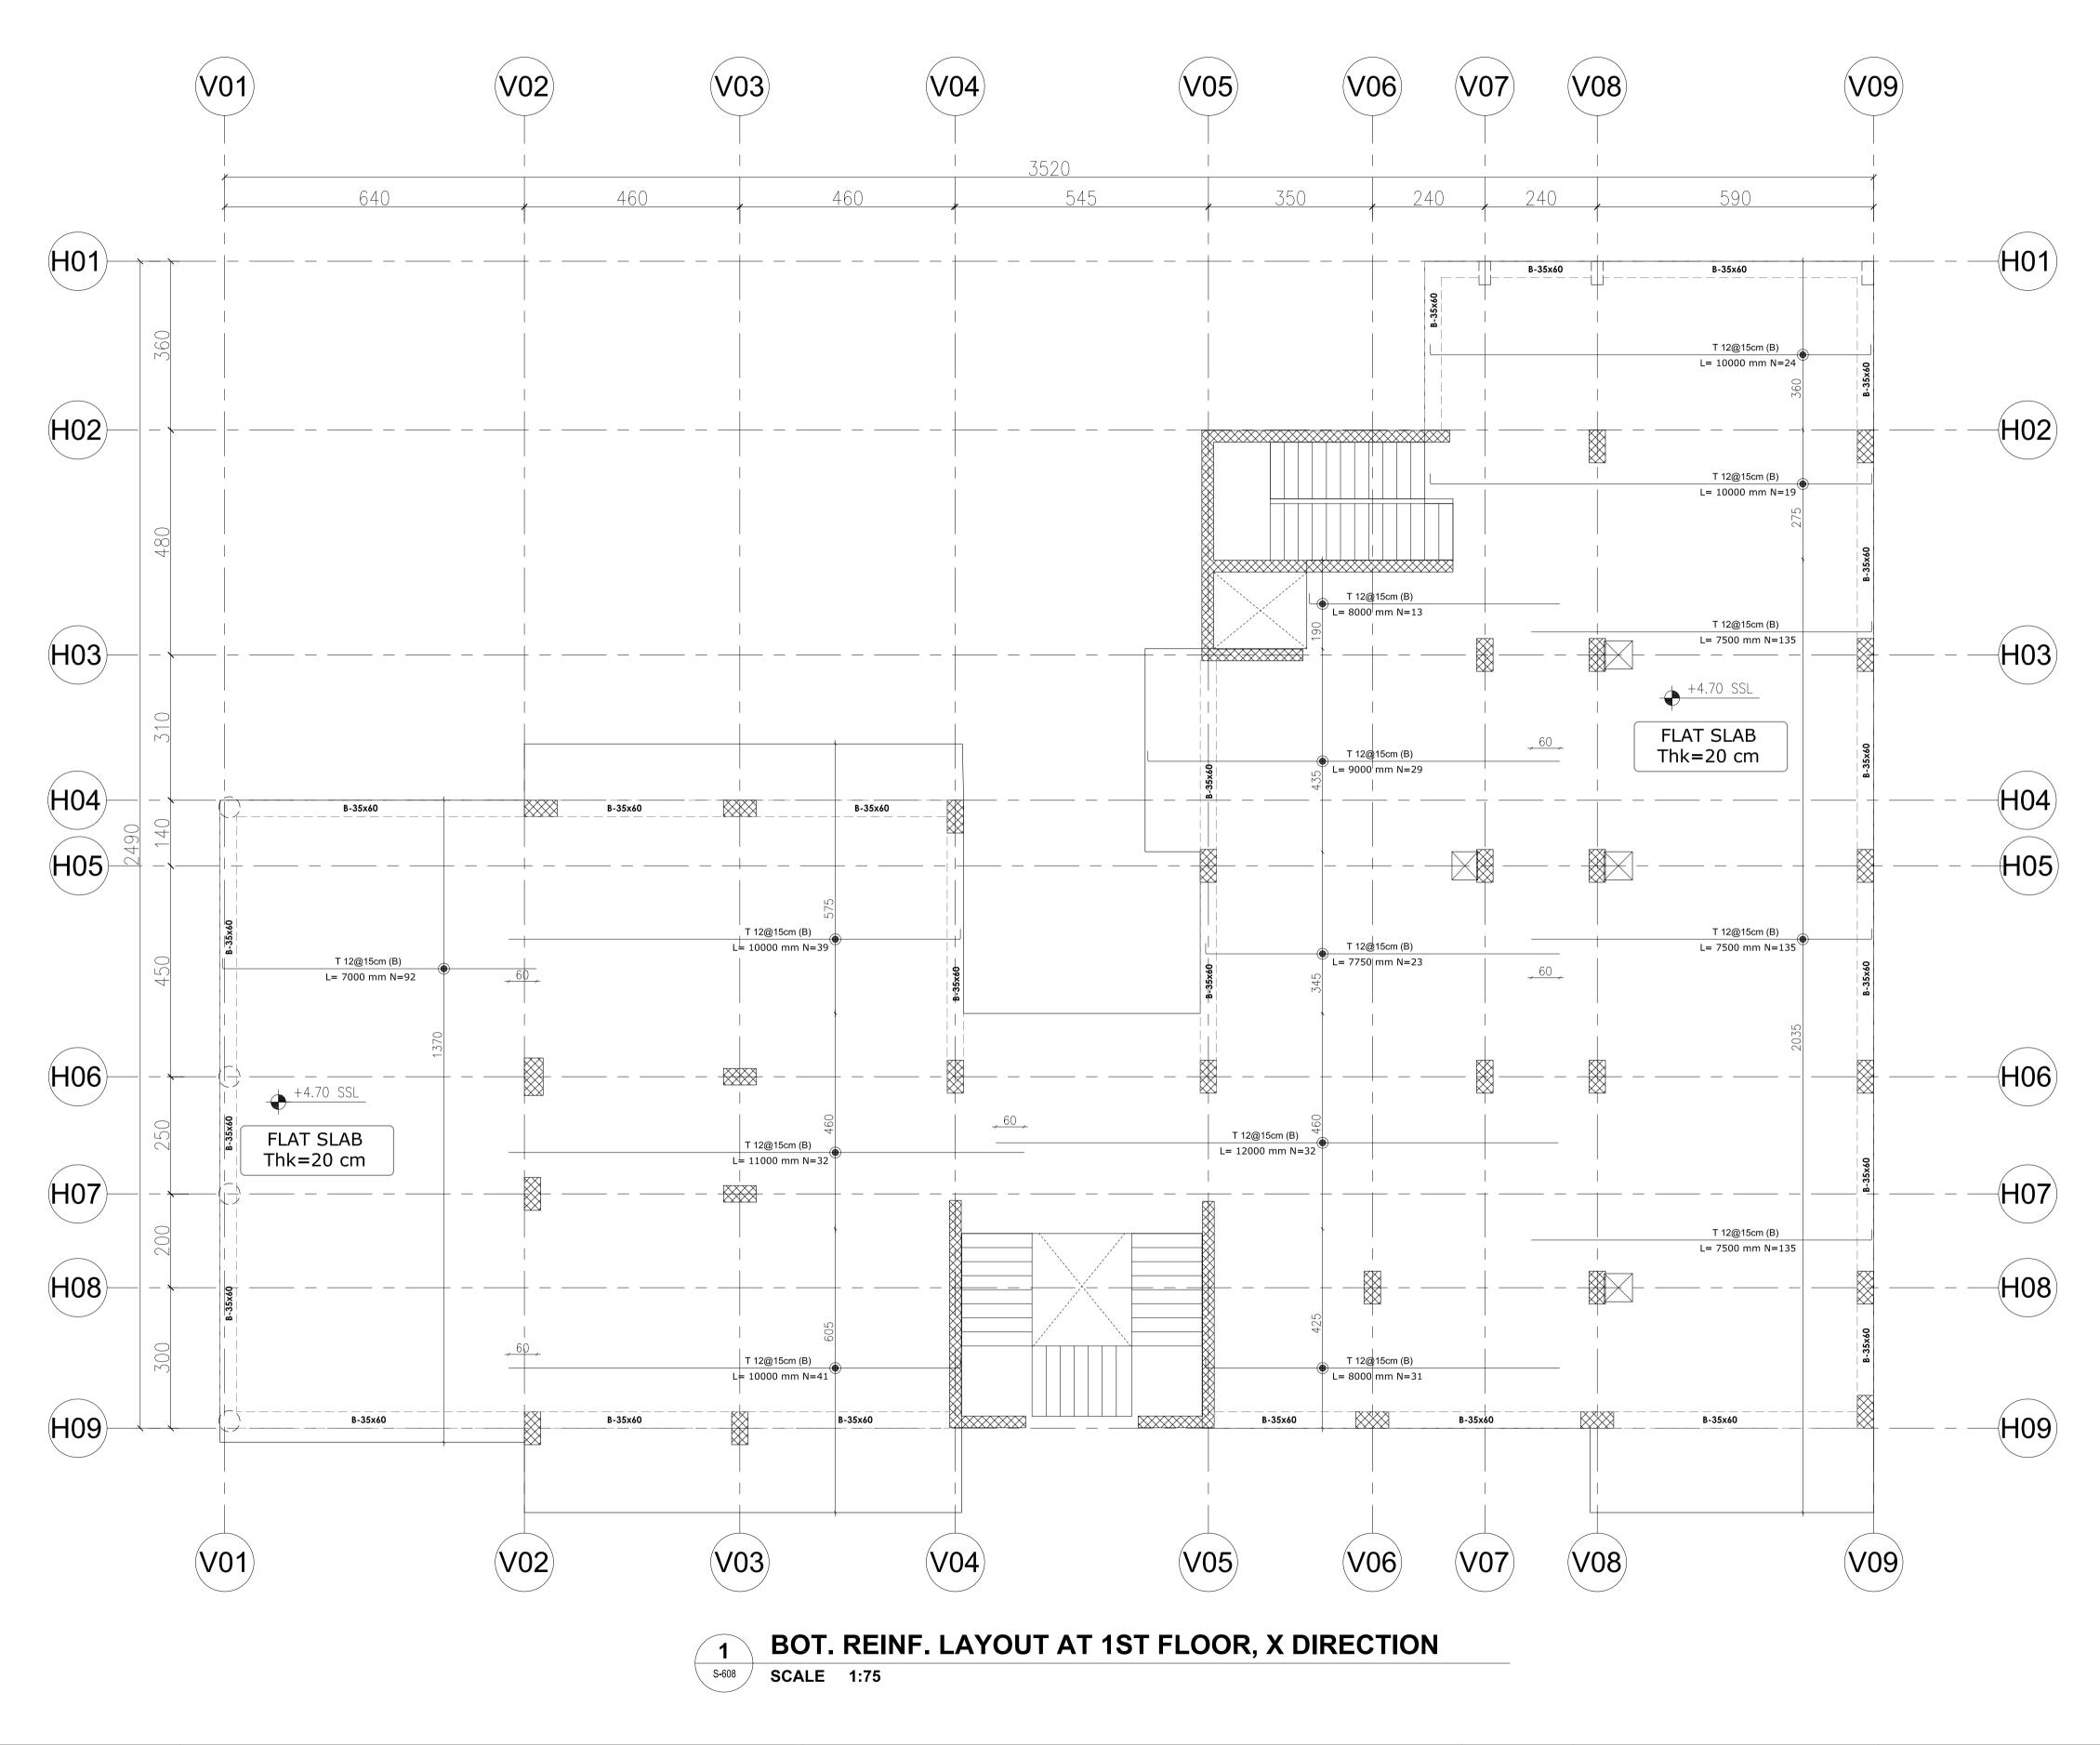
DESIGNED DRAWN CHECKED SCALE 17 JAN. 2022

DRAWING TITLE: BOT. REINF. LAYOUT AT 1ST FLOOR, Y DIRECTION

CONSULTANT OFFICE

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SIZE: A1 DRAWING no:



- all dimensions in (cm)

- all levels in meter (m)

PROJECT TITLE:

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CLIENT:

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DATE	17 JAN. 2022	

DRAWING TITLE:

BOT. REINF. LAYOUT AT

1ST FLOOR, X

DIRECTION


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SIZE: A1 DRAWING no:



APPROVAL

ADDITIONAL BARS SCHEDULE:

DETAILS

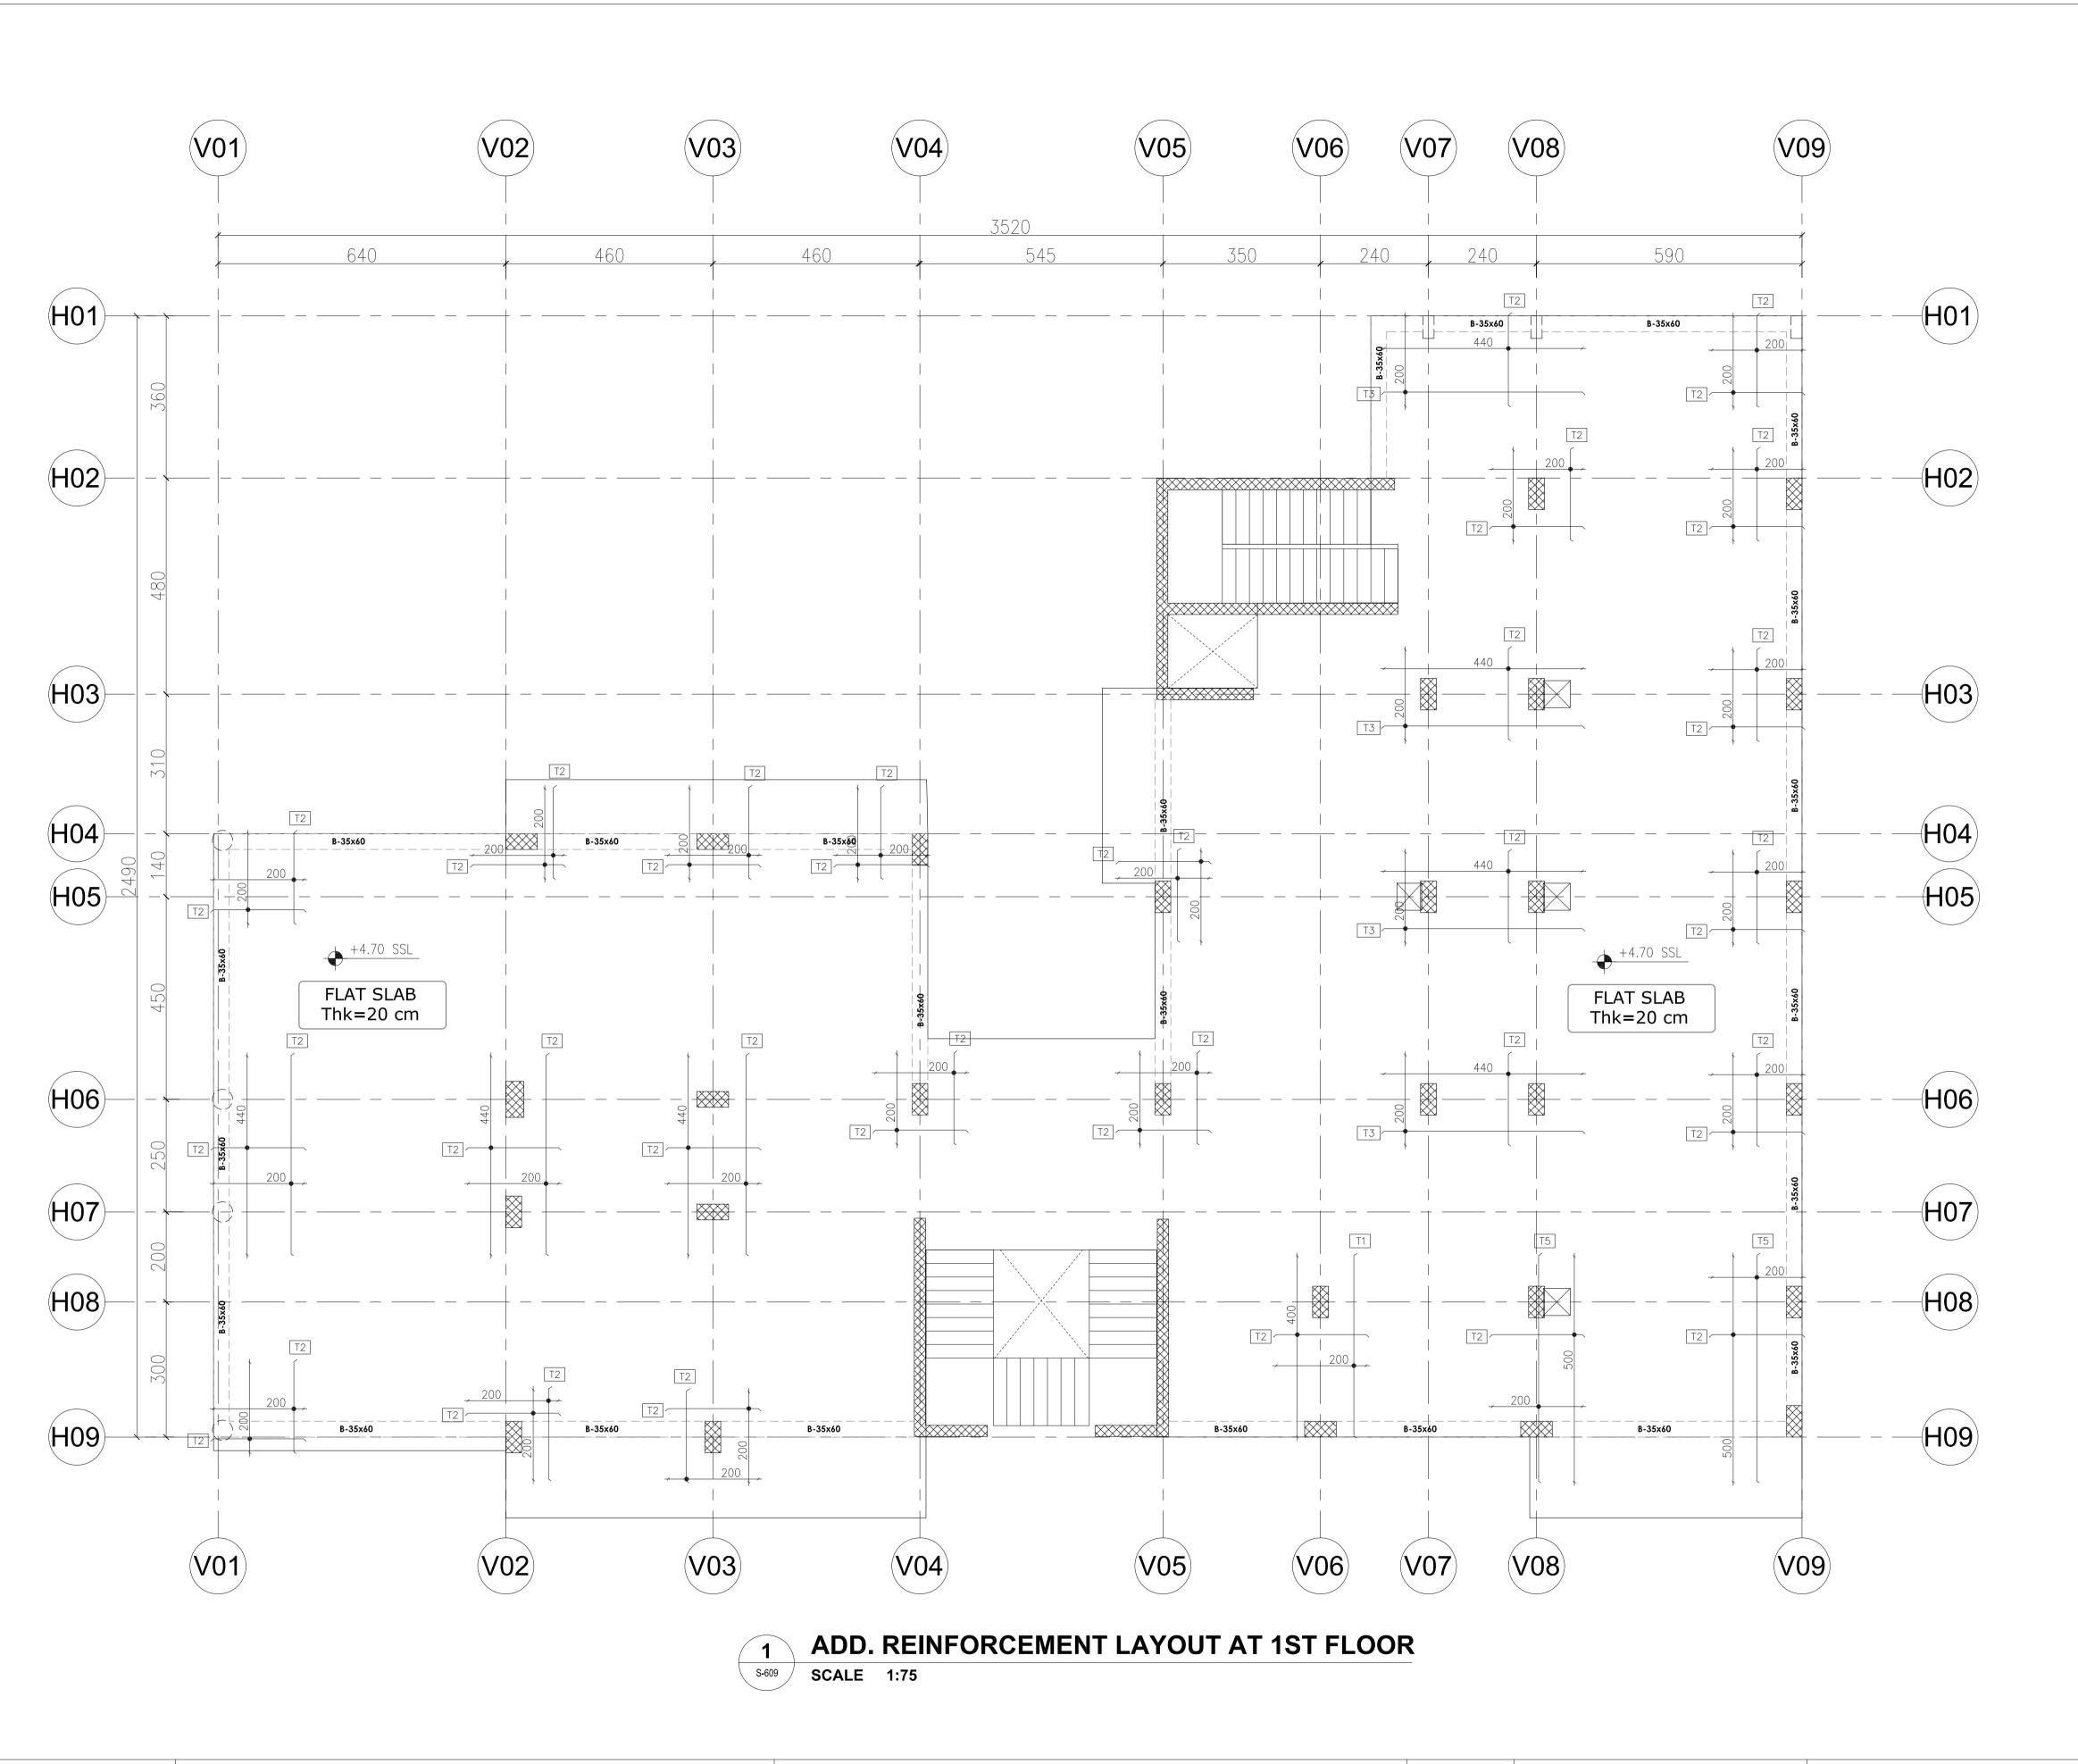T12 @ 15cm 400cm

T12 @ 15cm | 200cm

T12 @ 15cm 440cm

T12 @ 15cm 500cm

LENGHT

TAG DIMENSIONS

T1 TOP REINF.

T2 TOP REINF.

T3 TOP REINF.

T4 TOP REINF.

Note:

- all dimensions in (cm)

- all levels in meter (m)

PROJECT TITLE:

YORKVILLE HOTEL & **APARTMENTS LIMITED** CLIENT:

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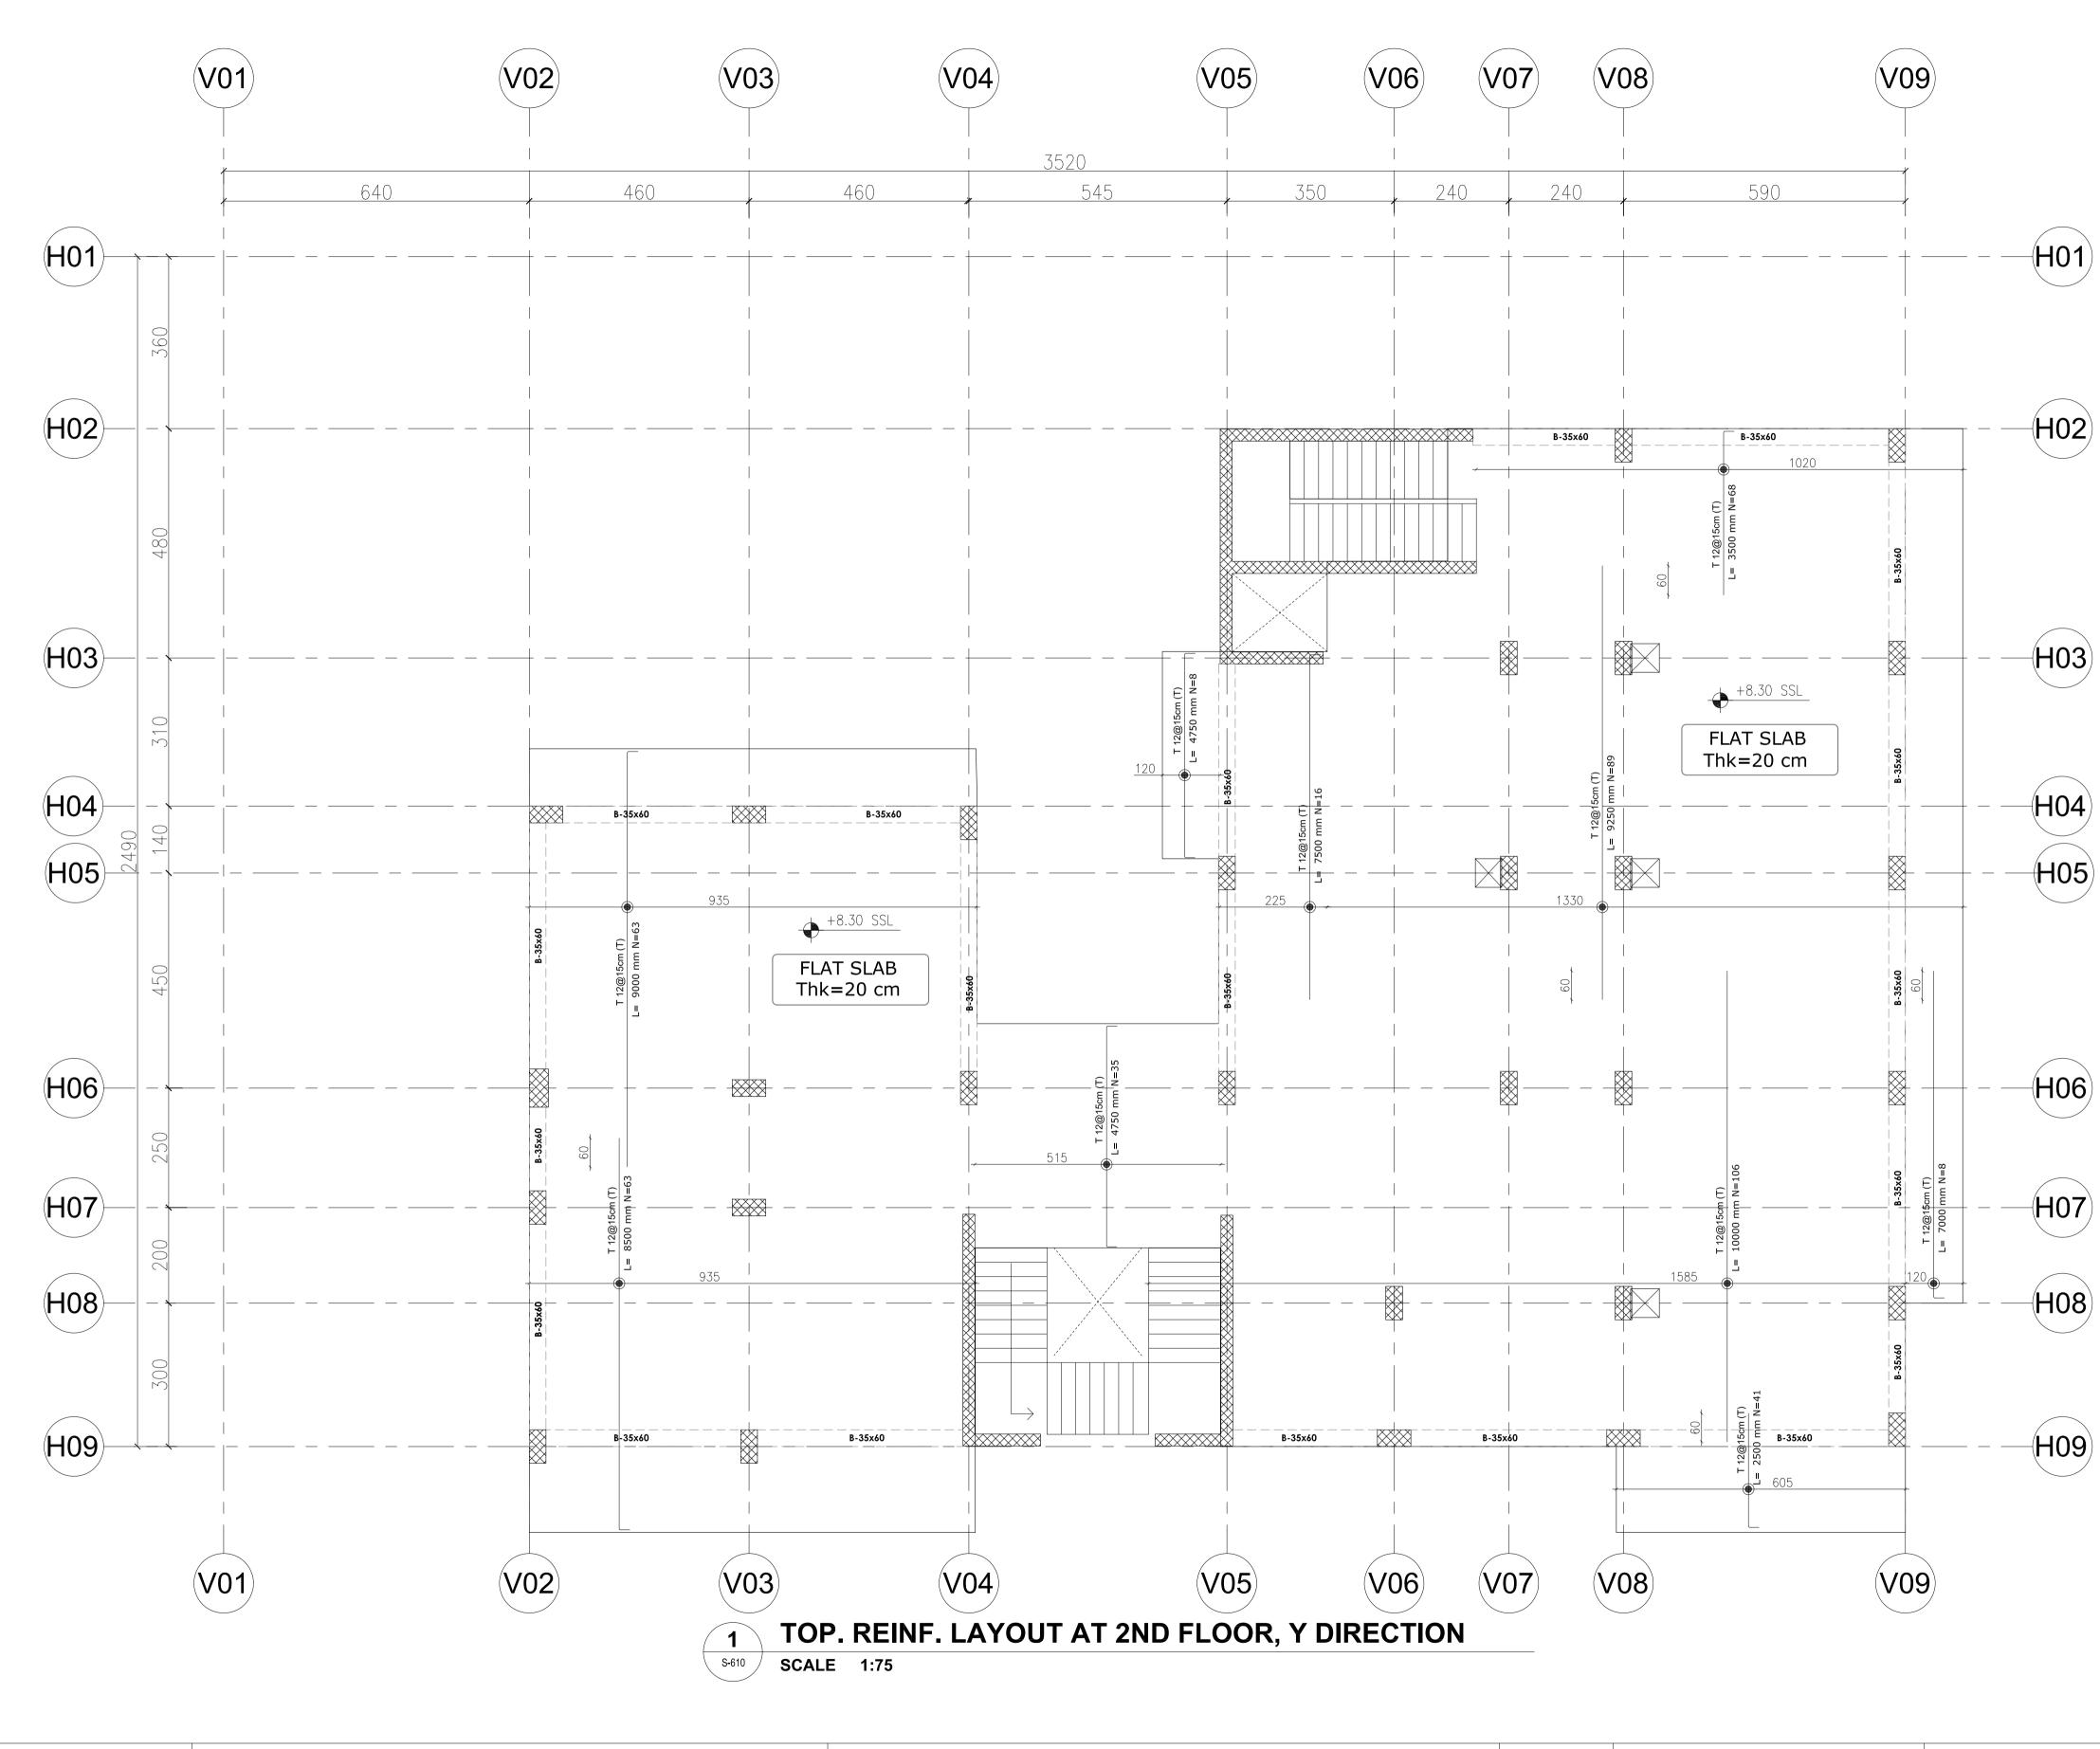
DESIGNED DRAWN CHECKED SCALE 17 JAN. 2022

DRAWING TITLE:

ADD. REINFORCEMENT LAYOUT AT 1ST FLOOR CONSULTANT OFFICE Java Design Concepts

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DRAWING no: SIZE: A1



all dimensions in (cm)all levels in meter (m)

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PROJECT TITLE:

CLIENT: **DELOMIS**

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DRAWING TITLE:
TOP. REINF. LAYOUT AT
2ND FLOOR, Y
DIRECTION


CONSULTANT OFFICE

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SIZE: A1 DRAWING no:



all dimensions in (cm)all levels in meter (m)

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YORKVILLE HOTEL & APARTMENTS LIMITED

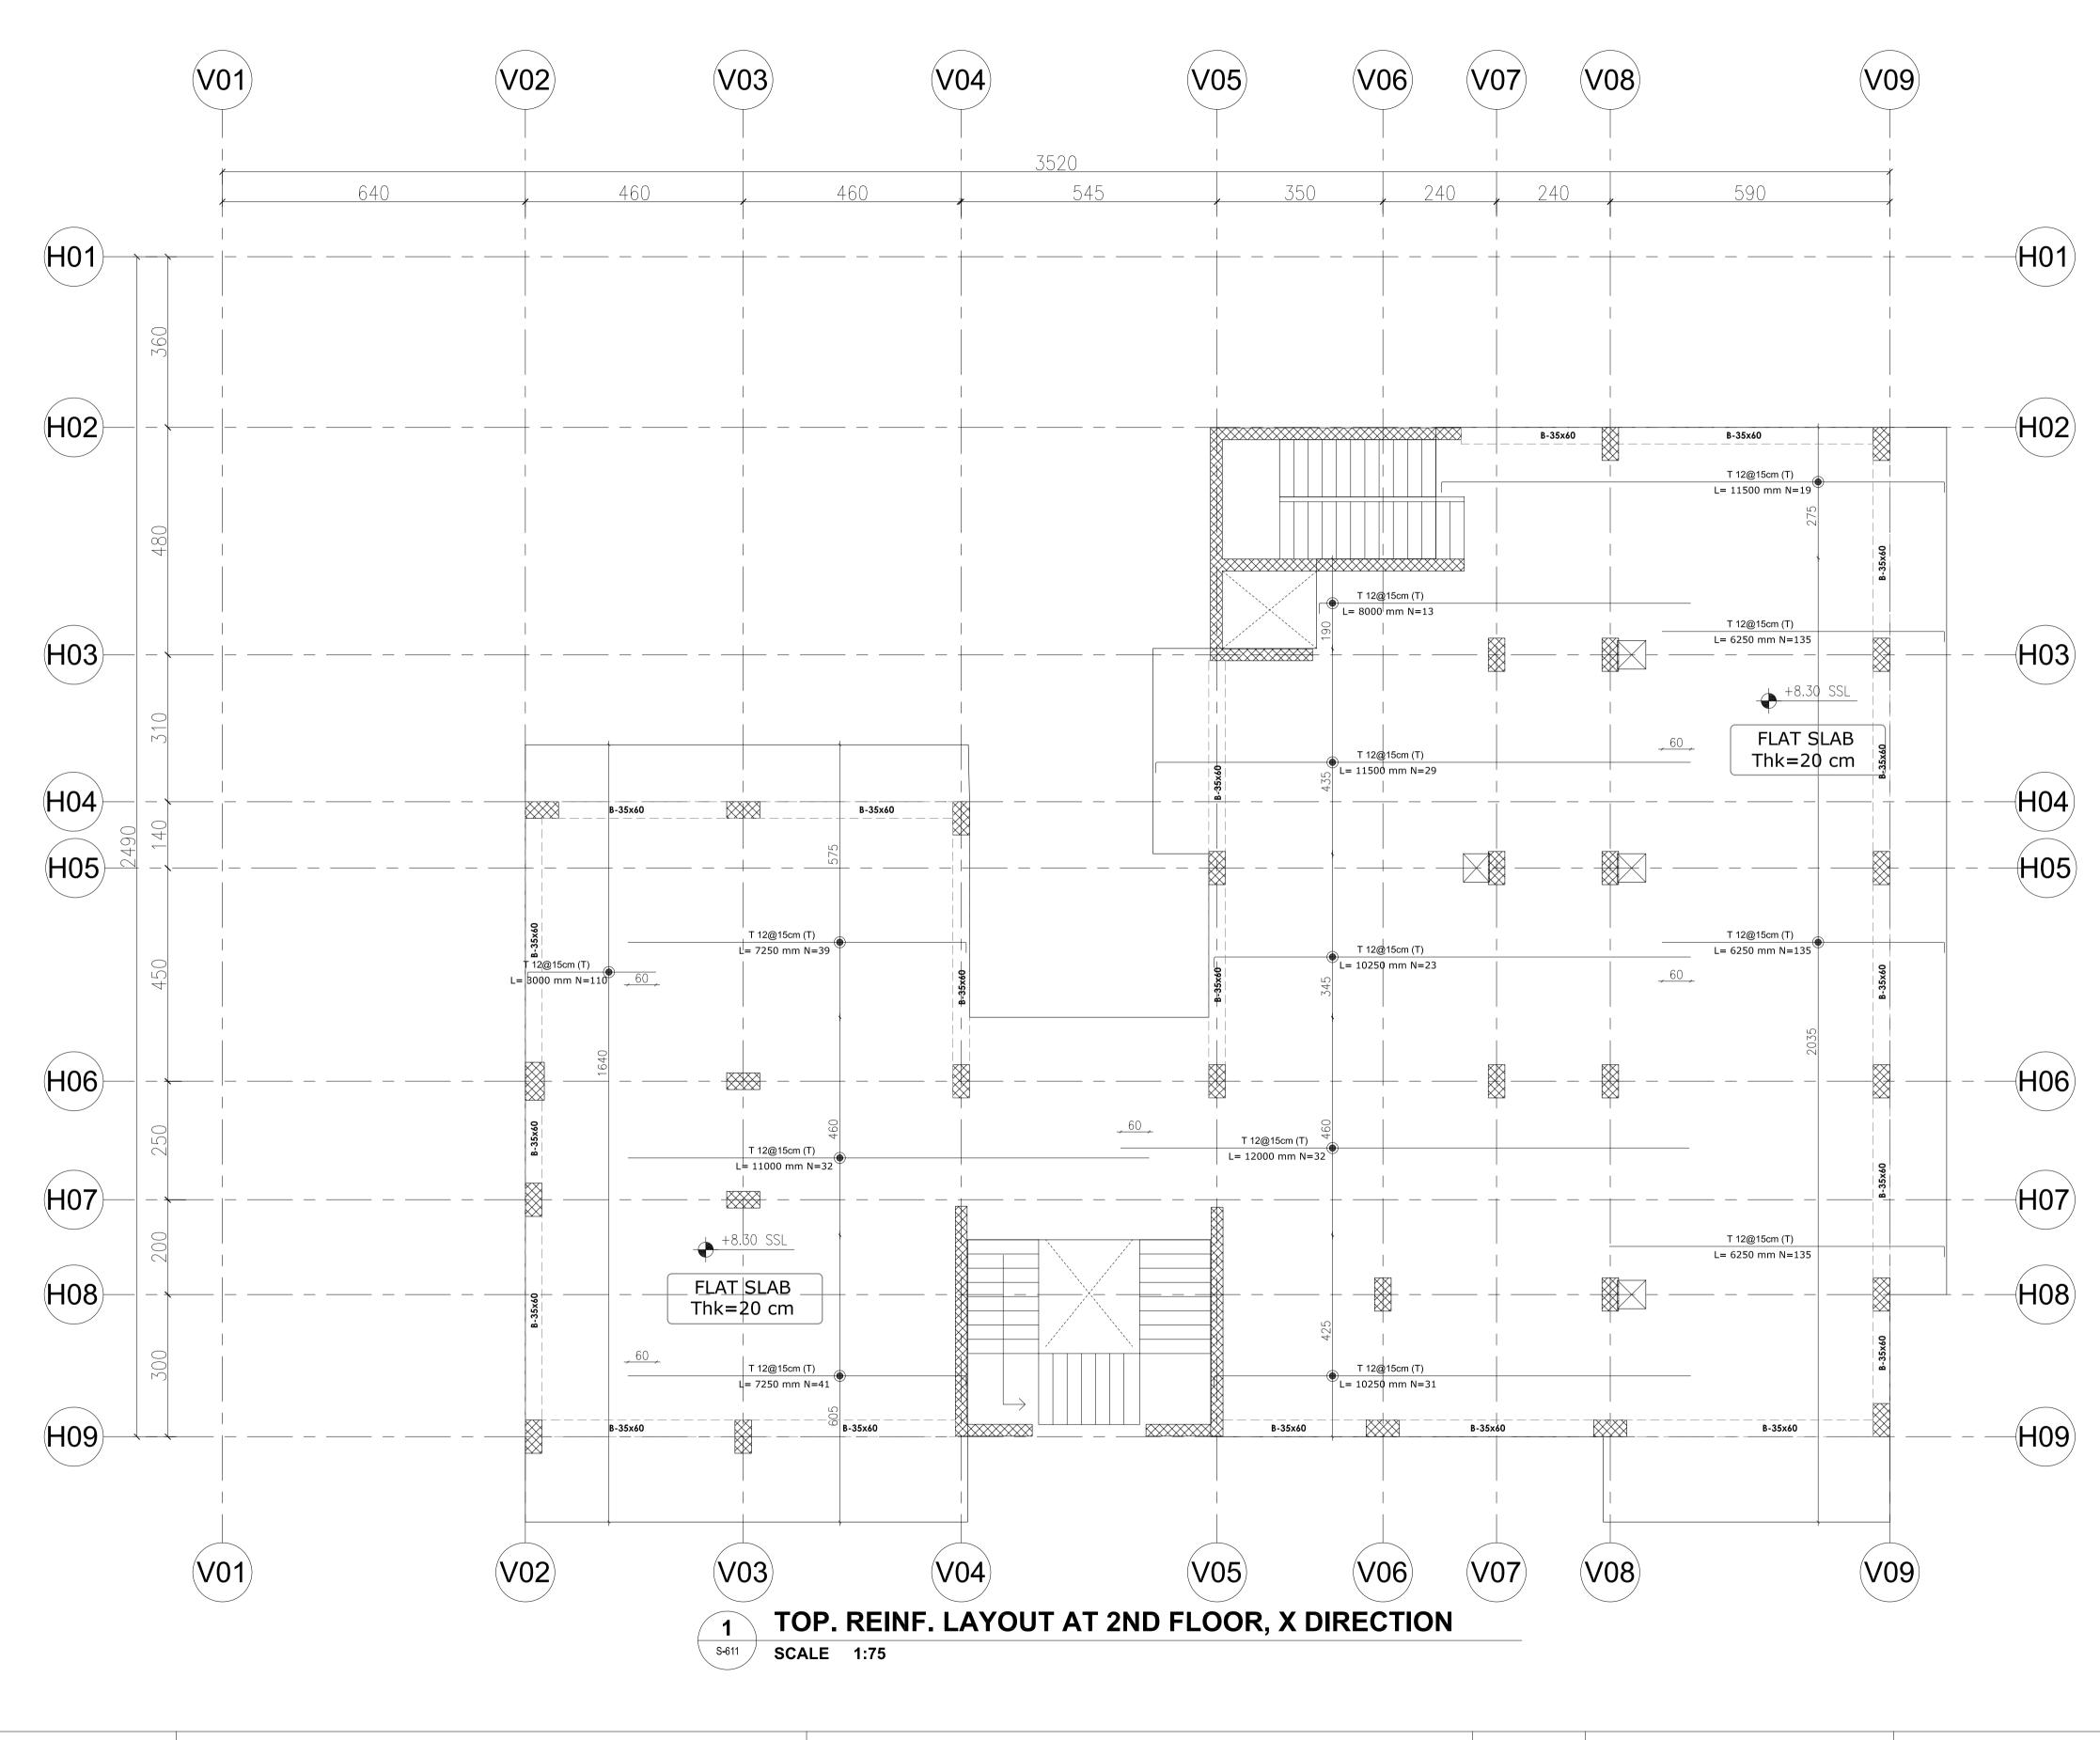PROJECT TITLE:

CLIENT: **DELOMIS**

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17 JAN. 2022

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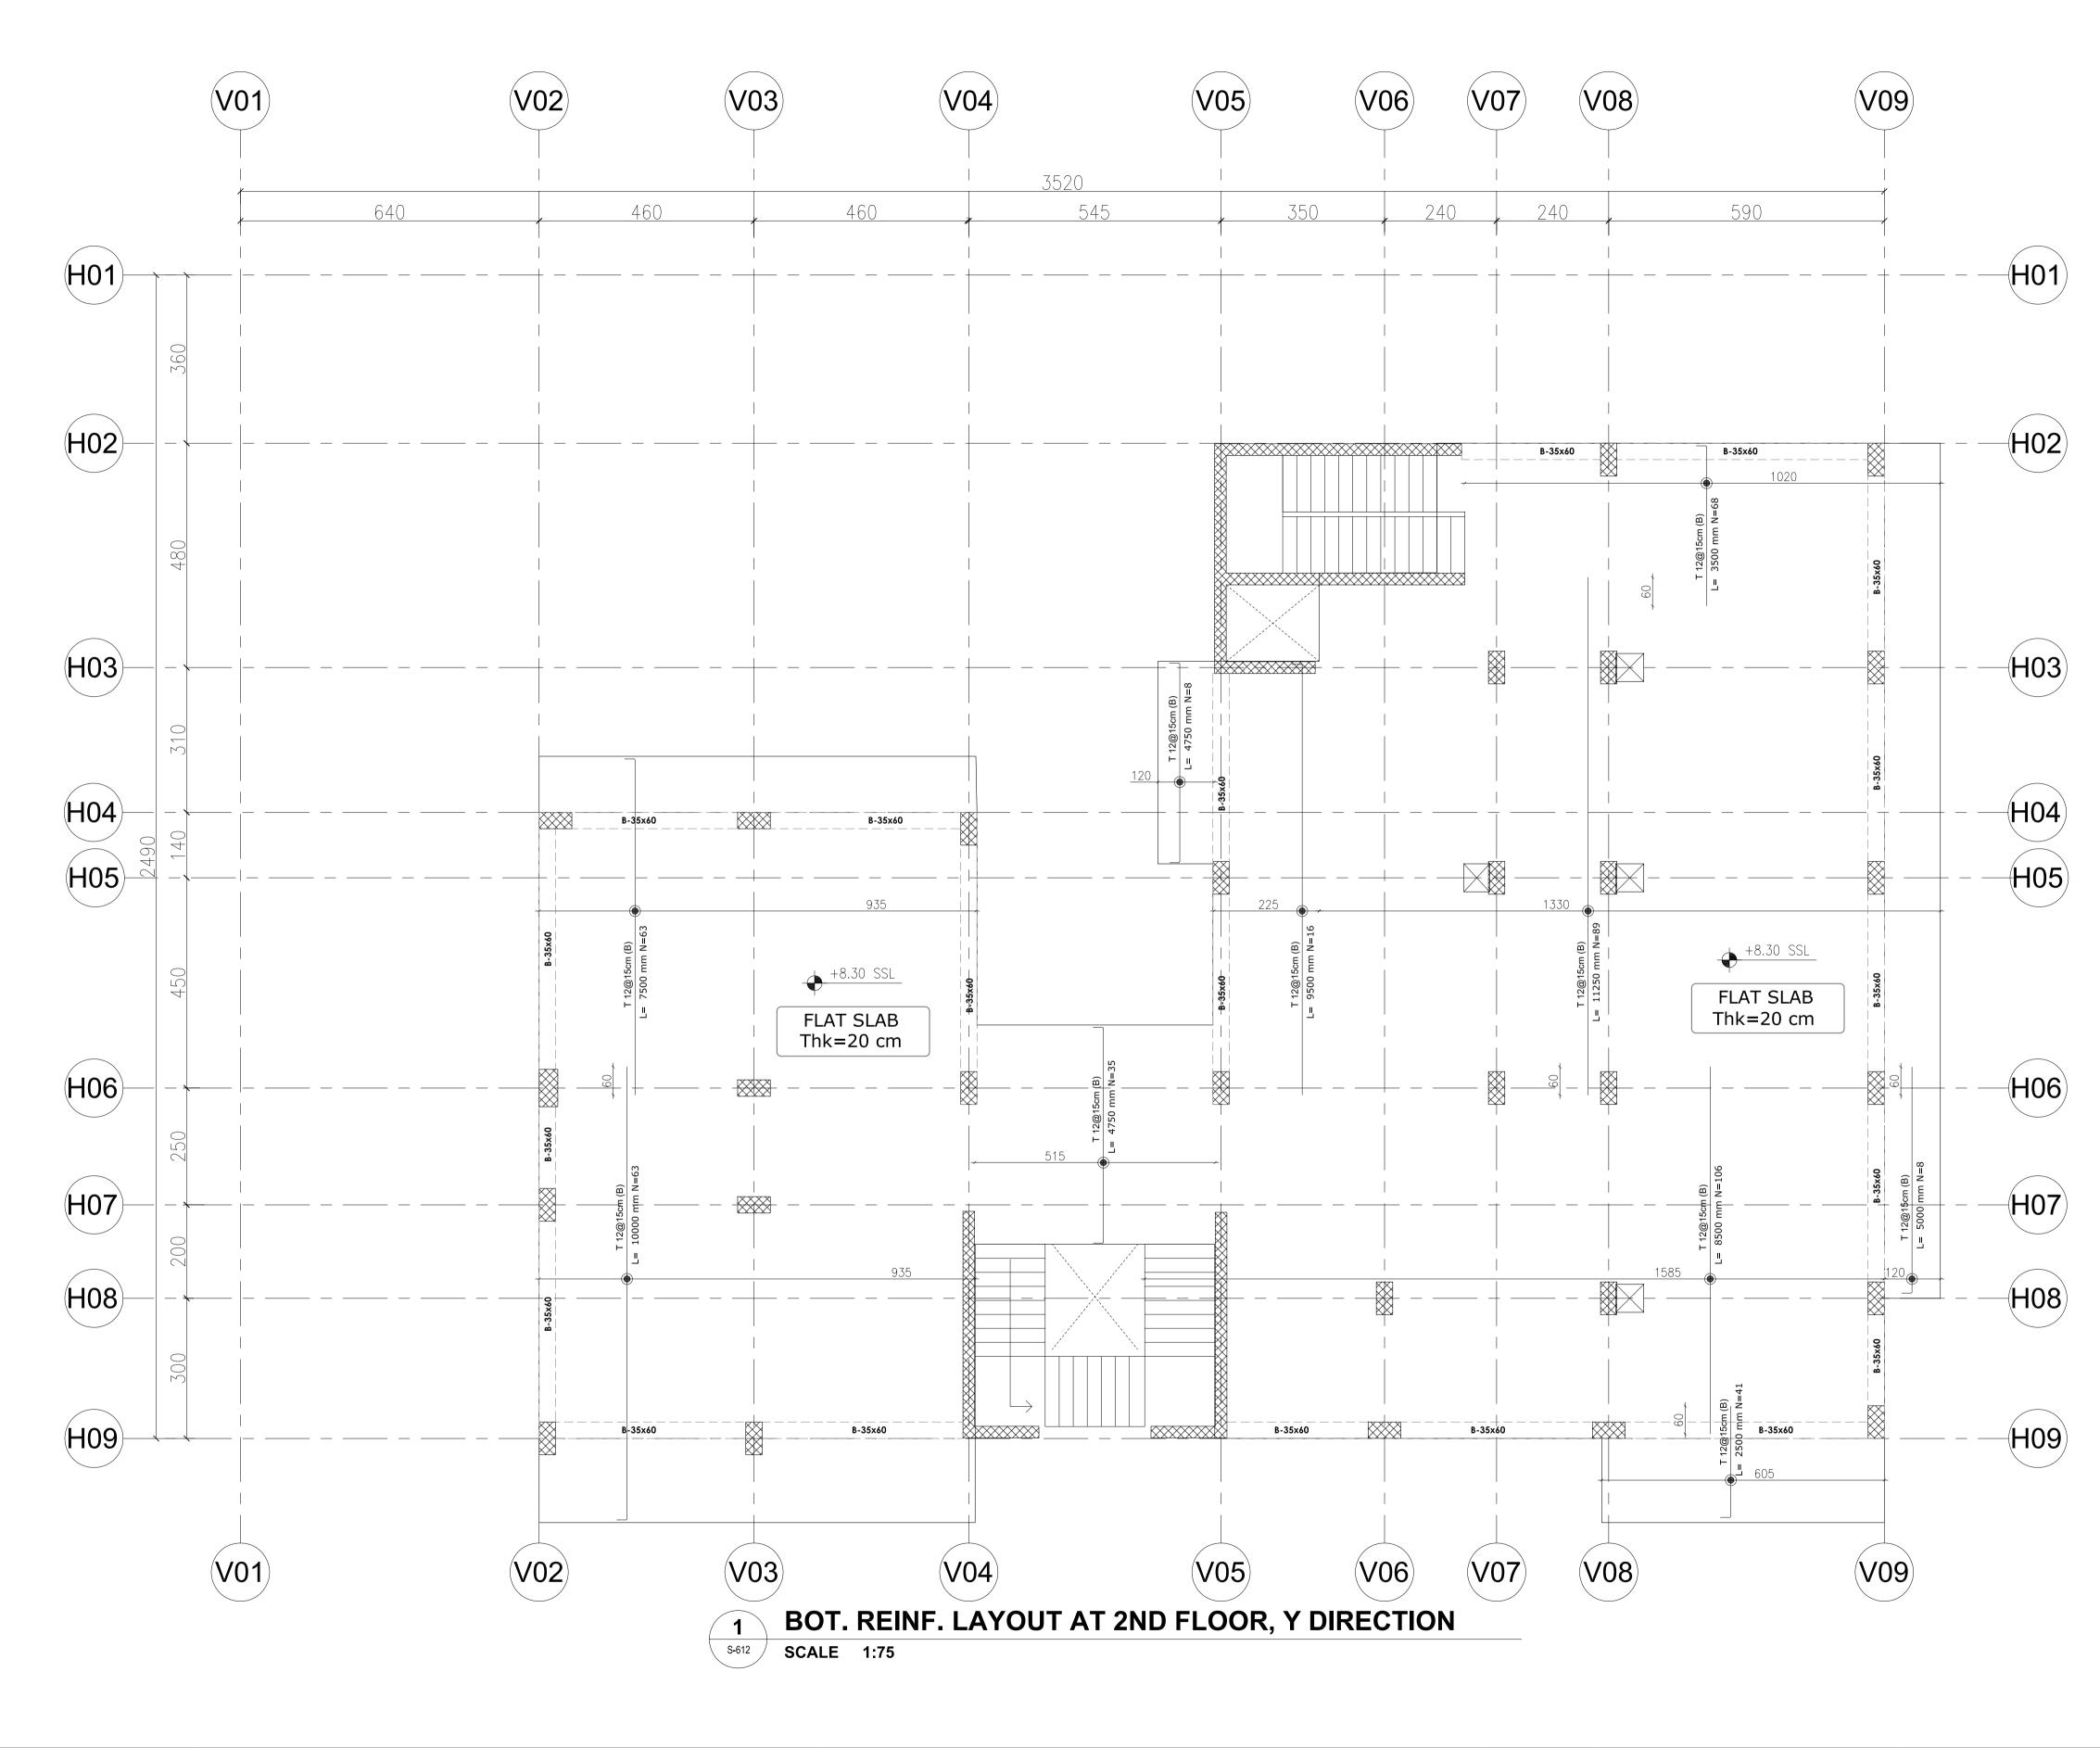
TOP. REINF. LAYOUT AT 2ND FLOOR, X DIRECTION CONSULTANT OFFICE

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SIZE: A1 DRAWING no:



- all dimensions in (cm)

- all levels in meter (m)

PROJECT TITLE:

YORKVILLE HOTEL & APARTMENTS LIMITED

CLIENT:

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DATE	17 JAN. 2022	

DRAWING TITLE:


BOT. REINF. LAYOUT AT 2ND FLOOR, Y DIRECTION CONSULTANT OFFICE

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SIZE: A1 DRAWING no:



- all dimensions in (cm) - all levels in meter (m)

YORKVILLE HOTEL & **APARTMENTS LIMITED**

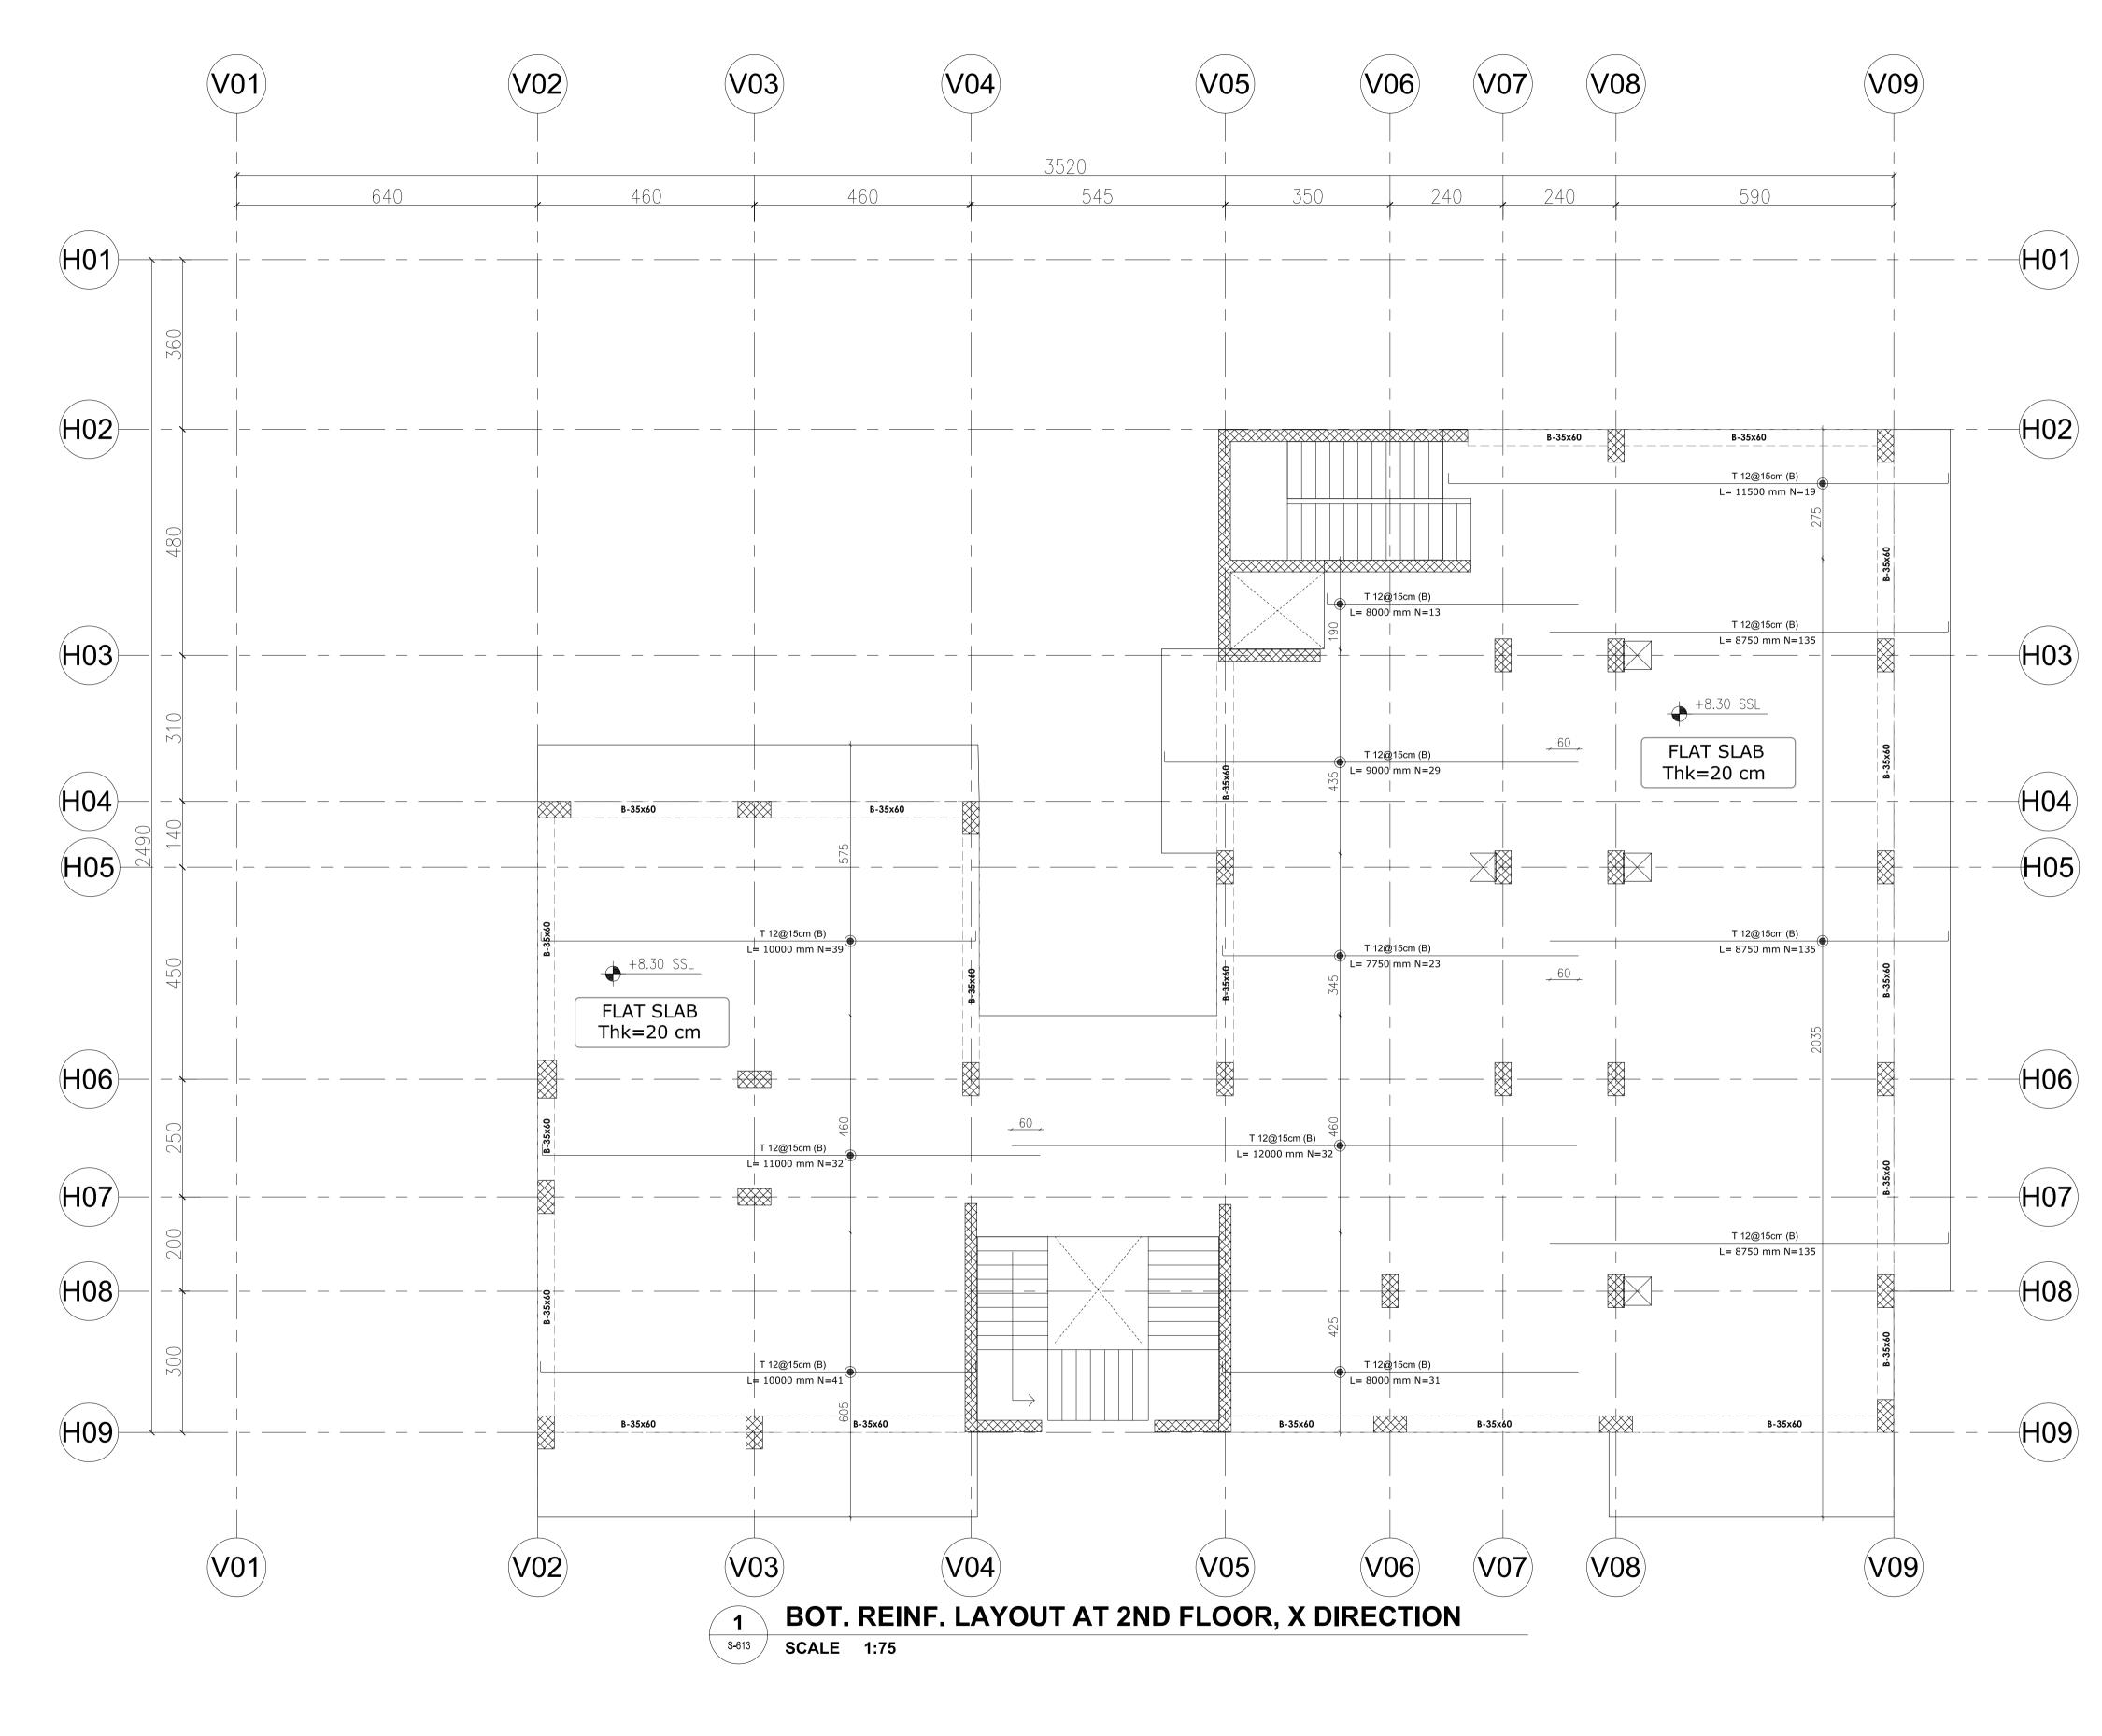PROJECT TITLE:

CLIENT: **DELOMIS** DESIGNED DRAWN CHECKED SCALE 17 JAN. 2022 DATE


DRAWING TITLE:

BOT. REINF. LAYOUT AT 2ND FLOOR, X DIRECTION

CONSULTANT OFFICE Java Design Concepts LTD



SIZE: A1 DRAWING no:

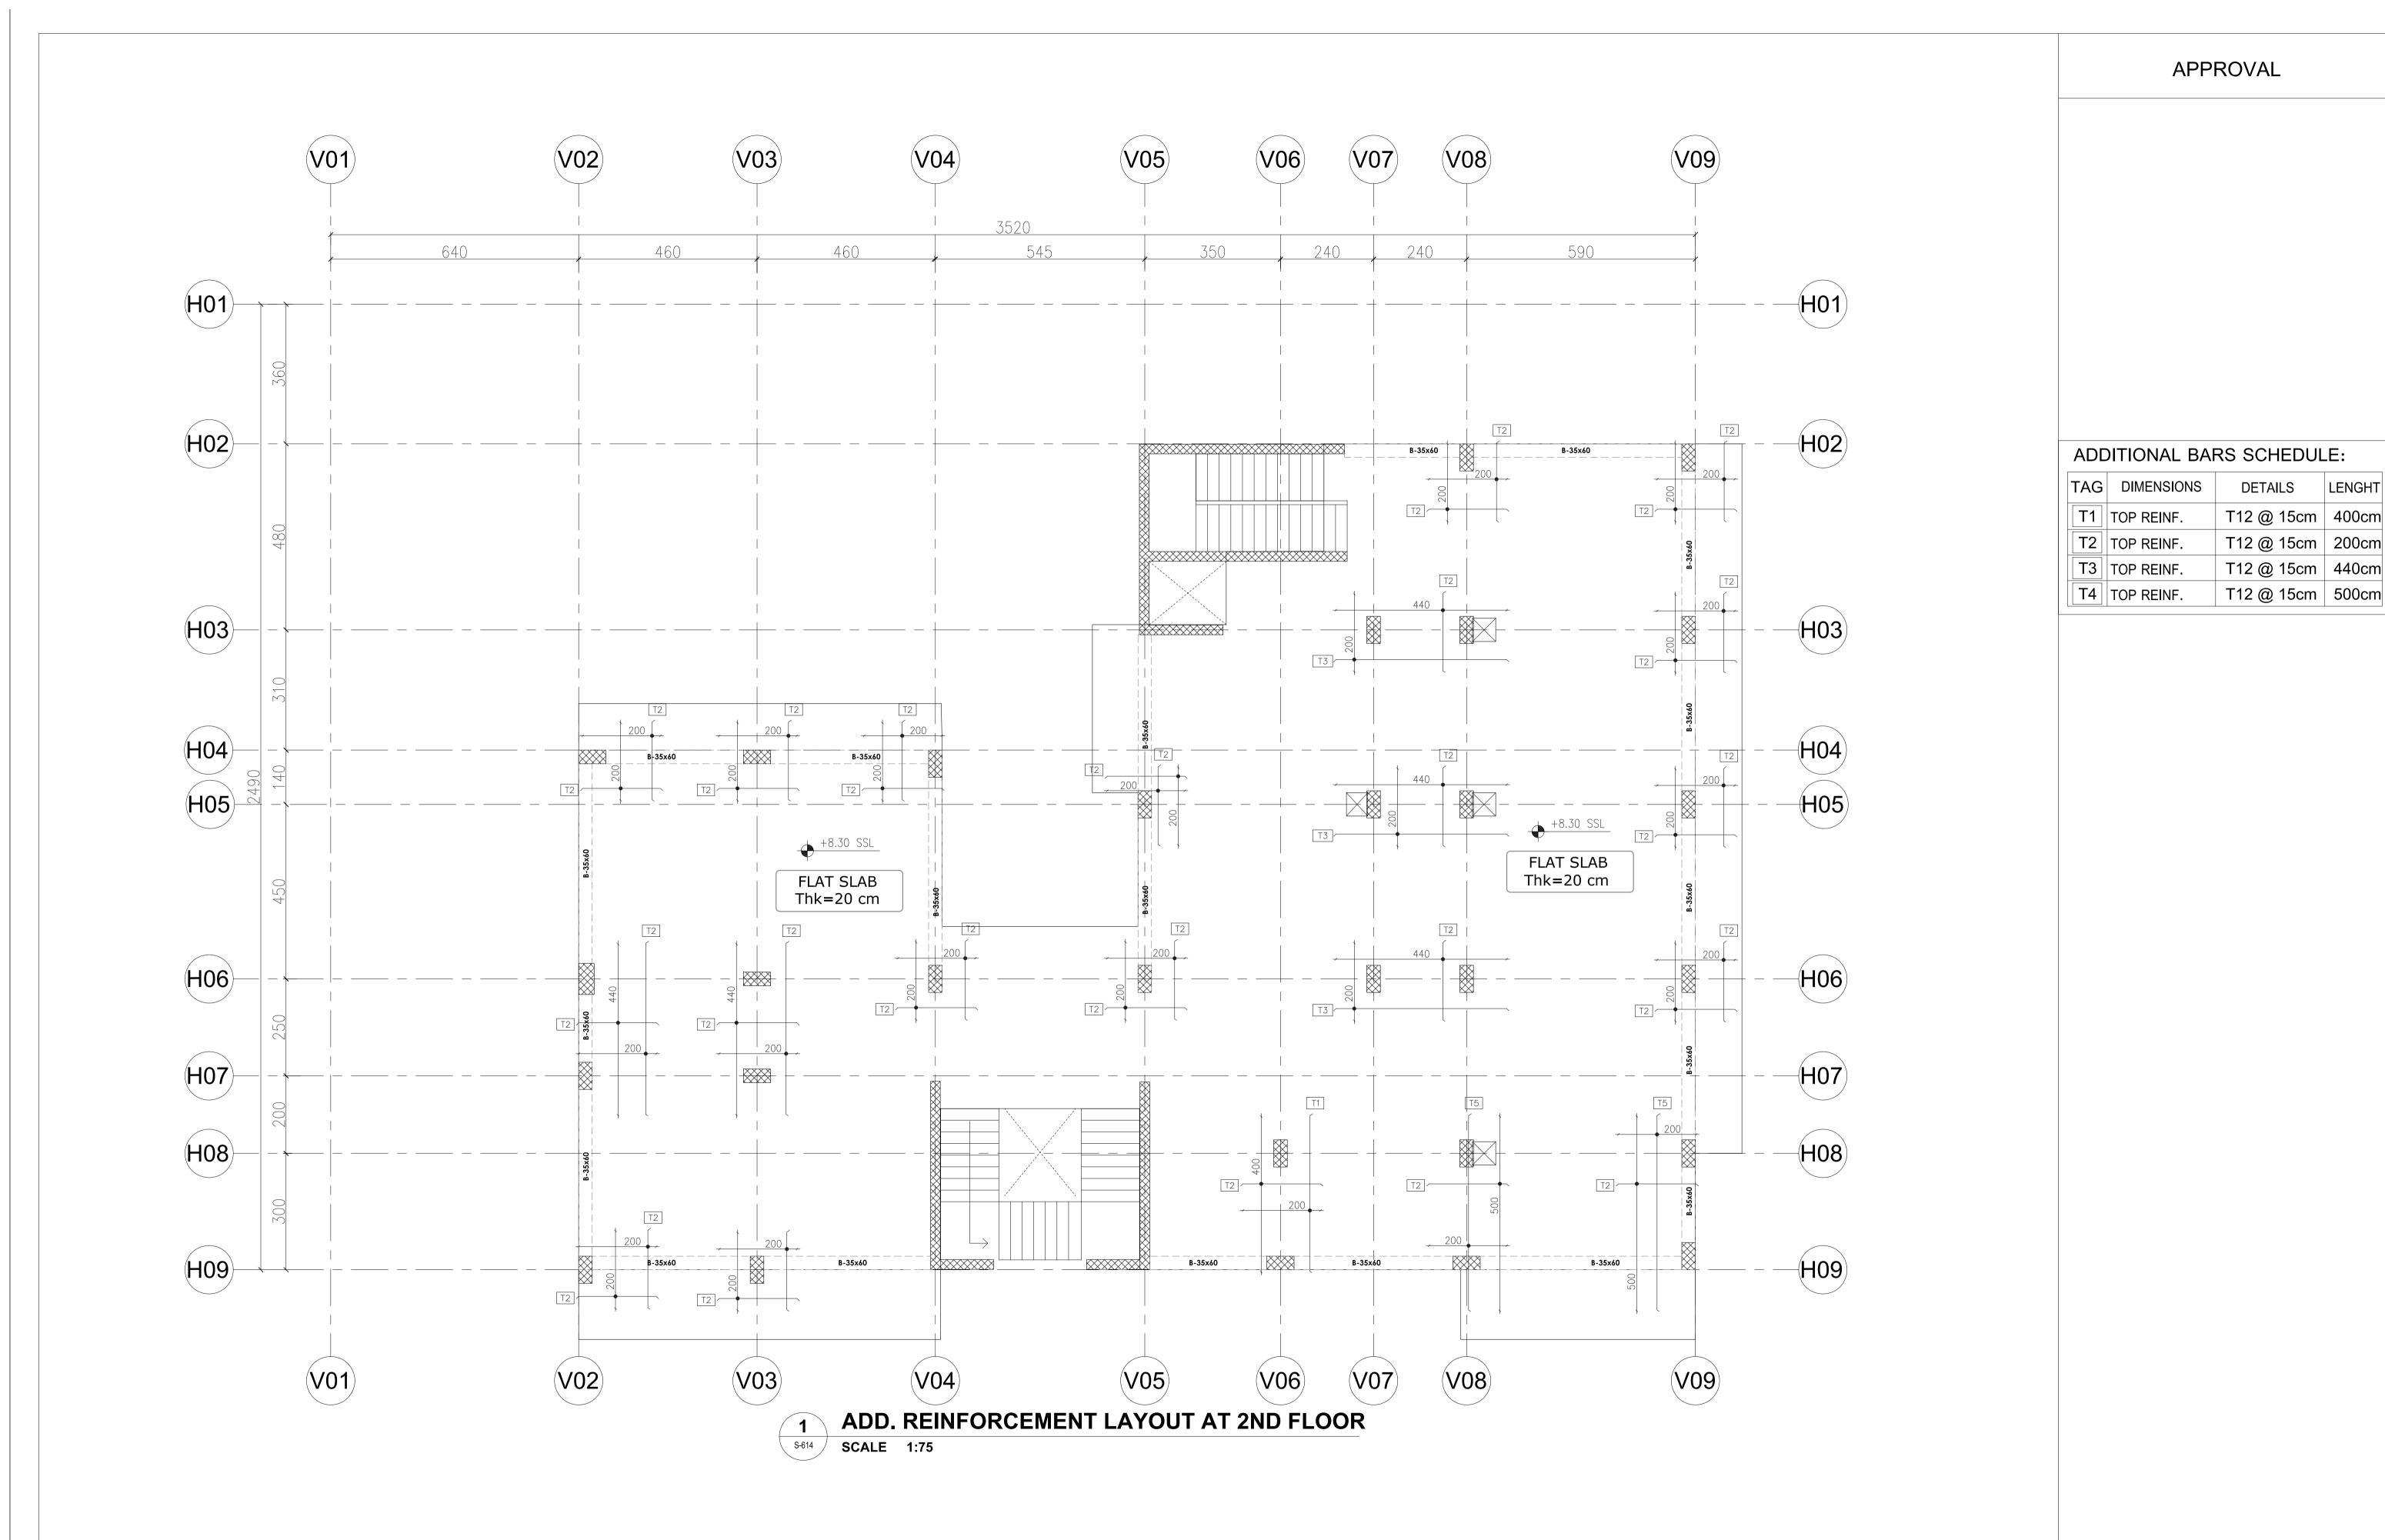

CONSULTANT OFFICE

Java Design Concepts LTD

Note:

- all dimensions in (cm) - all levels in meter (m) YORKVILLE HOTEL & **APARTMENTS LIMITED**


PROJECT TITLE:

CLIENT: **DELOMIS** DESIGNED DRAWING TITLE: DRAWN CHECKED SCALE 17 JAN. 2022

ADD. REINFORCEMENT LAYOUT AT 2ND FLOOR

SIZE: A1

DRAWING no:

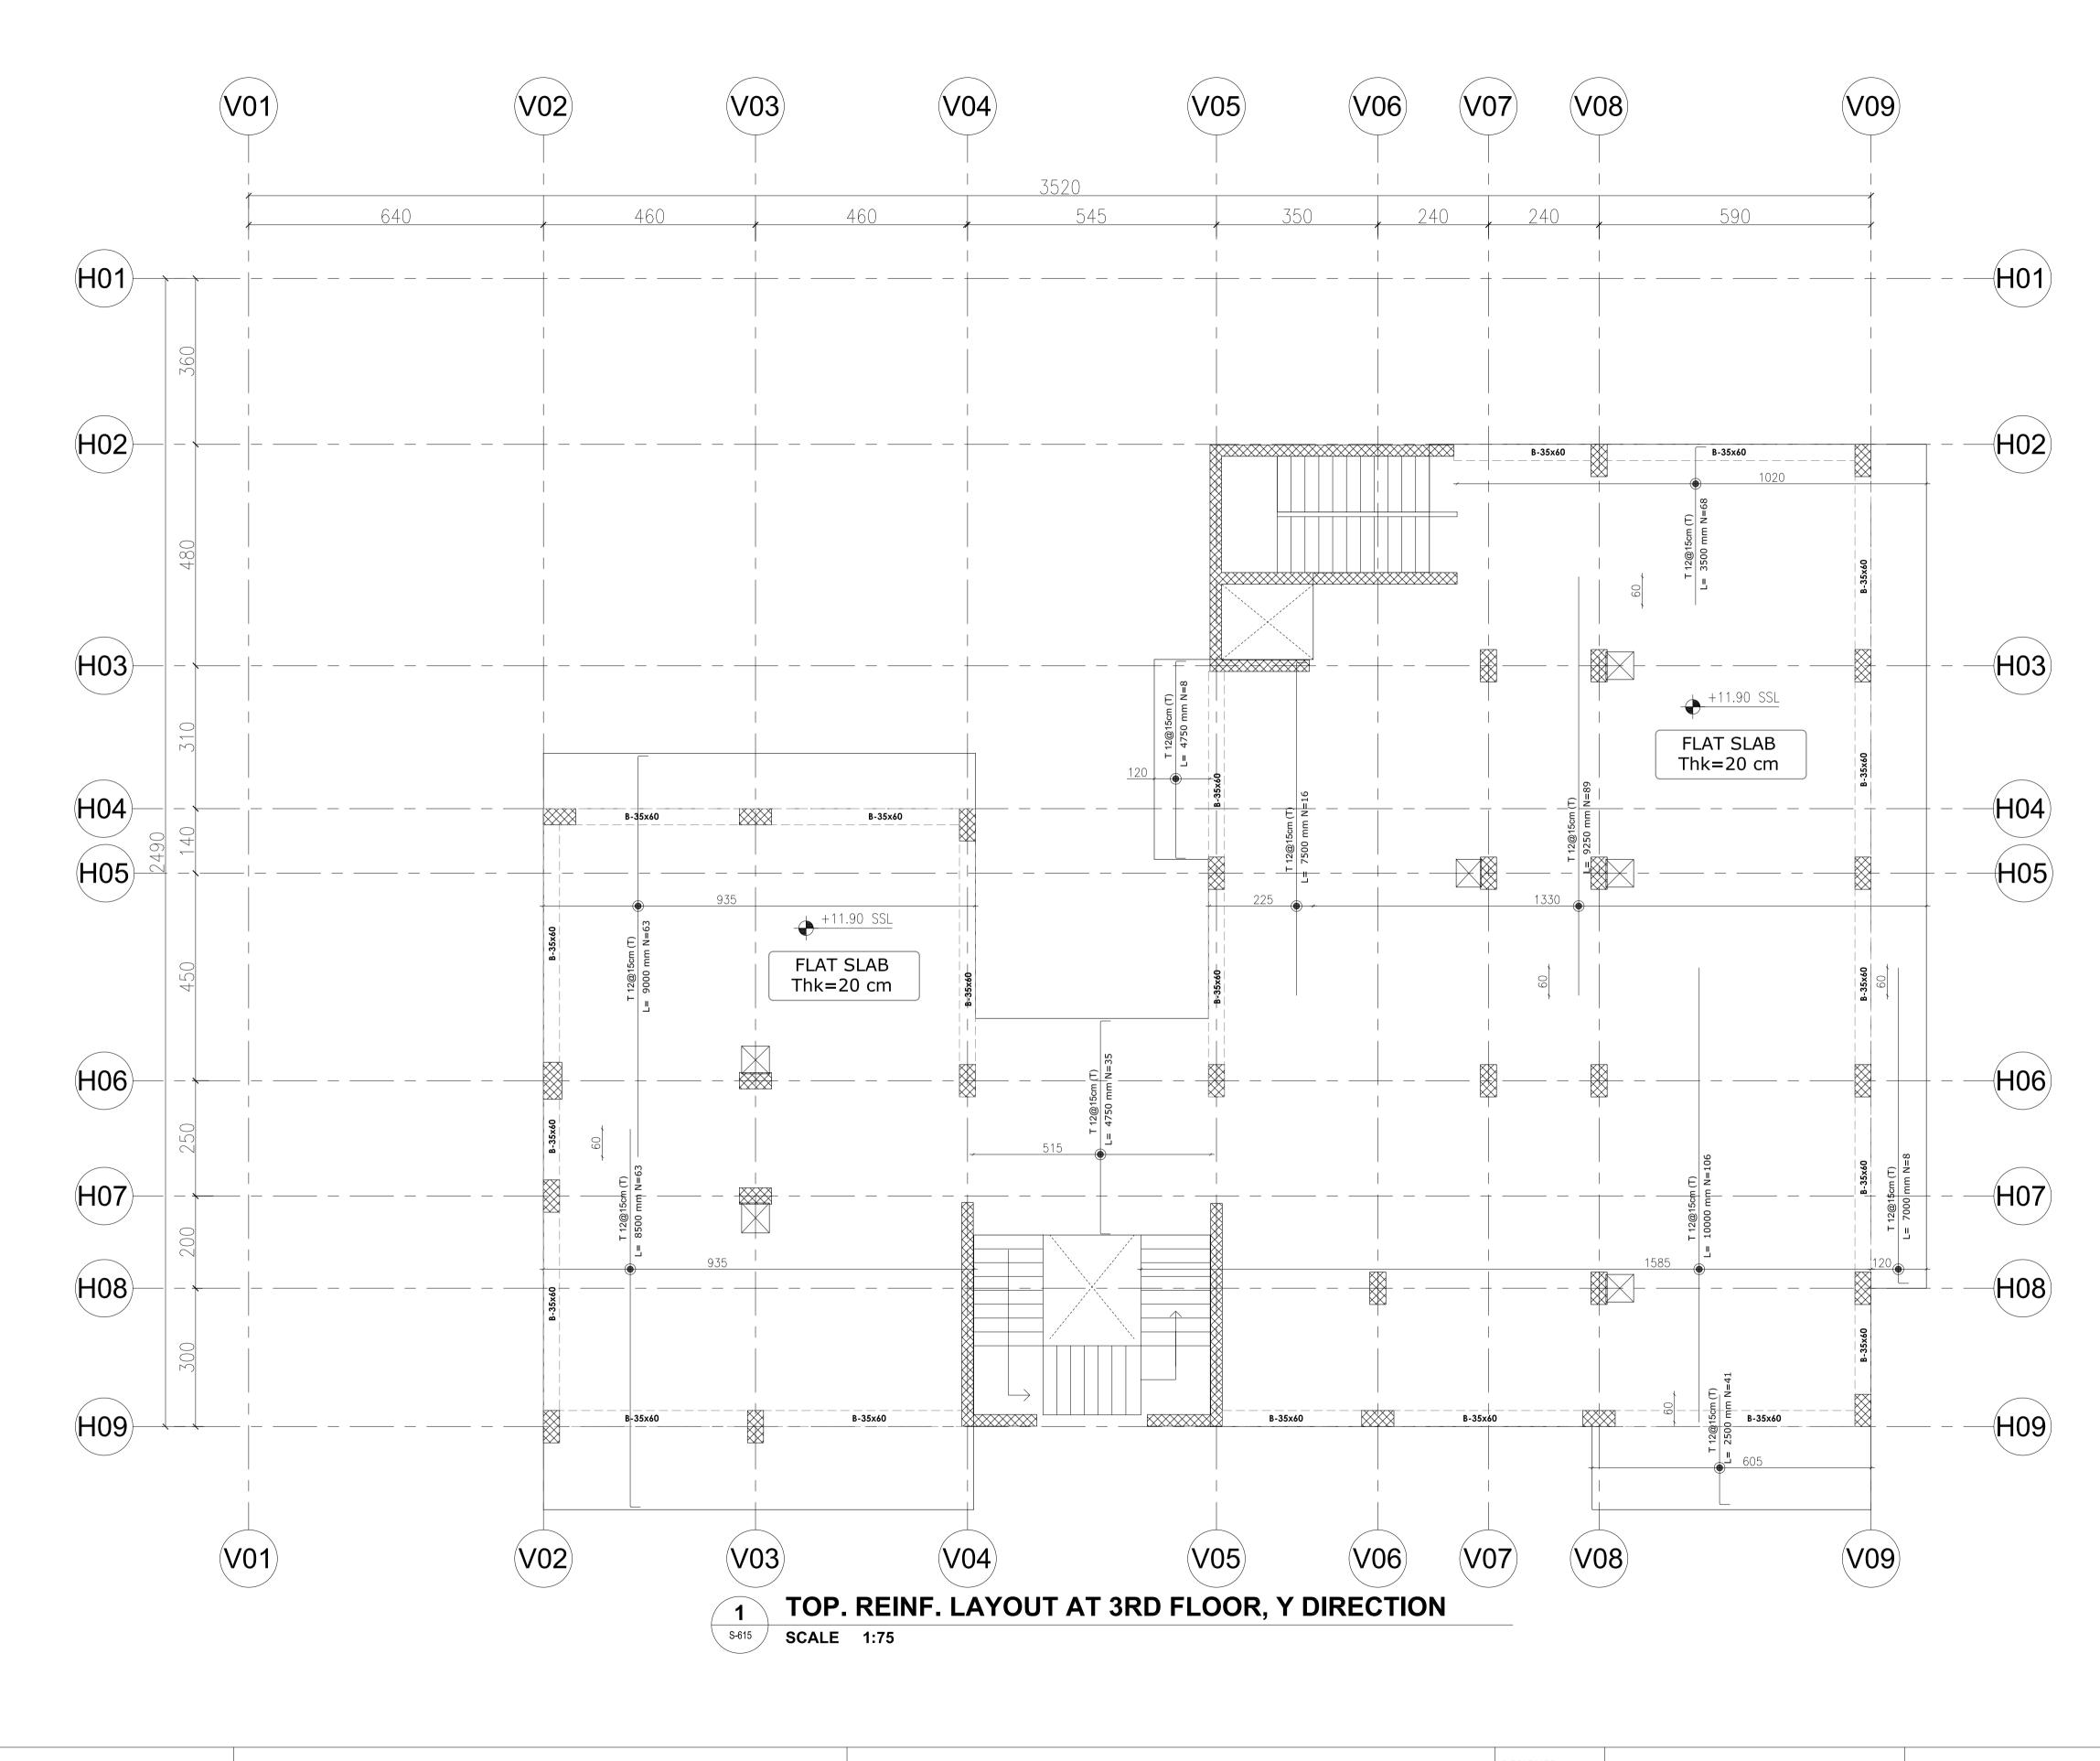

- all dimensions in (cm)

- all levels in meter (m)

PROJECT TITLE:

YORKVILLE HOTEL & **APARTMENTS LIMITED**

CLIENT: **DELOMIS** DESIGNED DRAWN CHECKED SCALE 17 JAN. 2022


DRAWING TITLE:

TOP. REINF. LAYOUT AT 3RD FLOOR, Y DIRECTION

CONSULTANT OFFICE

Java Design Concepts LTD

DRAWING no: SIZE: A1

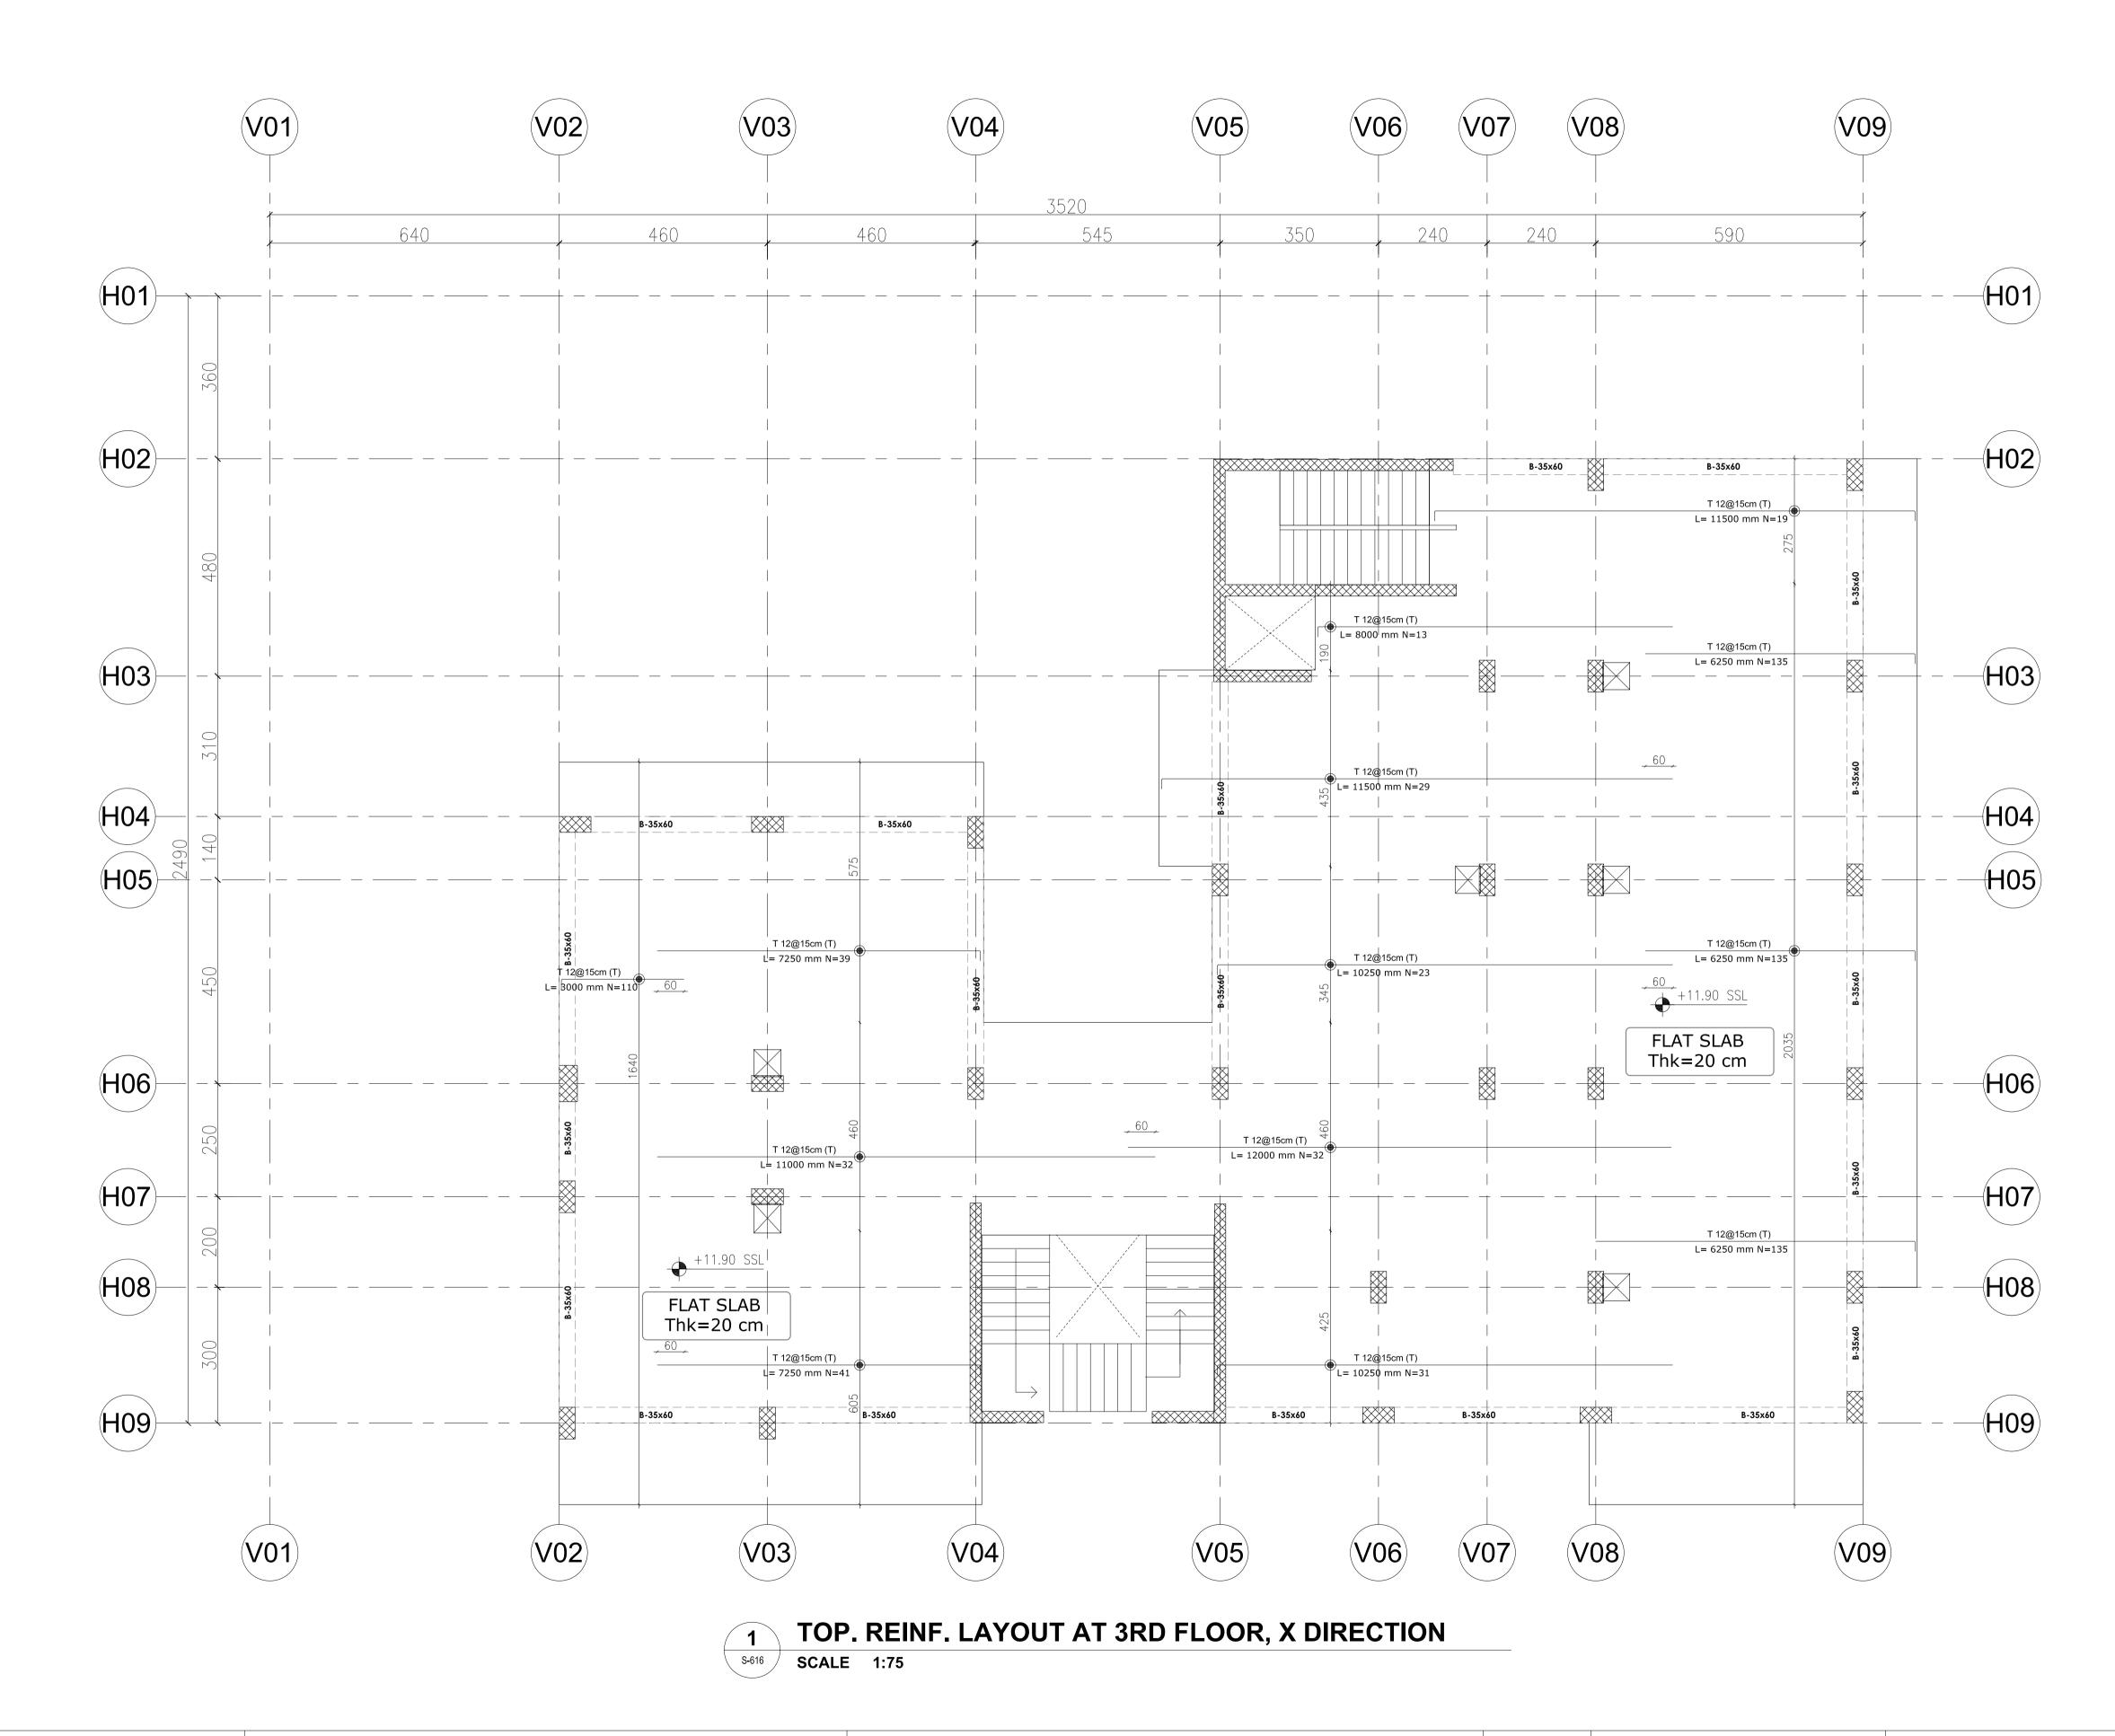

- all dimensions in (cm)

- all levels in meter (m)

YORKVILLE HOTEL & **APARTMENTS LIMITED**

PROJECT TITLE:

CLIENT: **DELOMIS** DESIGNED DRAWN CHECKED SCALE 17 JAN. 2022 DATE


DRAWING TITLE:

TOP. REINF. LAYOUT AT 3RD FLOOR, X DIRECTION

CONSULTANT OFFICE Java Design Concepts LTD



SIZE: A1 DRAWING no:

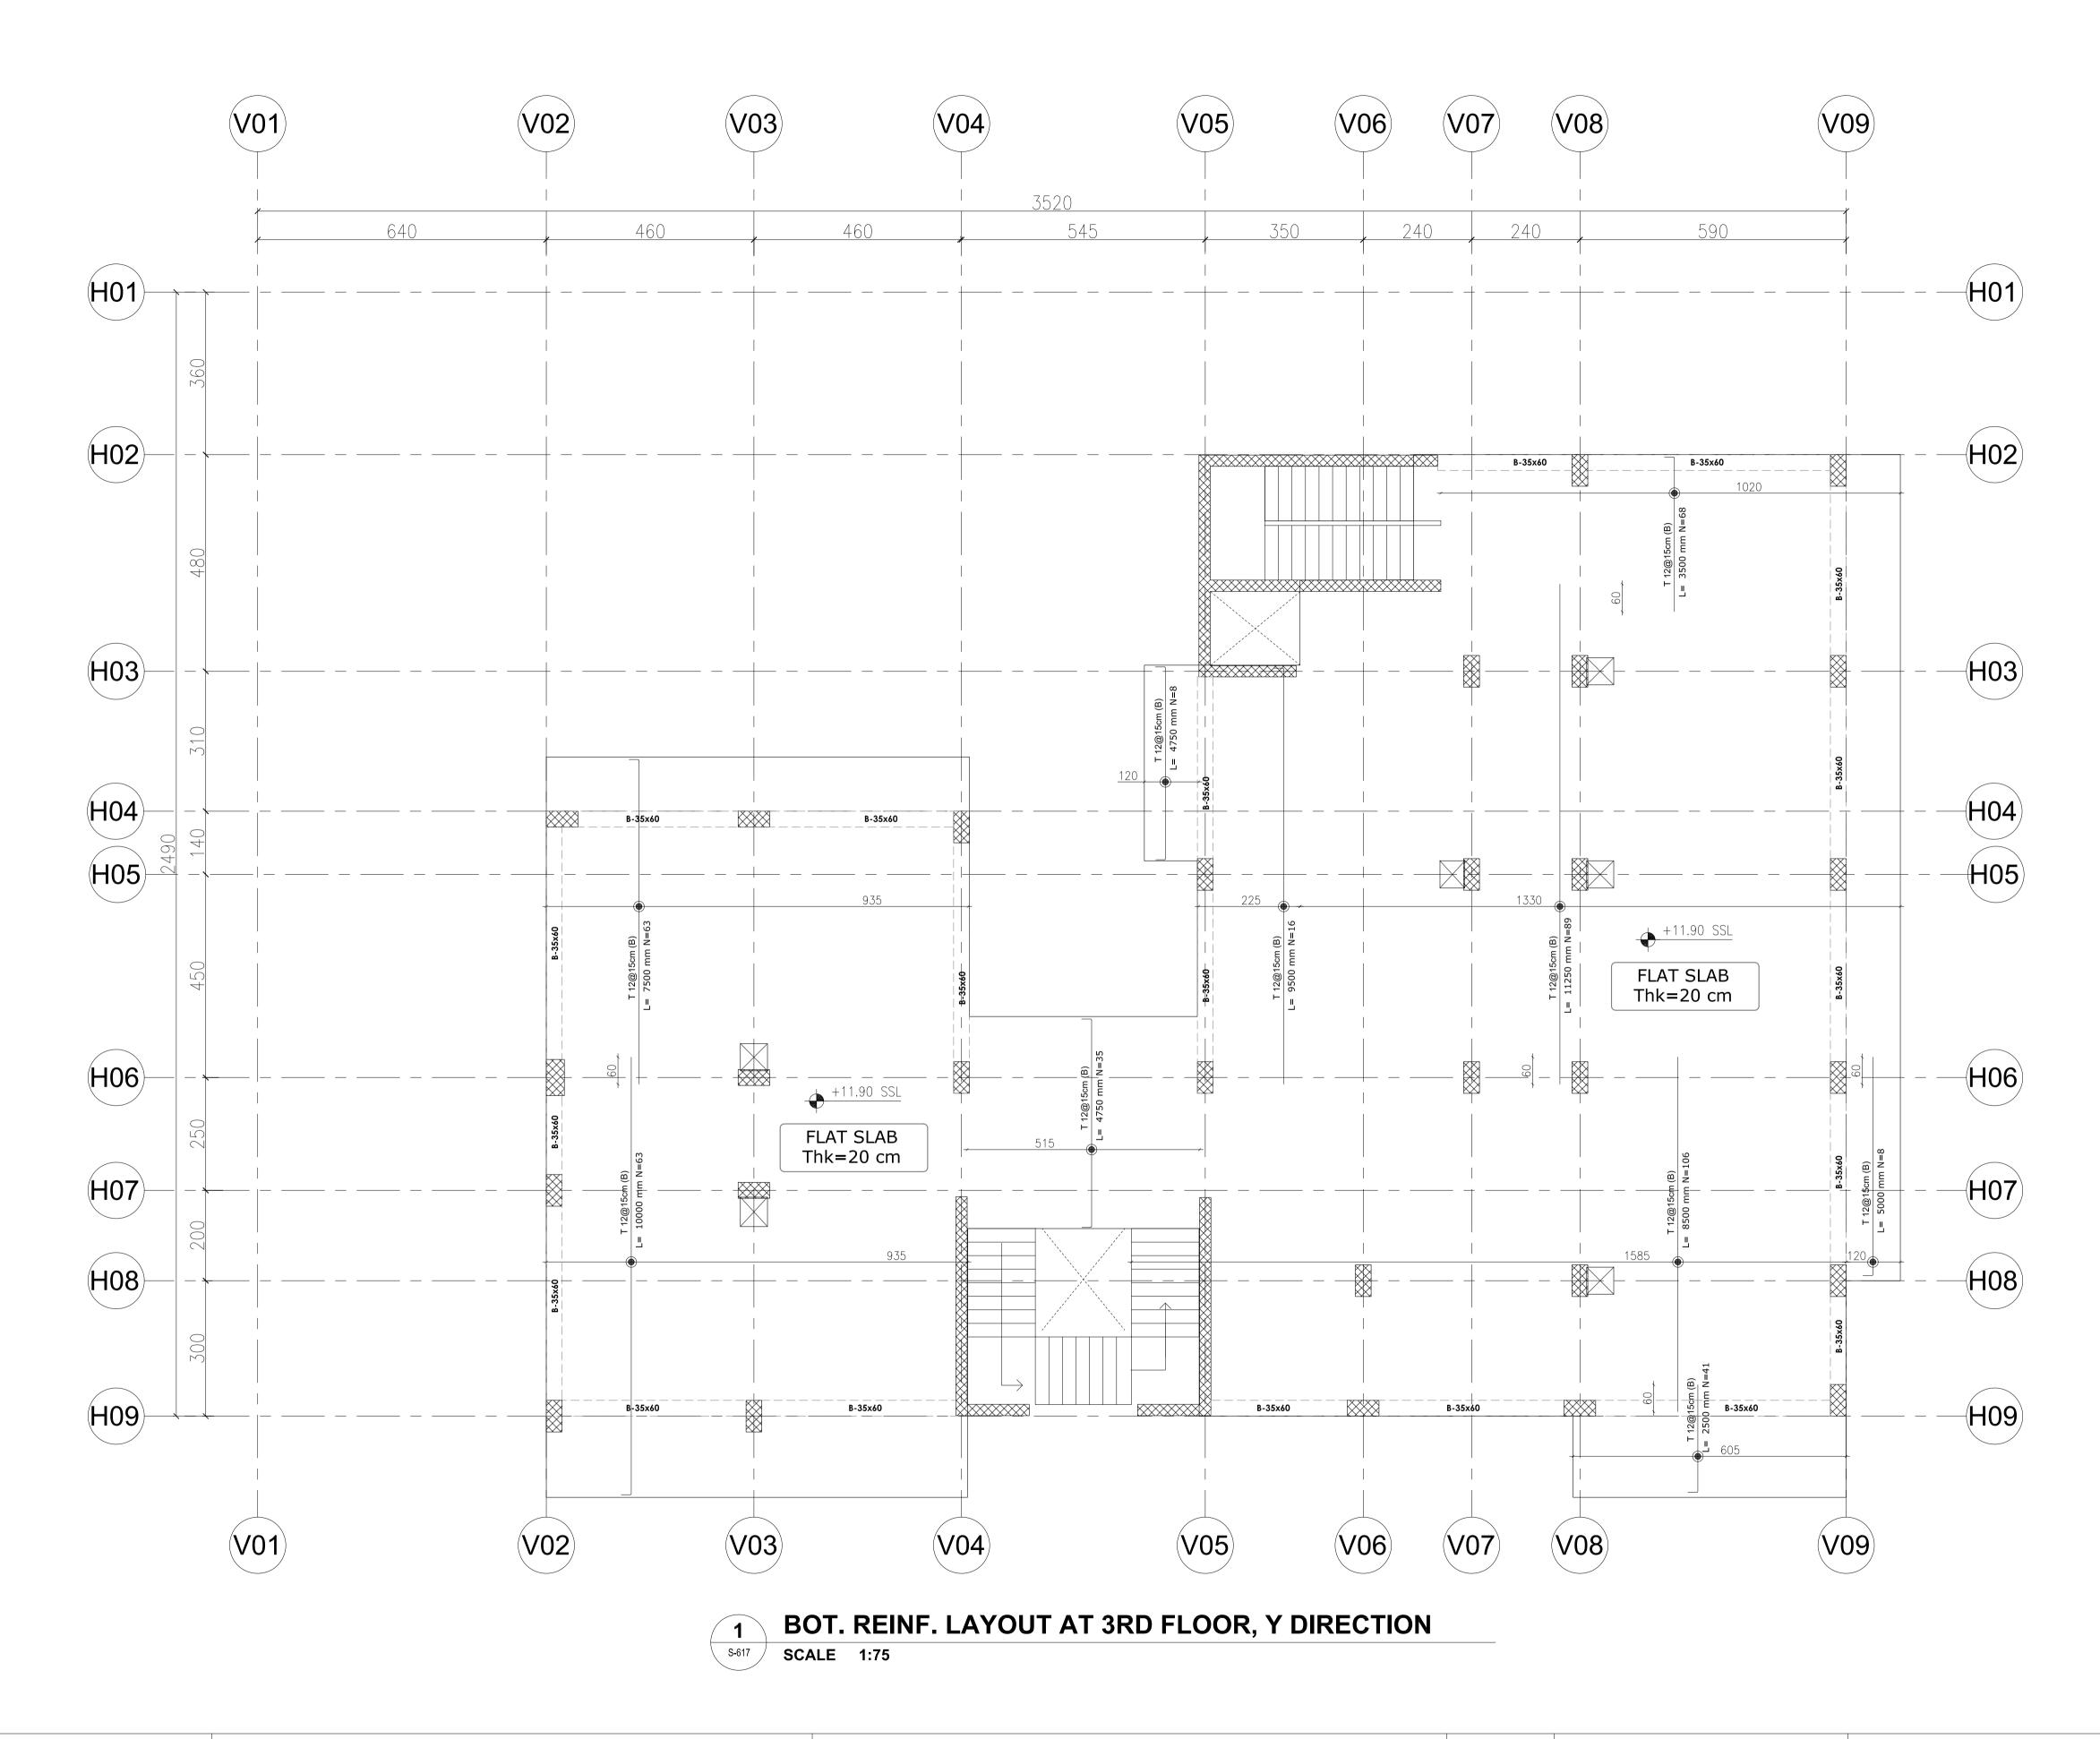

- all dimensions in (cm) - all levels in meter (m)

PROJECT TITLE:

YORKVILLE HOTEL & **APARTMENTS LIMITED**

CLIENT: **DELOMIS** DESIGNED DRAWN CHECKED SCALE 17 JAN. 2022 DATE


DRAWING TITLE:

BOT. REINF. LAYOUT AT 3RD FLOOR, Y DIRECTION

CONSULTANT OFFICE Java Design Concepts LTD



SIZE: A1 DRAWING no:

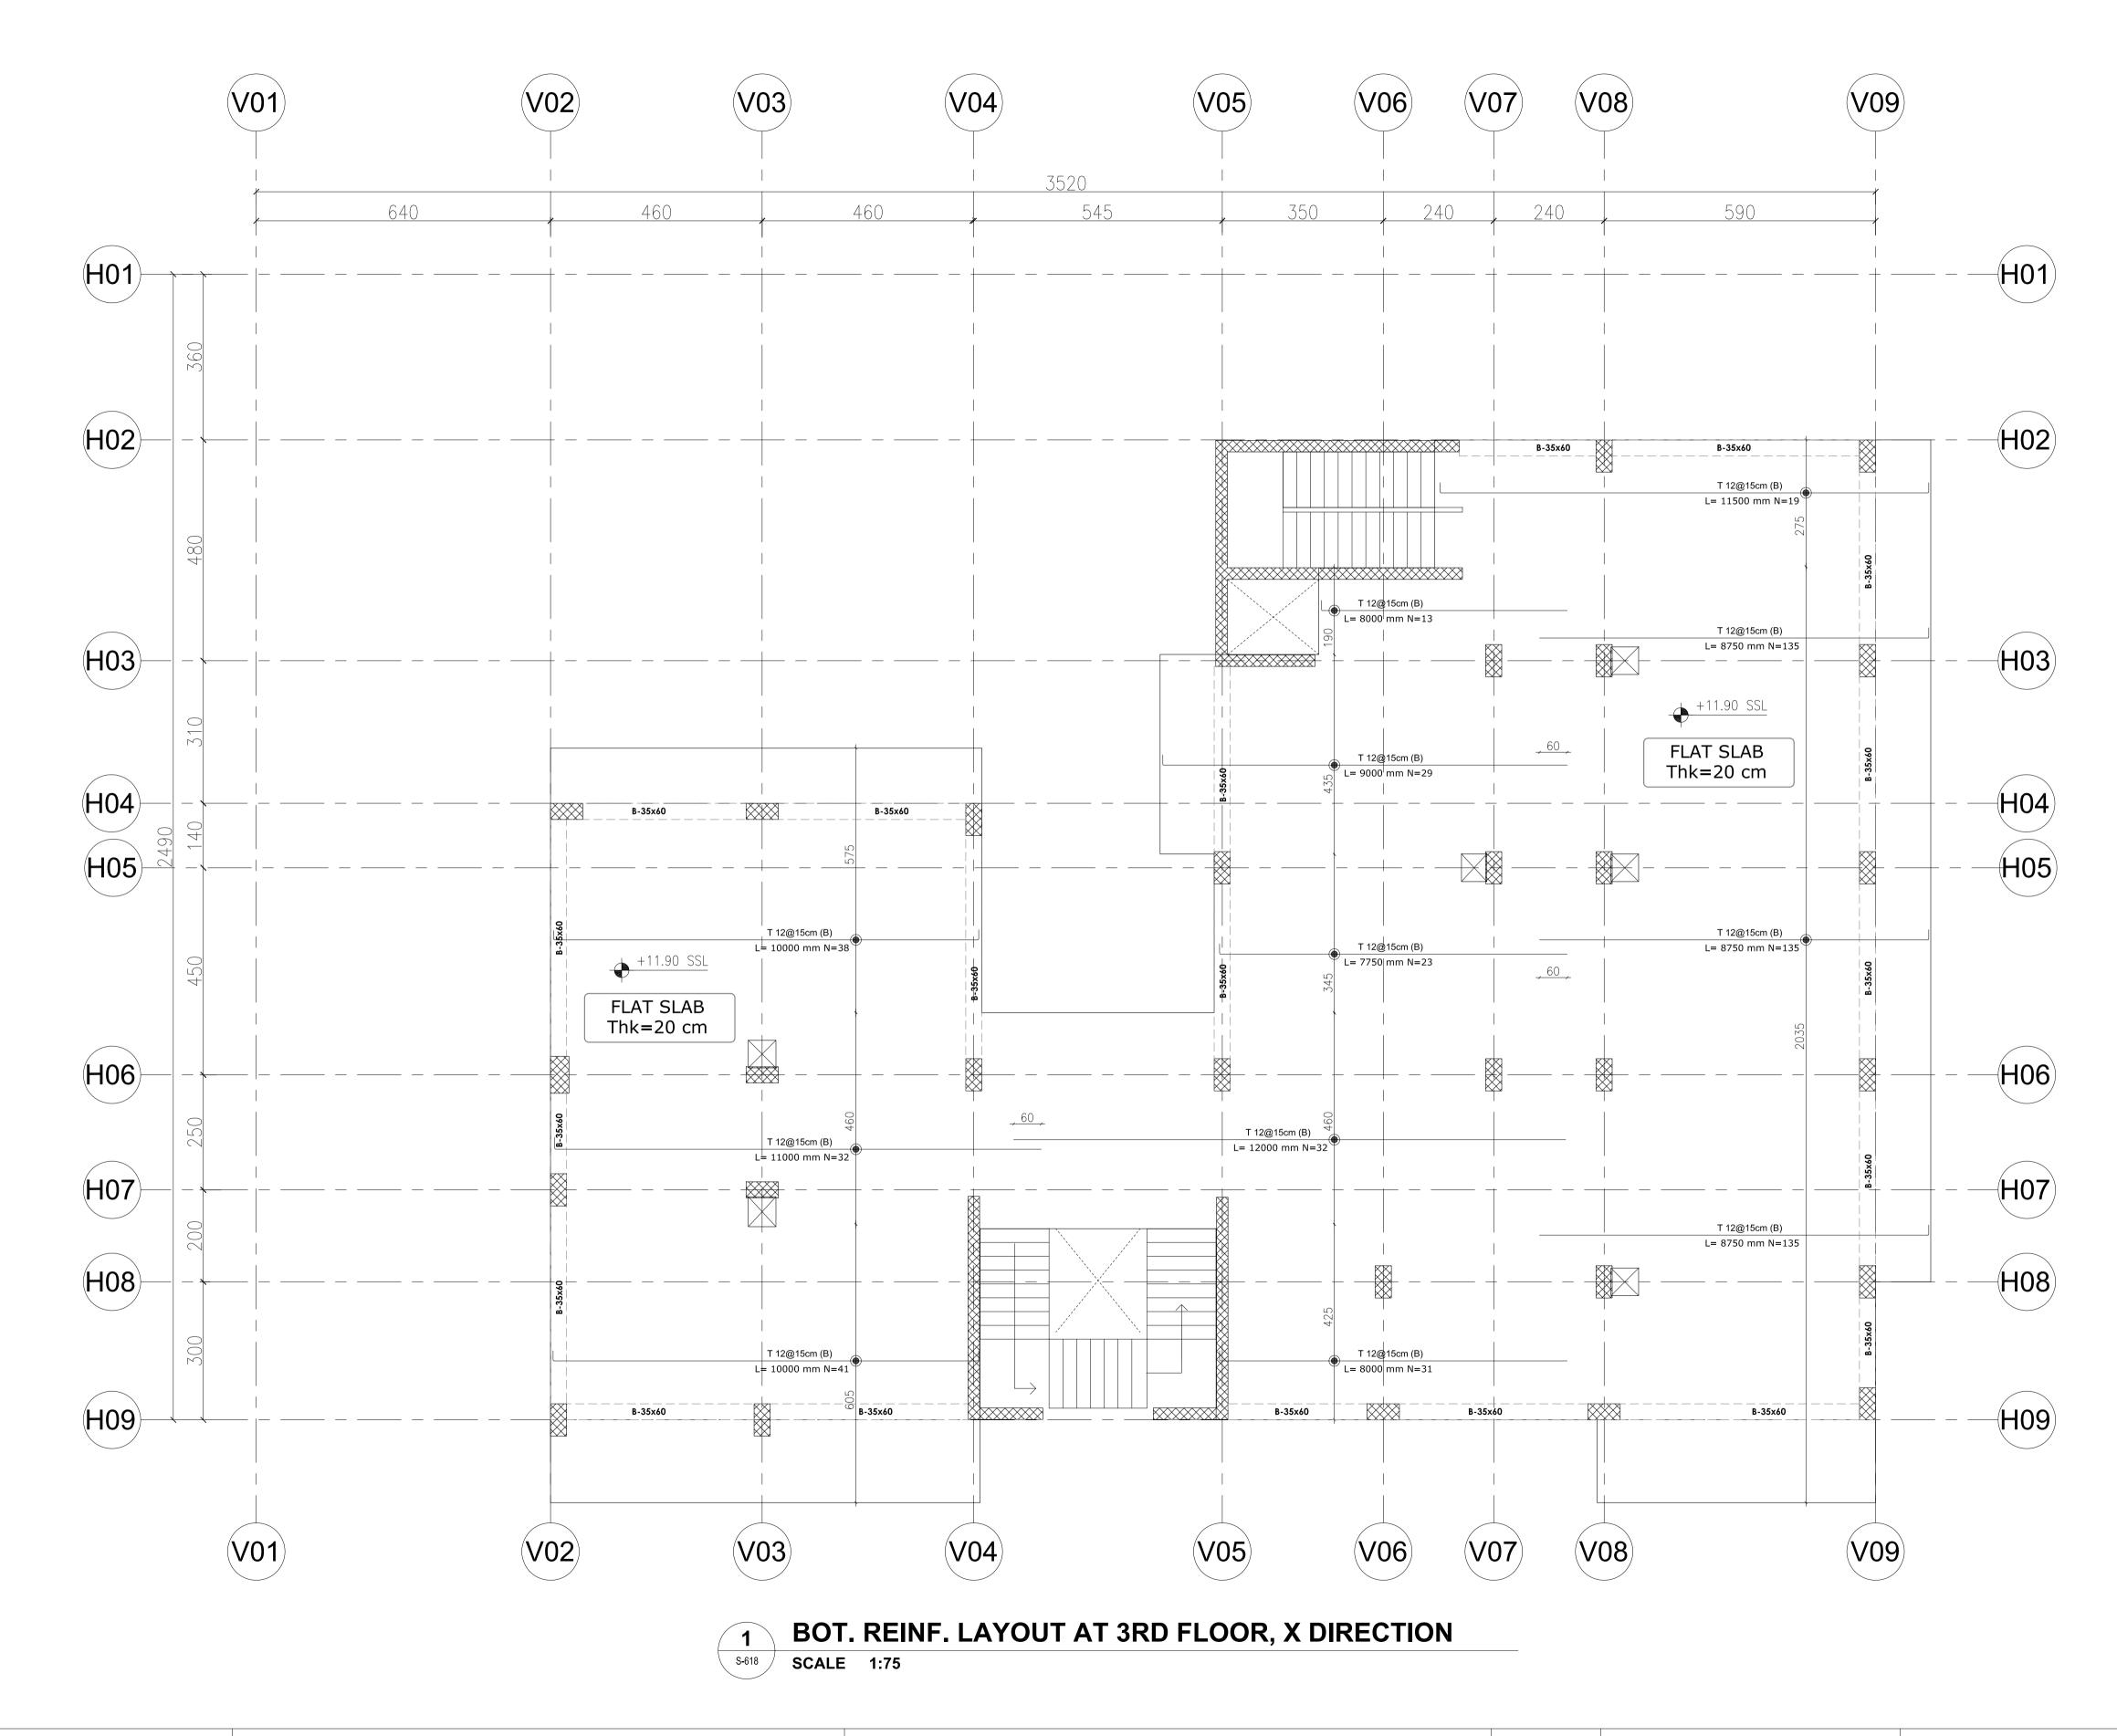

all dimensions in (cm)all levels in meter (m)

YORKVILLE HOTEL & APARTMENTS LIMITED

PROJECT TITLE:

CLIENT:

DELOMIS

DESIGNED

DRAWN

CHECKED

SCALE

DATE

17 JAN. 2022

DRAWING TITLE:

BOT. REINF. LAYOUT AT 3RD FLOOR, X DIRECTION CONSULTANT OFFICE


Java Design Concepts

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SIZE: A1 DRAWING no:





ADDITIONAL BARS SCHEDULE:

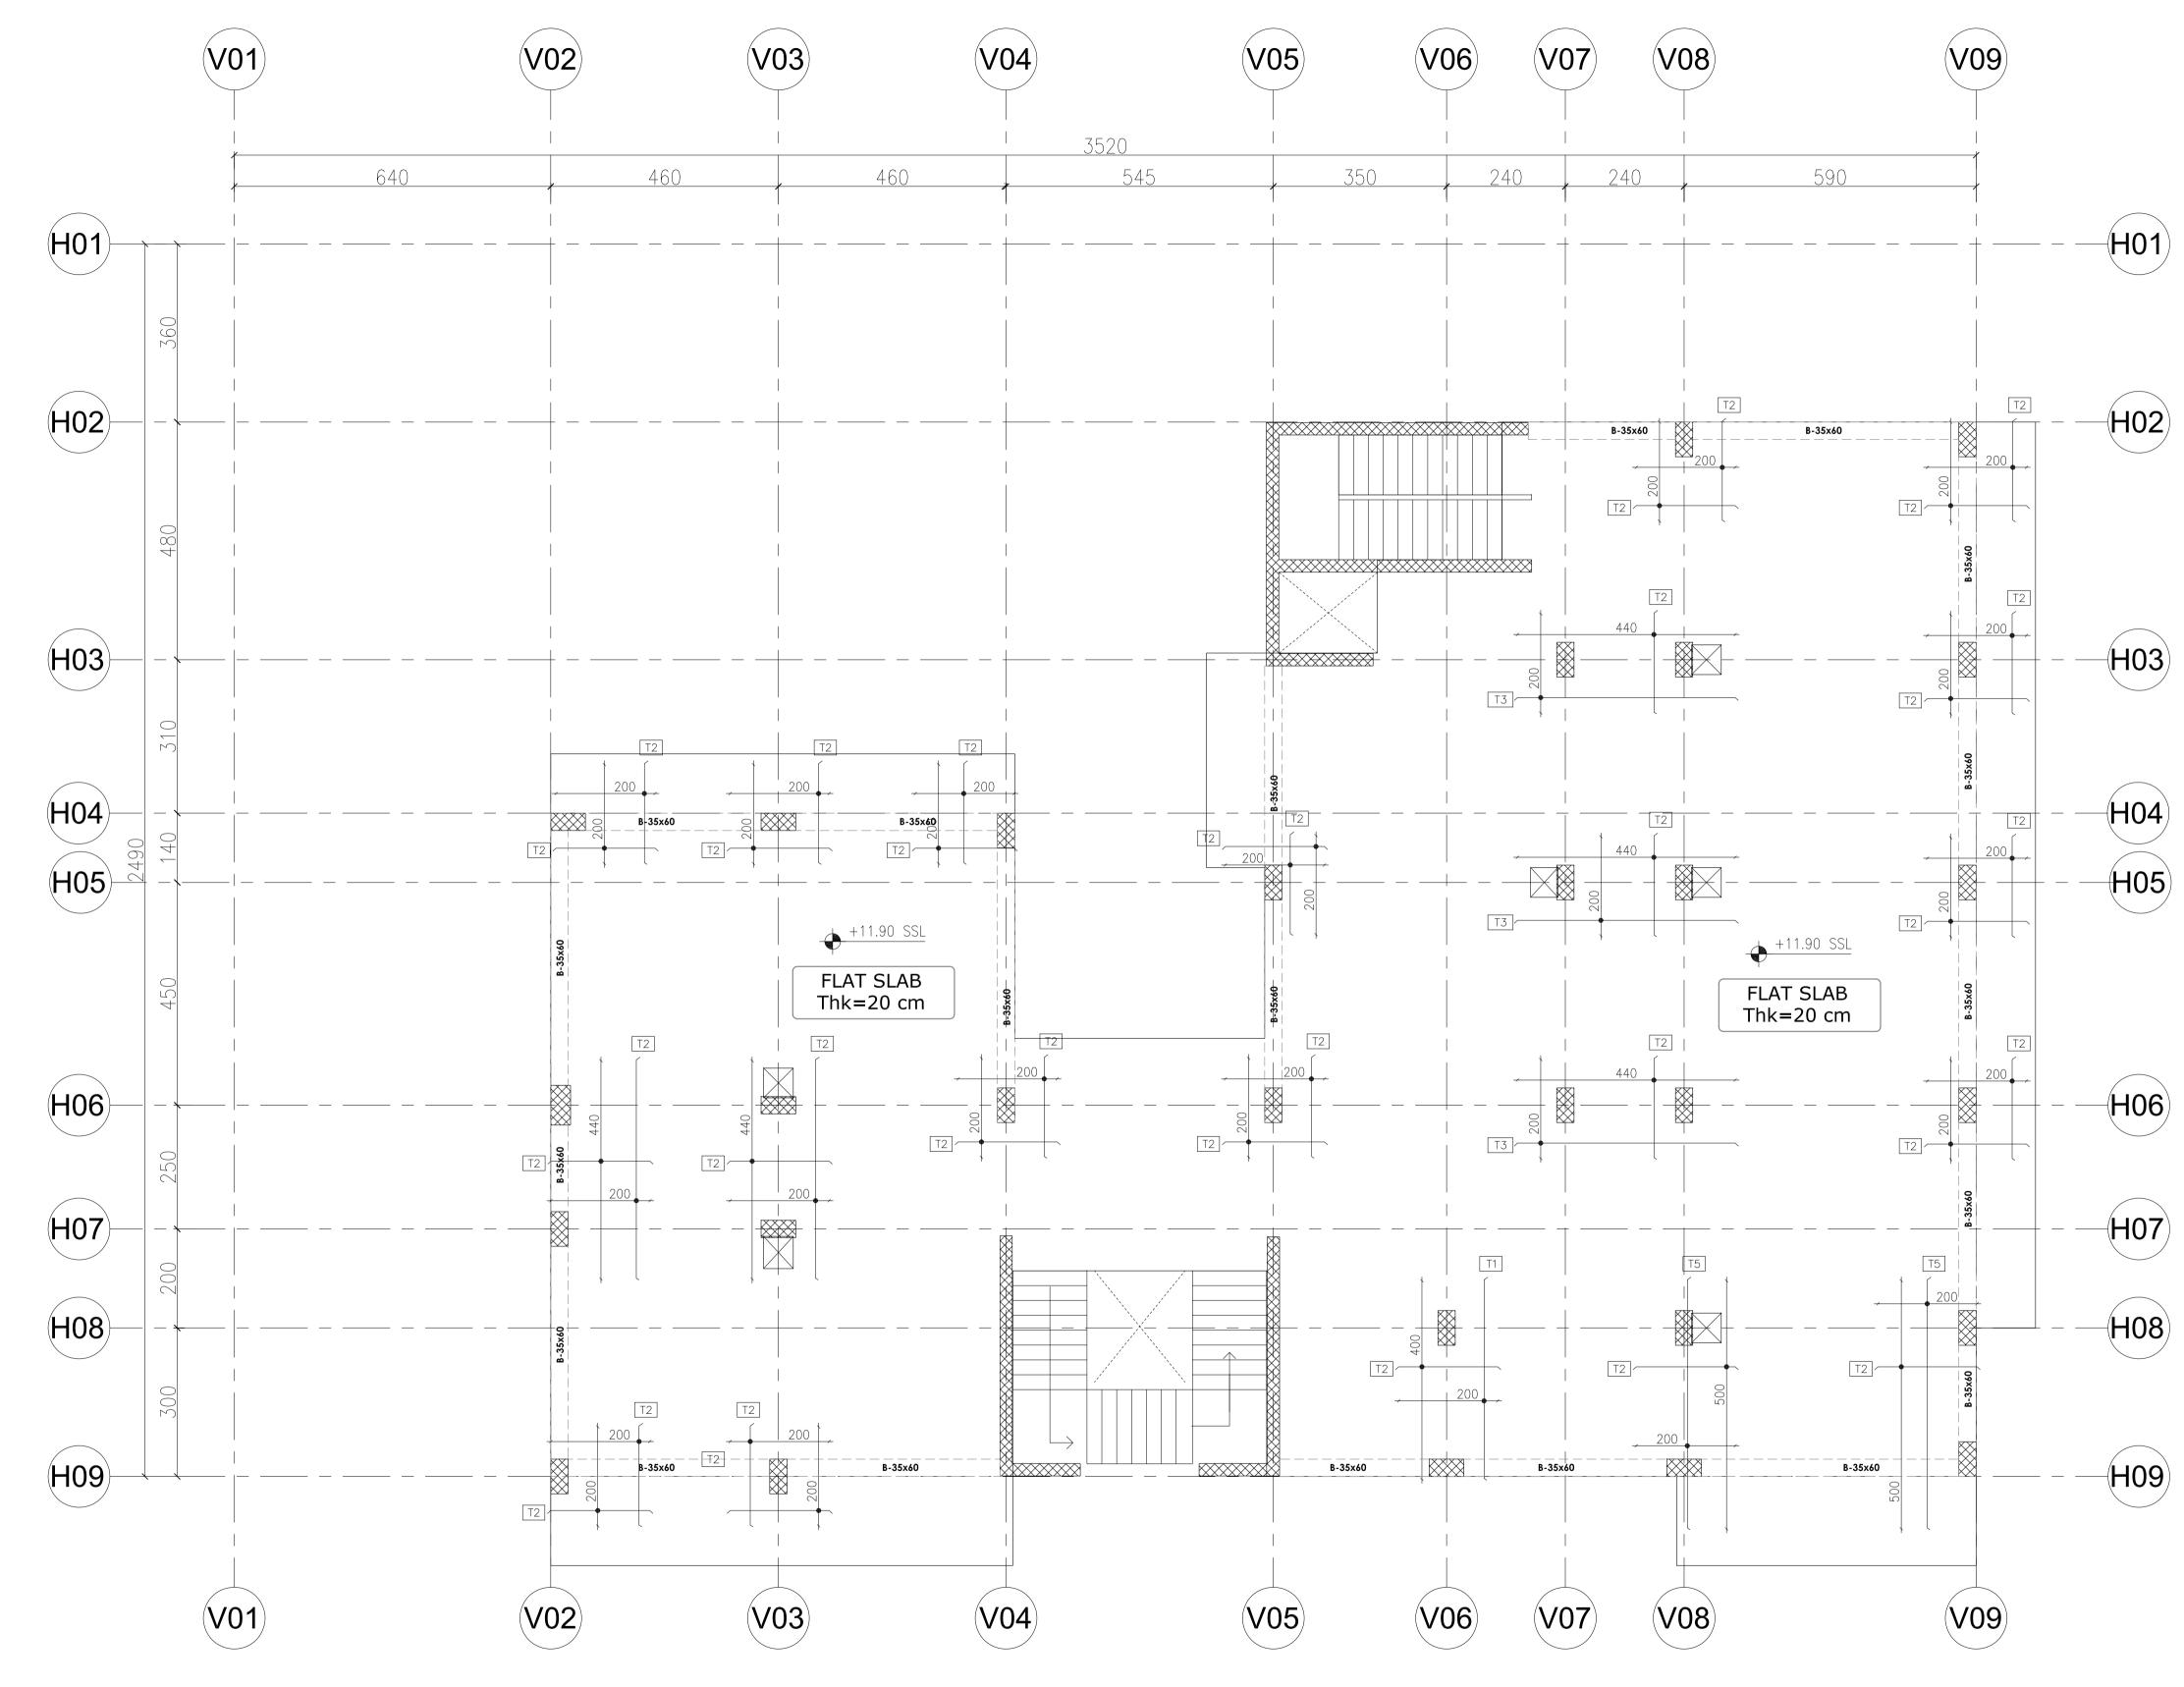TAG	DIMENSIONS	DETAILS	LENGHT
T1	TOP REINF.	T12 @ 15cm	400cm
T2	TOP REINF.	T12 @ 15cm	200cm
T3	TOP REINF.	T12 @ 15cm	440cm
T4	TOP REINF.	T12 @ 15cm	500cm

ADD. REINFORCEMENT LAYOUT AT 3RD FLOOR

S-619 SCALE 1:75

Note:

- all dimensions in (cm)

- all levels in meter (m)

PROJECT TITLE:

YORKVILLE HOTEL & **APARTMENTS LIMITED** CLIENT:

DESIGNED DRAWN **DELOMIS** CHECKED SCALE 17 JAN. 2022


DRAWING TITLE:

ADD. REINFORCEMENT LAYOUT AT 3RD FLOOR CONSULTANT OFFICE

Java Design Concepts LTD



SIZE: A1 DRAWING no:

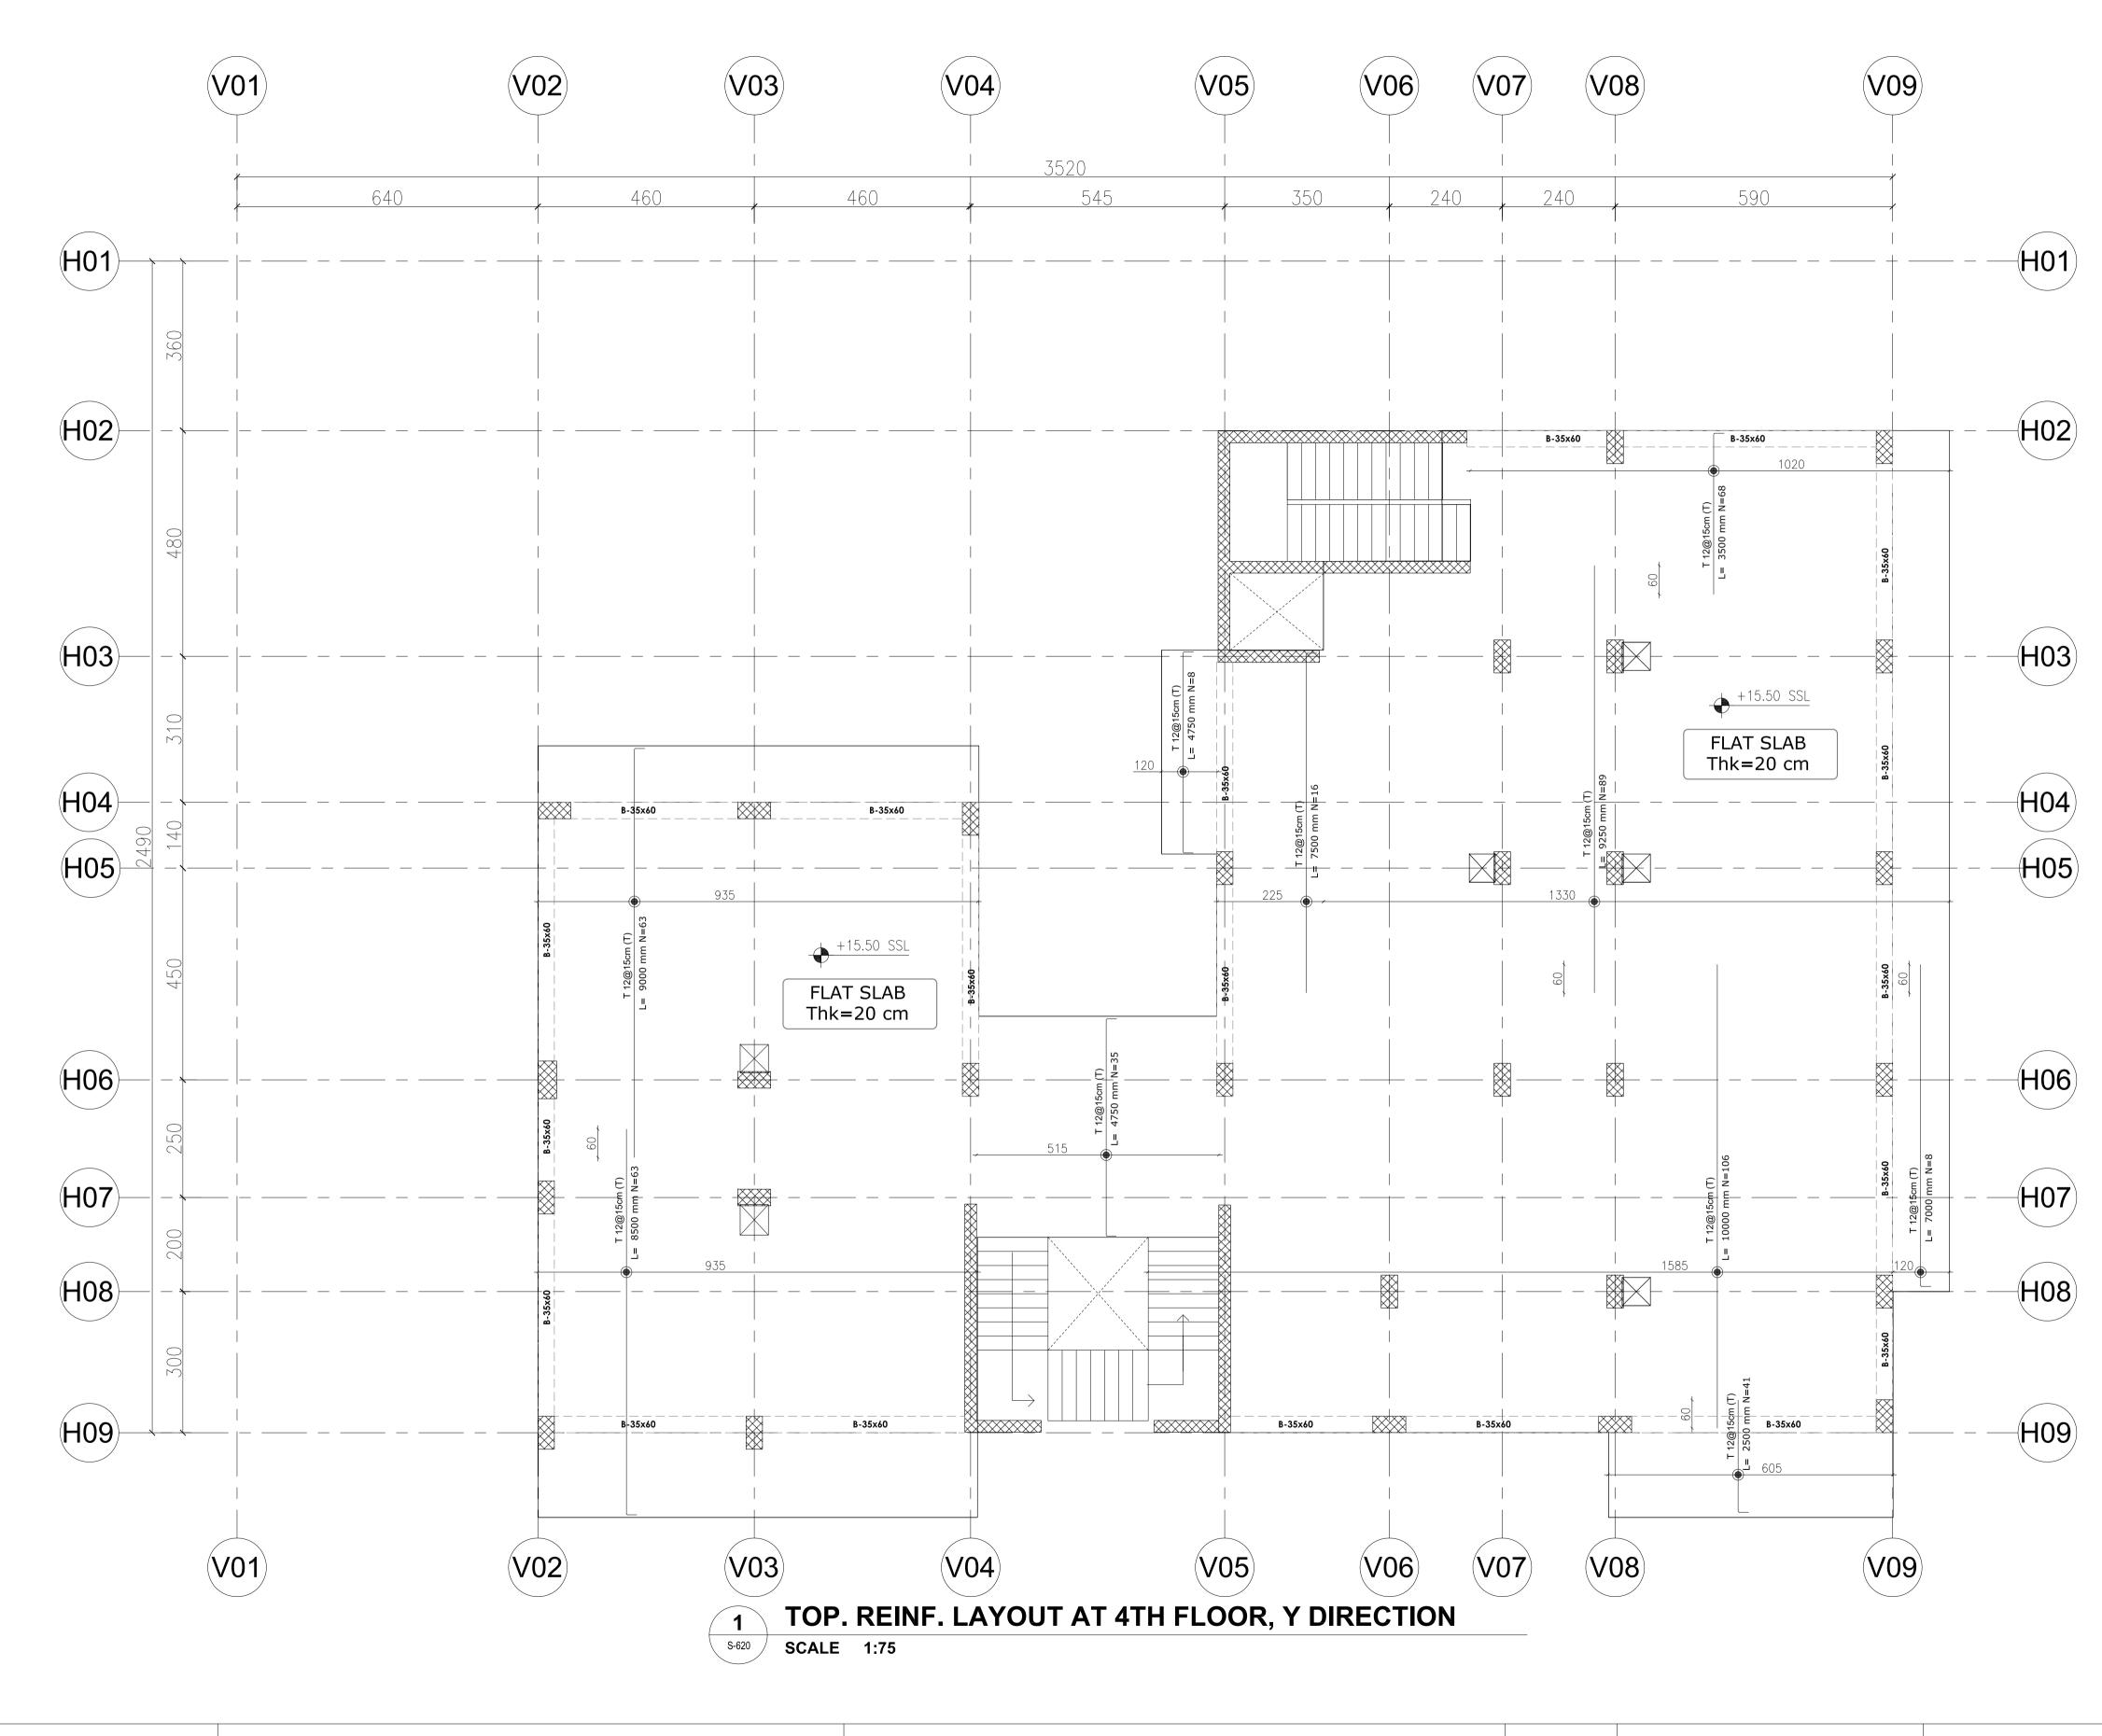

- all dimensions in (cm)

- all levels in meter (m)

PROJECT TITLE:


YORKVILLE HOTEL & **APARTMENTS LIMITED**

CLIENT: **DELOMIS** DESIGNED DRAWN CHECKED SCALE 17 JAN. 2022

DRAWING TITLE:


TOP. REINF. LAYOUT AT 4TH FLOOR, Y DIRECTION

CONSULTANT OFFICE

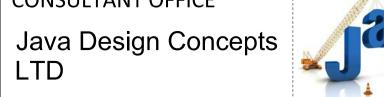

DRAWING no: SIZE: A1



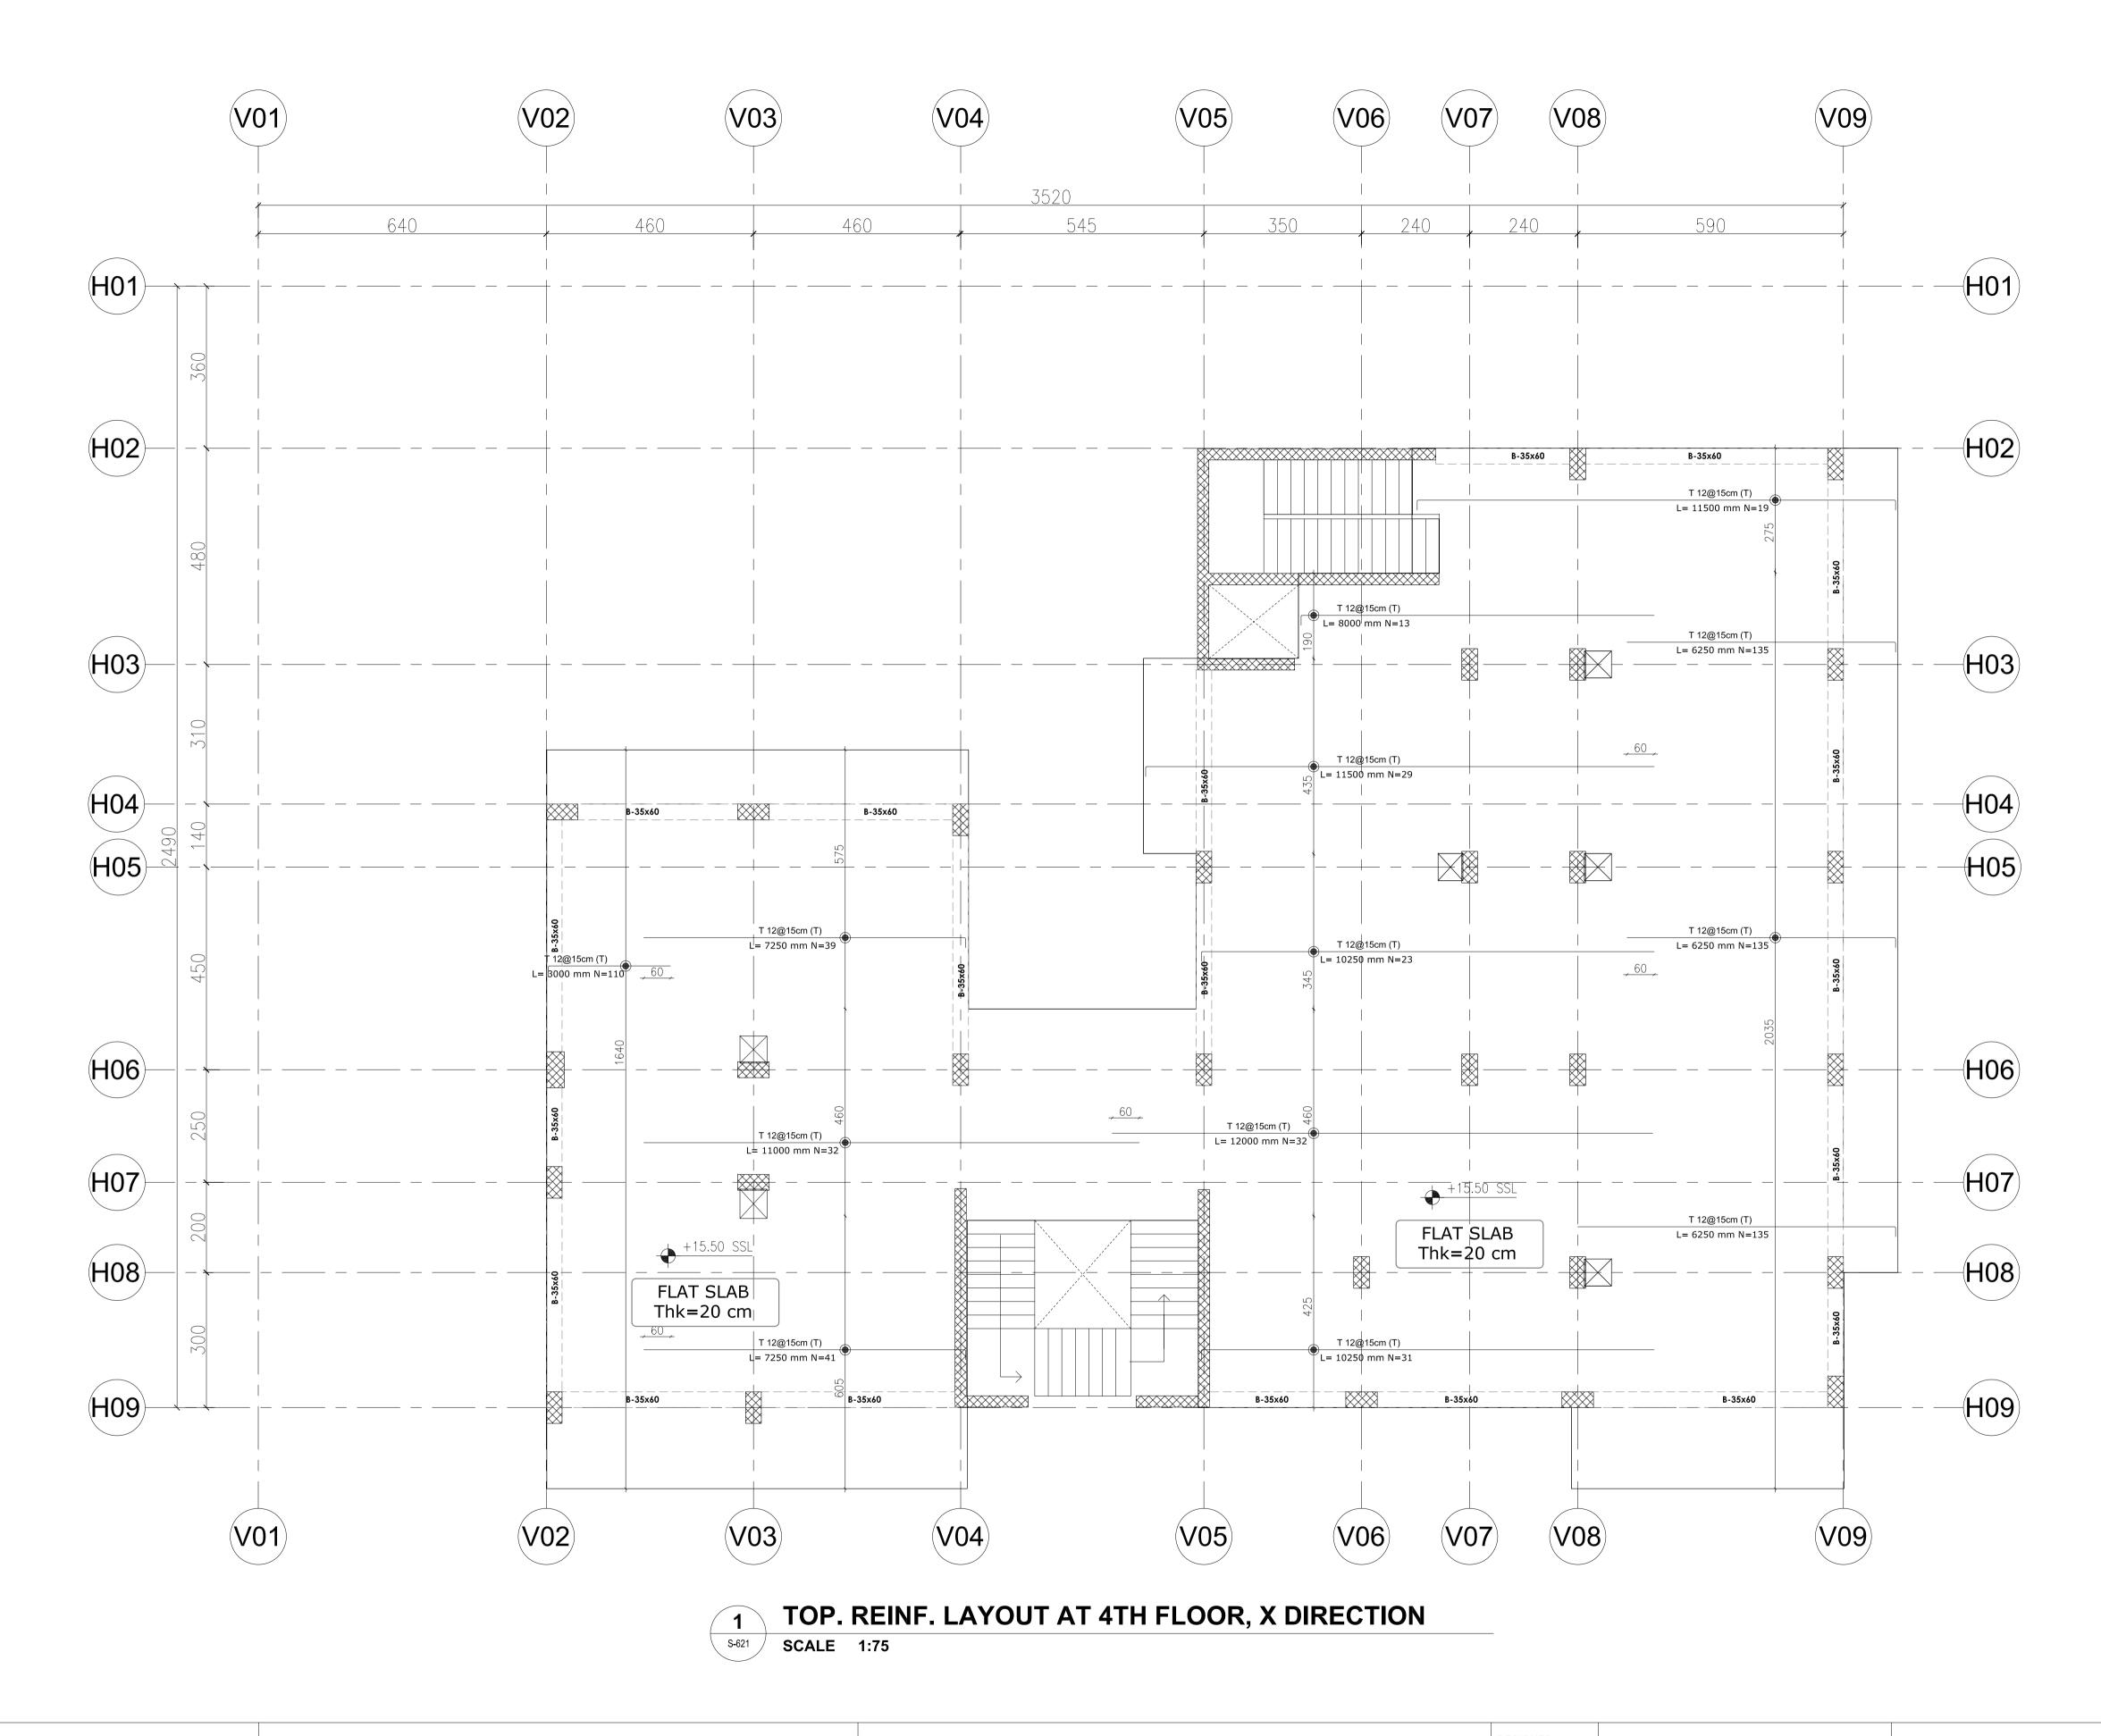

- all dimensions in (cm)

- all levels in meter (m)

PROJECT TITLE:

YORKVILLE HOTEL & **APARTMENTS LIMITED**


CLIENT: **DELOMIS** DESIGNED DRAWN CHECKED SCALE 17 JAN. 2022 DATE

DRAWING TITLE:


TOP. REINF. LAYOUT AT 4TH FLOOR, X DIRECTION

CONSULTANT OFFICE

Java Design Concepts LTD

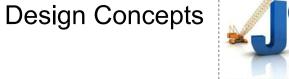

SIZE: A1 DRAWING no:

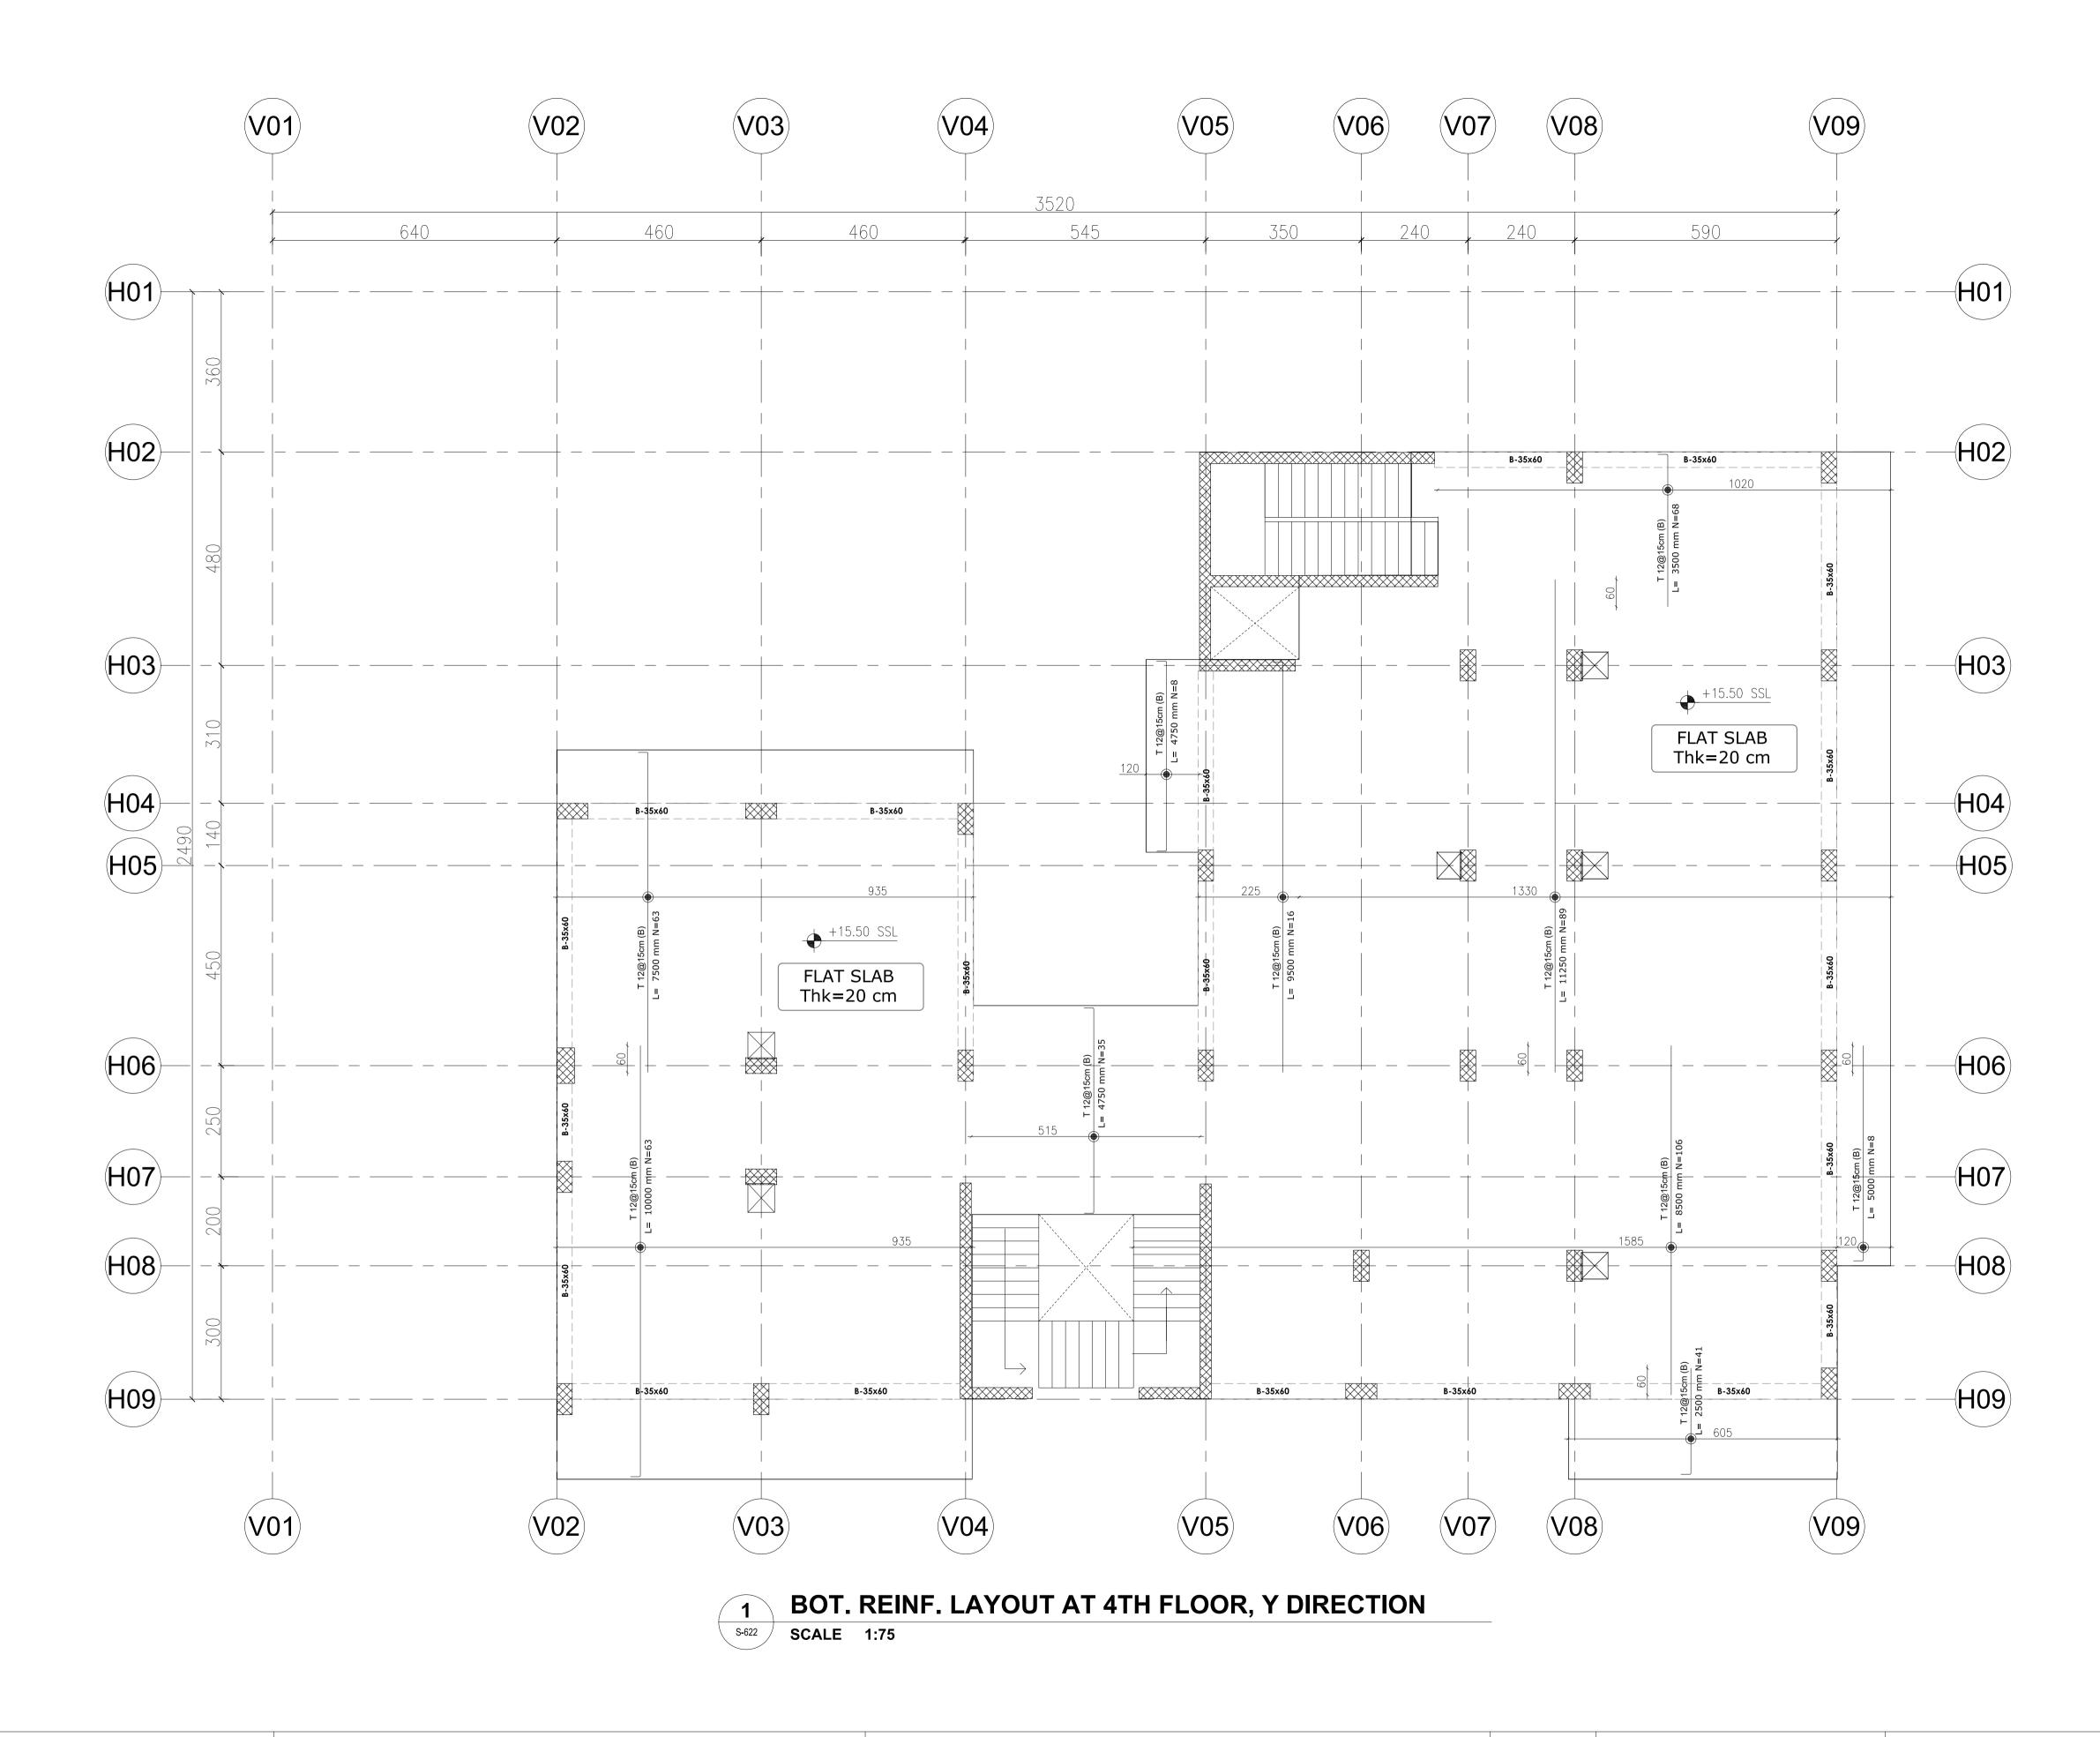

- all dimensions in (cm)

- all levels in meter (m)

PROJECT TITLE:

YORKVILLE HOTEL & **APARTMENTS LIMITED**

CLIENT: **DELOMIS** DESIGNED DRAWN CHECKED SCALE 17 JAN. 2022 DATE


DRAWING TITLE:

BOT. REINF. LAYOUT AT 4TH FLOOR, Y DIRECTION

CONSULTANT OFFICE

Java Design Concepts LTD

DRAWING no: SIZE: A1

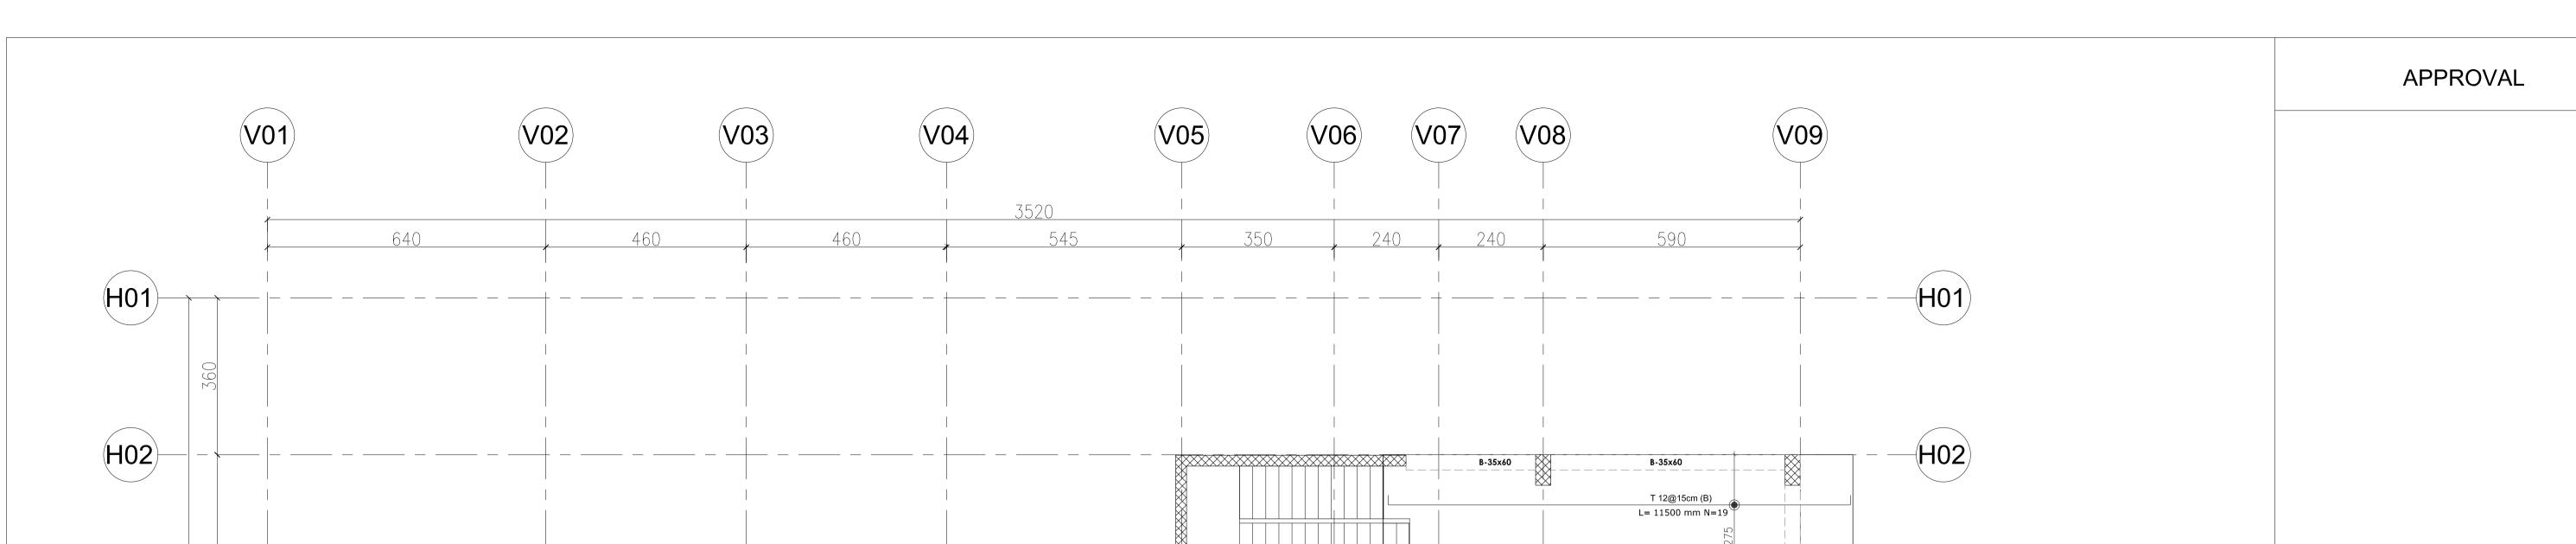

T 12@15cm (B) L= 8000 mm N=13 T 12@15cm (B) L= 8750 mm N=135 +15.50 SSL FLAT SLAB T 12@15cm (B) Thk=20 cm L= 9000^l mm N=29 B-35x60 T 12@15cm (B) T 12@15cm (B) L= 10000 mm N=38 T 12@15cm (B) L= 8750 mm N=135 +15.50 SSL L= 7750|mm N=23 _ 60 _ FLAT SLAB Thk=20 cm (H06) H06 T 12@15cm (B) T 12@15cm (B) L= 11000 mm N=32 L= 12000 mm N=32 (H07) H07 T 12@15cm (B) L= 8750 mm N=135 H08 (80H) T 12@15cm (B) L= 8000 mm N=31 T 12@15cm (B) L= 10000 mm N=41 H09 H09 B-35x60 B-35x60 B-35x60 (V01) **V02** (V03) (V08) **V09** (V04) (V05) (V07) (V06)

BOT. REINF. LAYOUT AT 4TH FLOOR, X DIRECTION S-623 SCALE 1:75

Note:

- all dimensions in (cm)

- all levels in meter (m)

PROJECT TITLE:

YORKVILLE HOTEL & **APARTMENTS LIMITED**

CLIENT: **DELOMIS** DESIGNED DRAWN CHECKED DIRECTION SCALE 17 JAN. 2022 DATE


DRAWING TITLE: BOT. REINF. LAYOUT AT 4TH FLOOR, X

Java Design Concepts LTD



SIZE: A1 DRAWING no:

CONSULTANT OFFICE

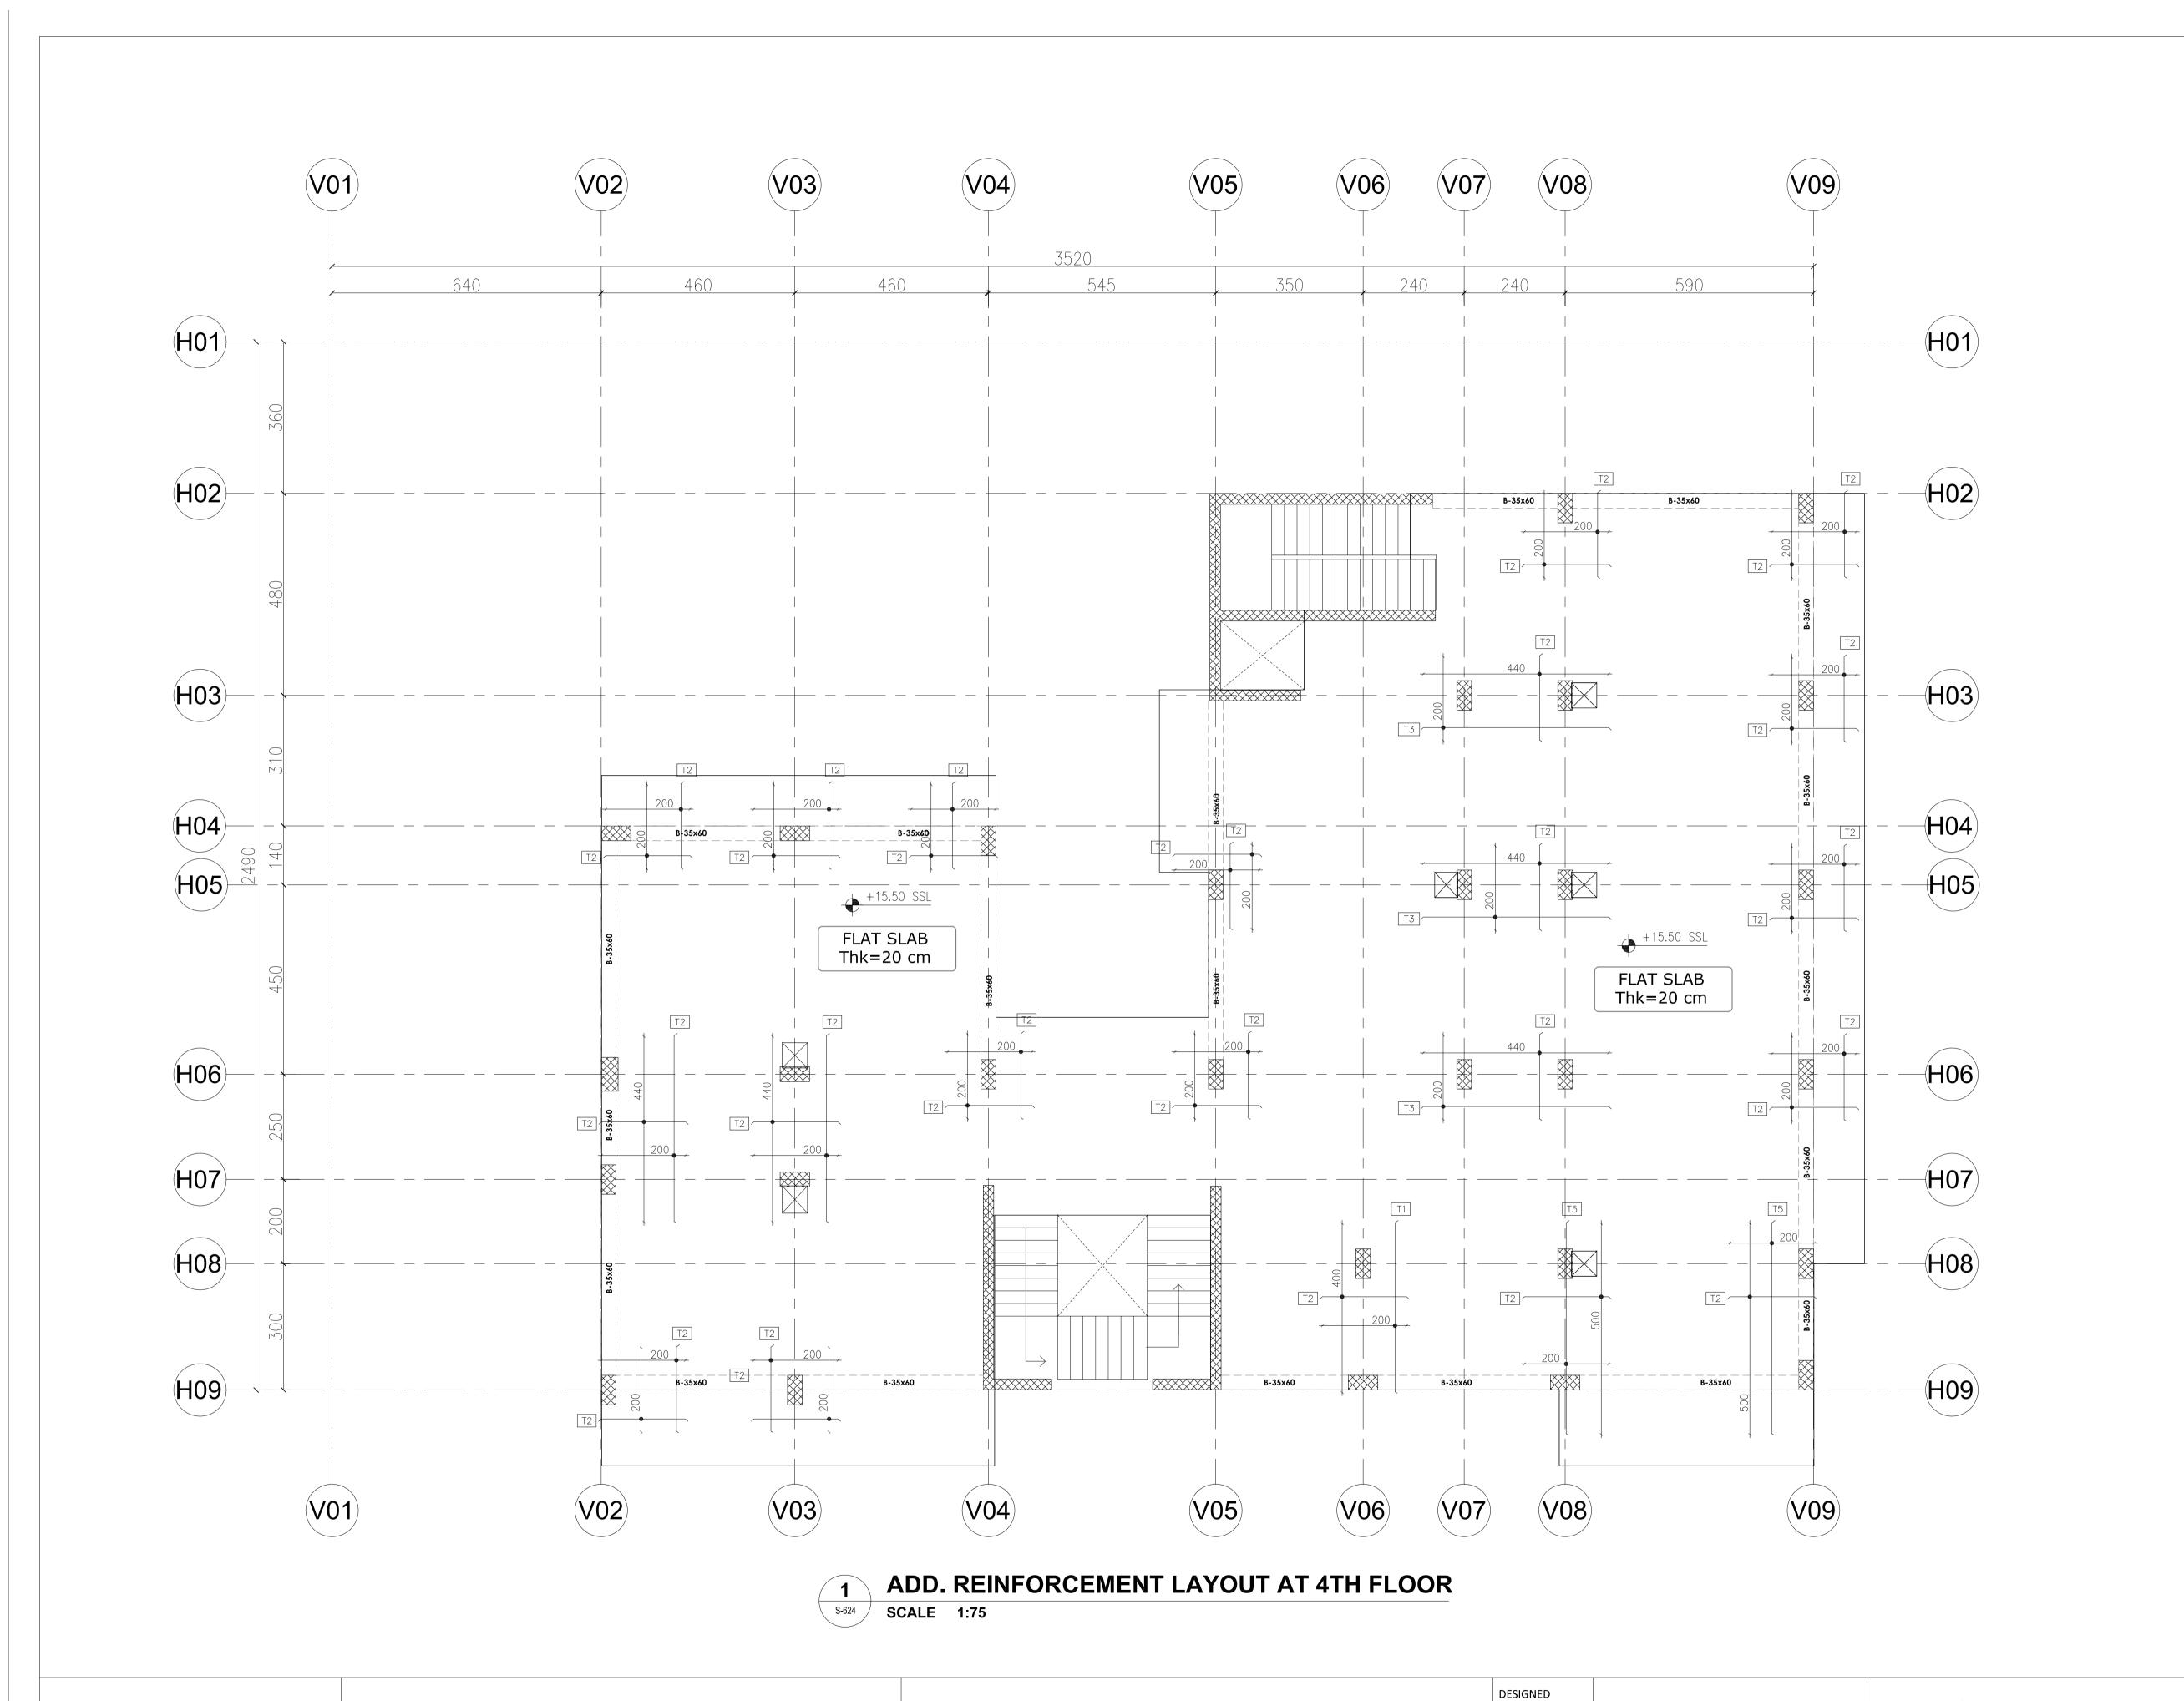

APPROVAL

ADDITIONAL BARS SCHEDULE:

TAG	DIMENSIONS	DETAILS	LENGHT
T1	TOP REINF.	T12 @ 15cm	400cm
T2	TOP REINF.	T12 @ 15cm	200cm
T3	TOP REINF.	T12 @ 15cm	440cm
T4	TOP REINF.	T12 @ 15cm	500cm

CONSULTANT OFFICE DRAWING TITLE:

Java Design Concepts LTD

S-624

SIZE: A1 DRAWING no:

CHECKED

17 JAN. 2022

DRAWN

SCALE

DATE

ADD. REINFORCEMENT LAYOUT AT 4TH FLOOR


- all dimensions in (cm) - all levels in meter (m)

Note:

PROJECT TITLE:

YORKVILLE HOTEL & **APARTMENTS LIMITED** **DELOMIS**

CLIENT:

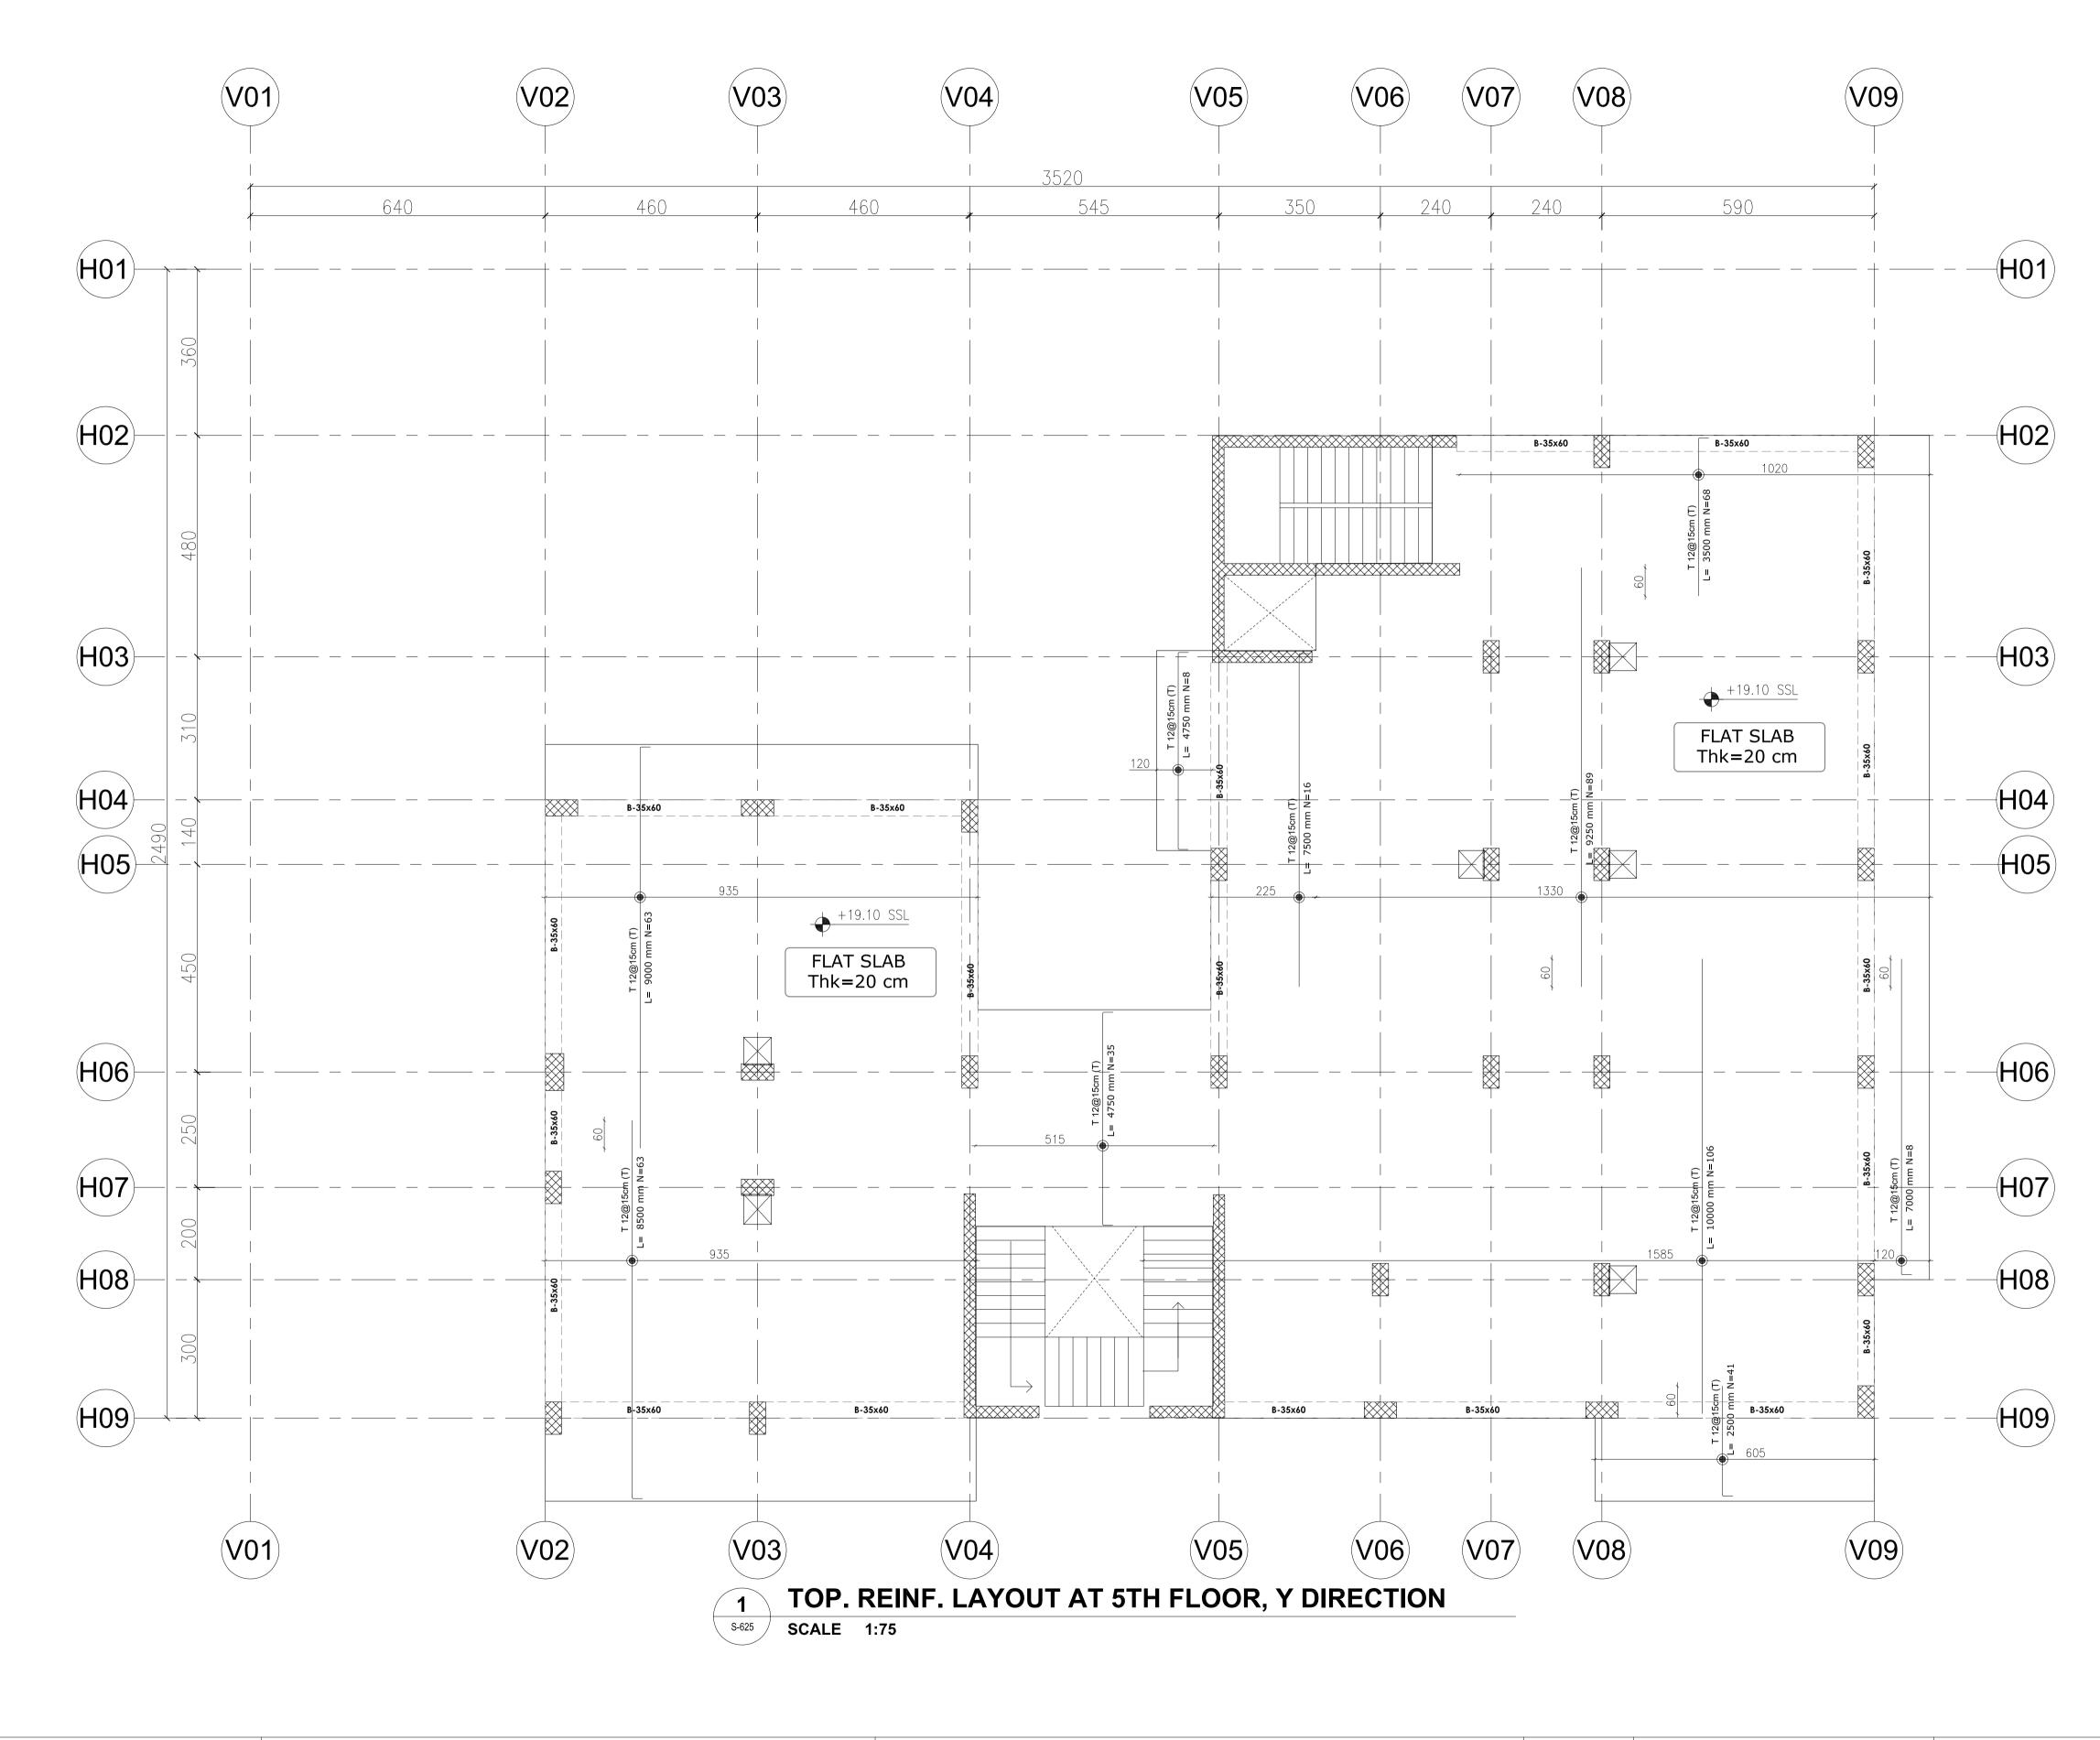

- all dimensions in (cm)

- all levels in meter (m)

PROJECT TITLE: YORKVILLE HOTEL &

APARTMENTS LIMITED

CLIENT:

DELOMIS

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SCALE		
DATE	17 JAN. 2022	


DRAWING TITLE:

TOP. REINF. LAYOUT AT 5TH FLOOR, Y DIRECTION

CONSULTANT OFFICE Java Design Concepts LTD



DRAWING no: SIZE: A1

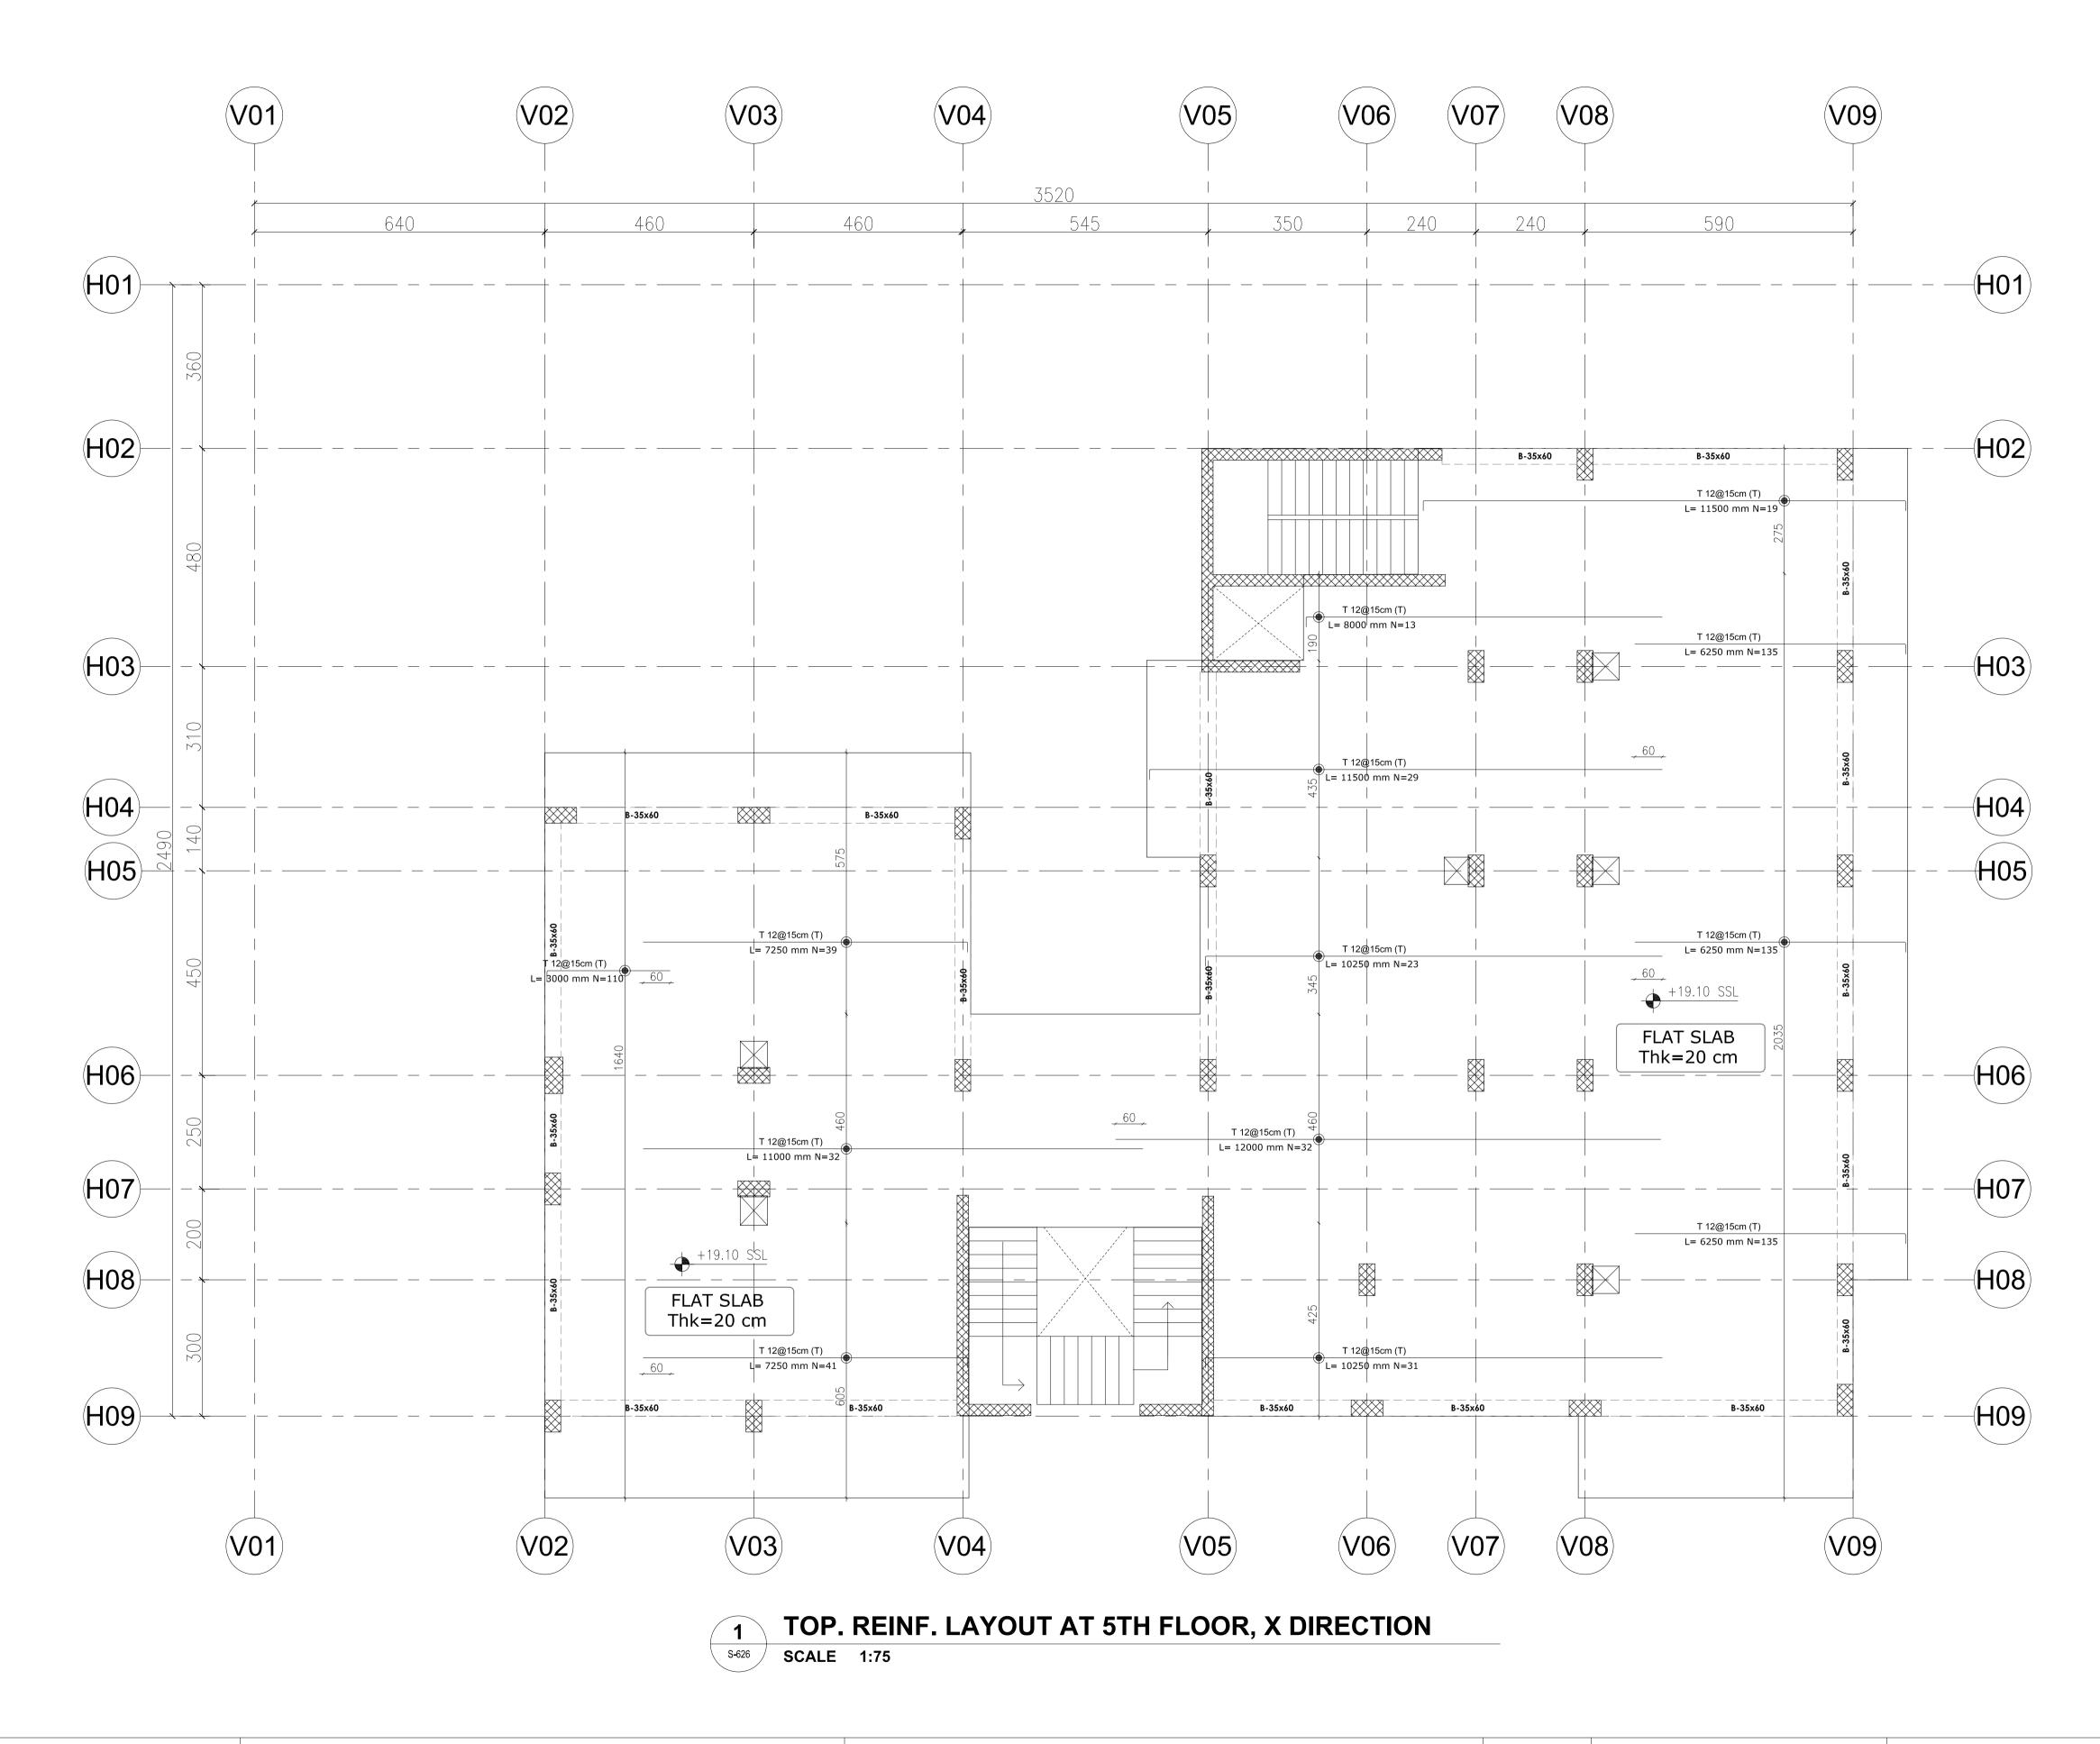

- all dimensions in (cm)

- all levels in meter (m)

PROJECT TITLE: YORKVILLE HOTEL & **APARTMENTS LIMITED** CLIENT:

DELOMIS

DESIGNED		
DRAWN		
CHECKED		
SCALE		
DATE	17 JAN. 2022	


DRAWING TITLE:

TOP. REINF. LAYOUT AT 5TH FLOOR, X DIRECTION

CONSULTANT OFFICE Java Design Concepts LTD



SIZE: A1 DRAWING no:

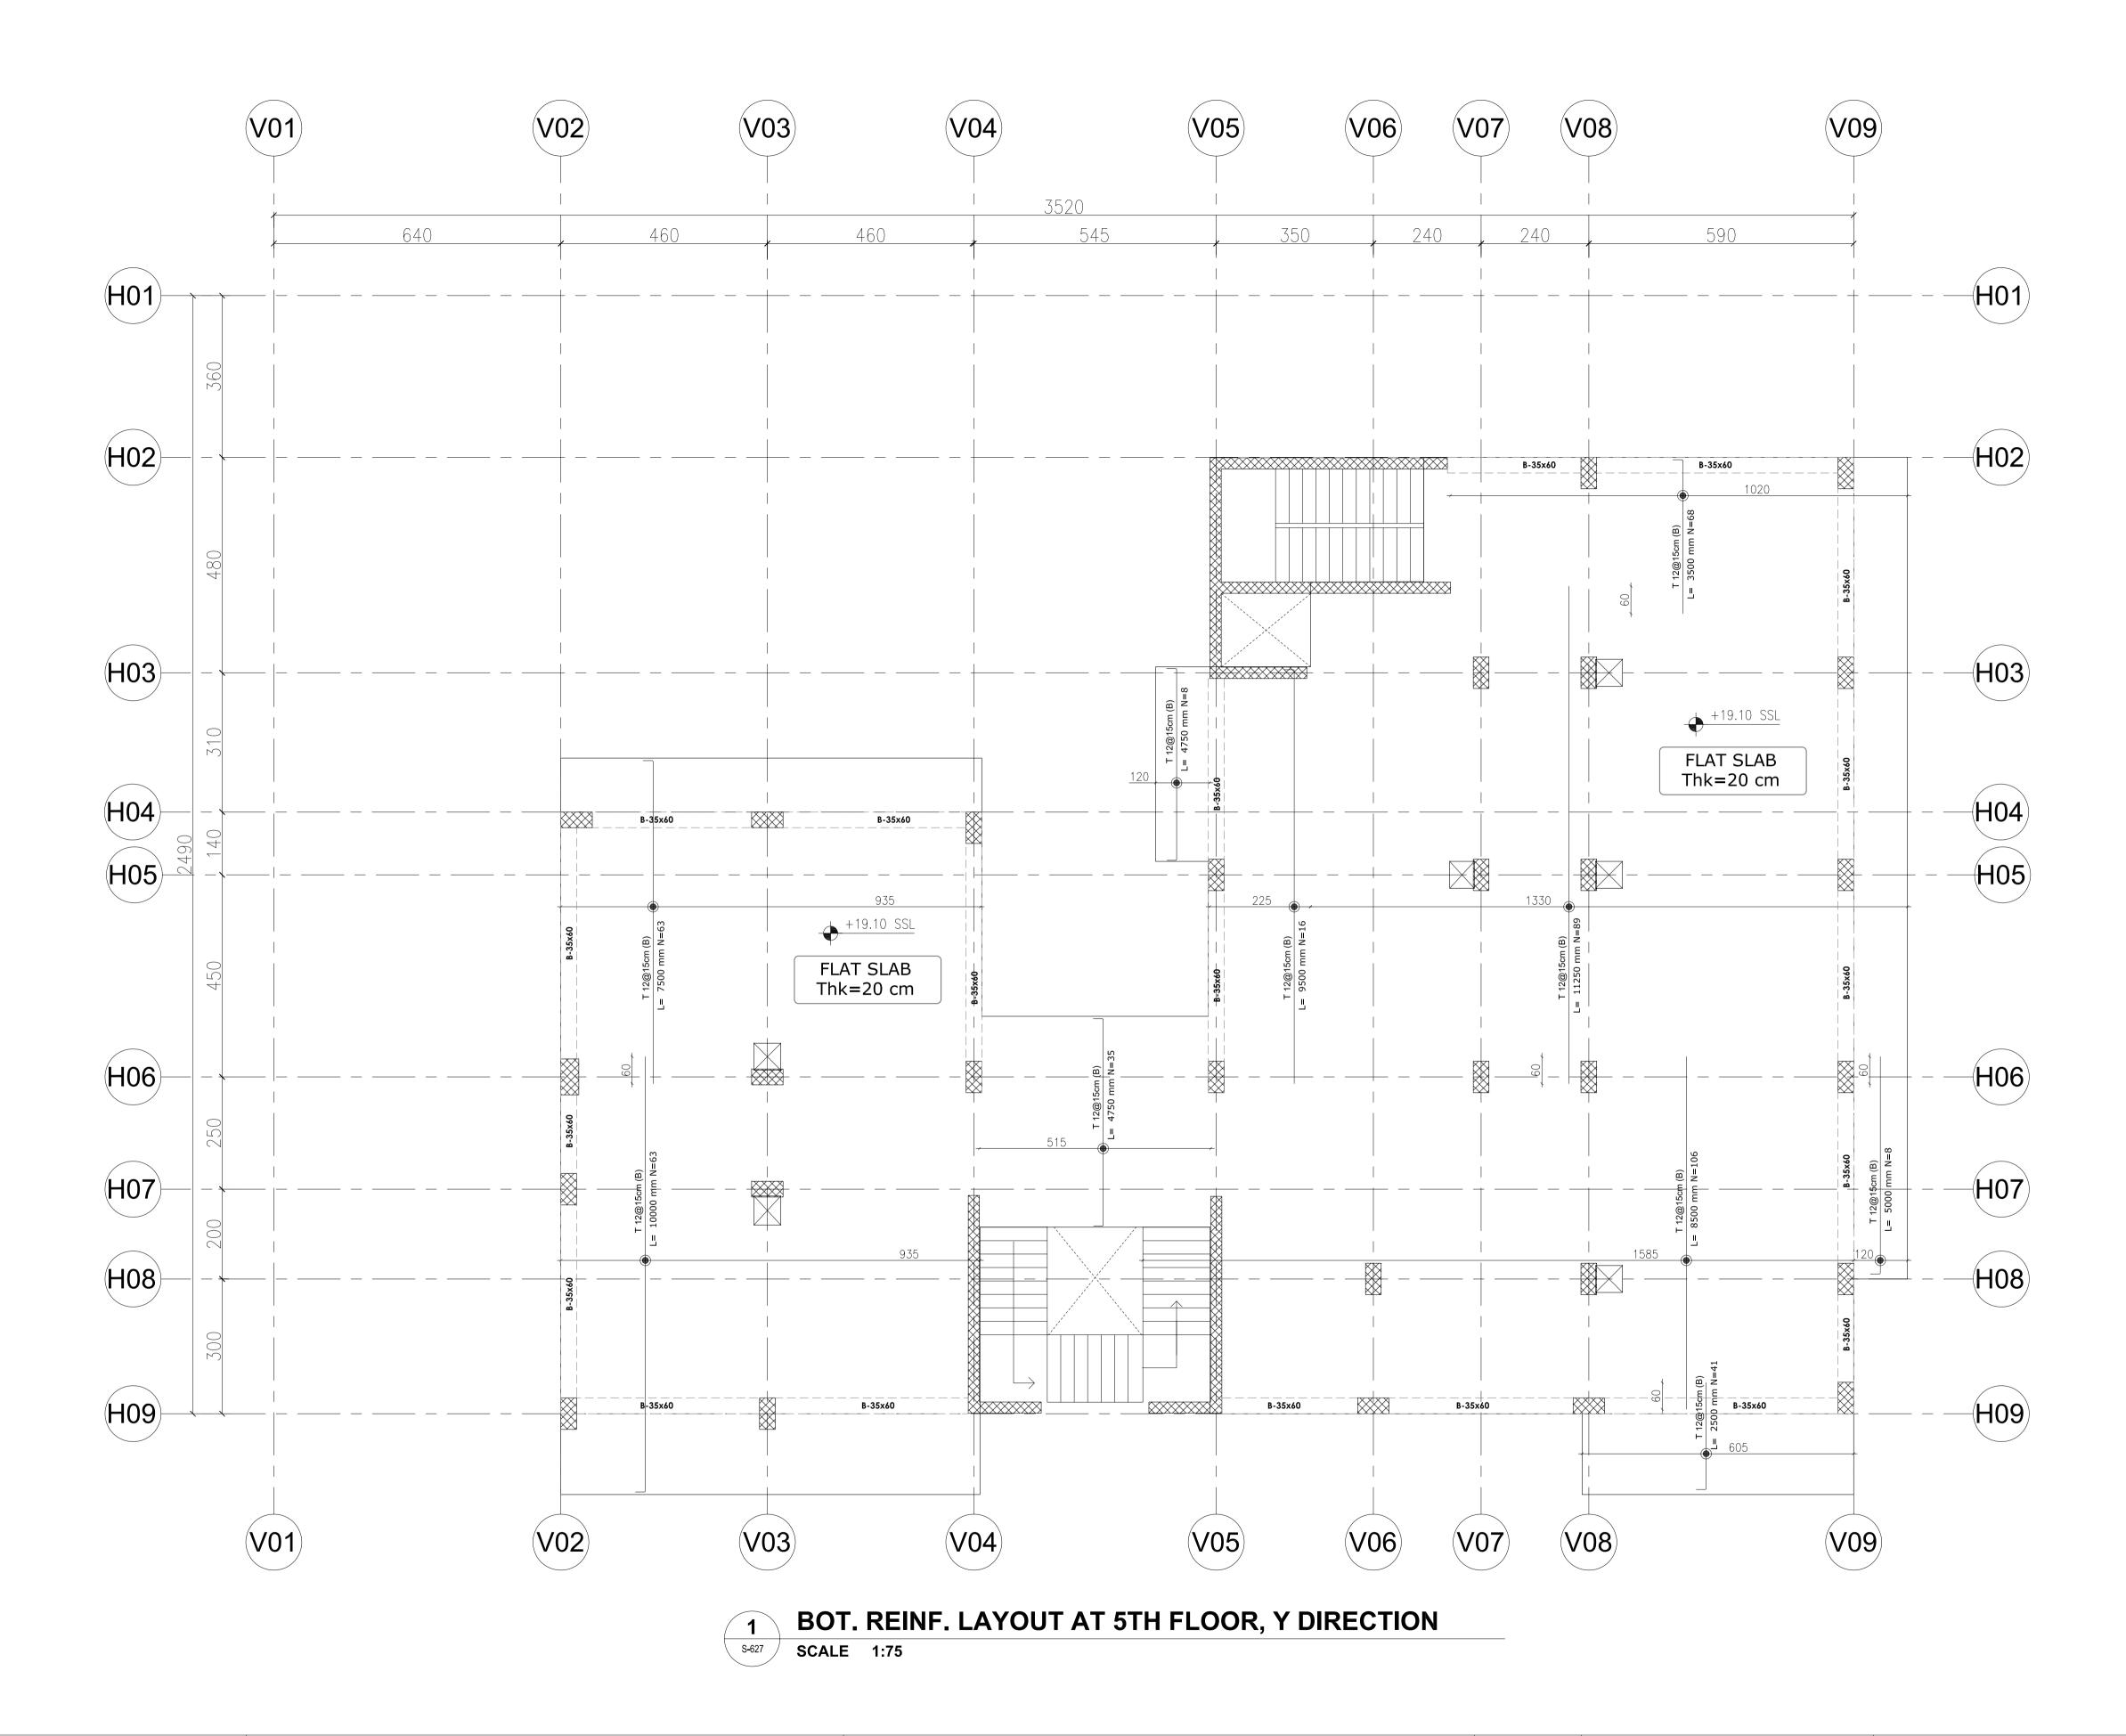

- all dimensions in (cm)
- all levels in meter (m)

YORKVILLE HOTEL & APARTMENTS LIMITED

PROJECT TITLE:

CLIENT: **DELOMIS**

DESIGNED

DRAWN

CHECKED

SCALE

DATE

17 JAN. 2022

DRAWING TITLE:


BOT. REINF. LAYOUT AT 5TH FLOOR, Y DIRECTION CONSULTANT OFFICE

Java Design Concepts

LTD



SIZE: A1 DRAWING no:

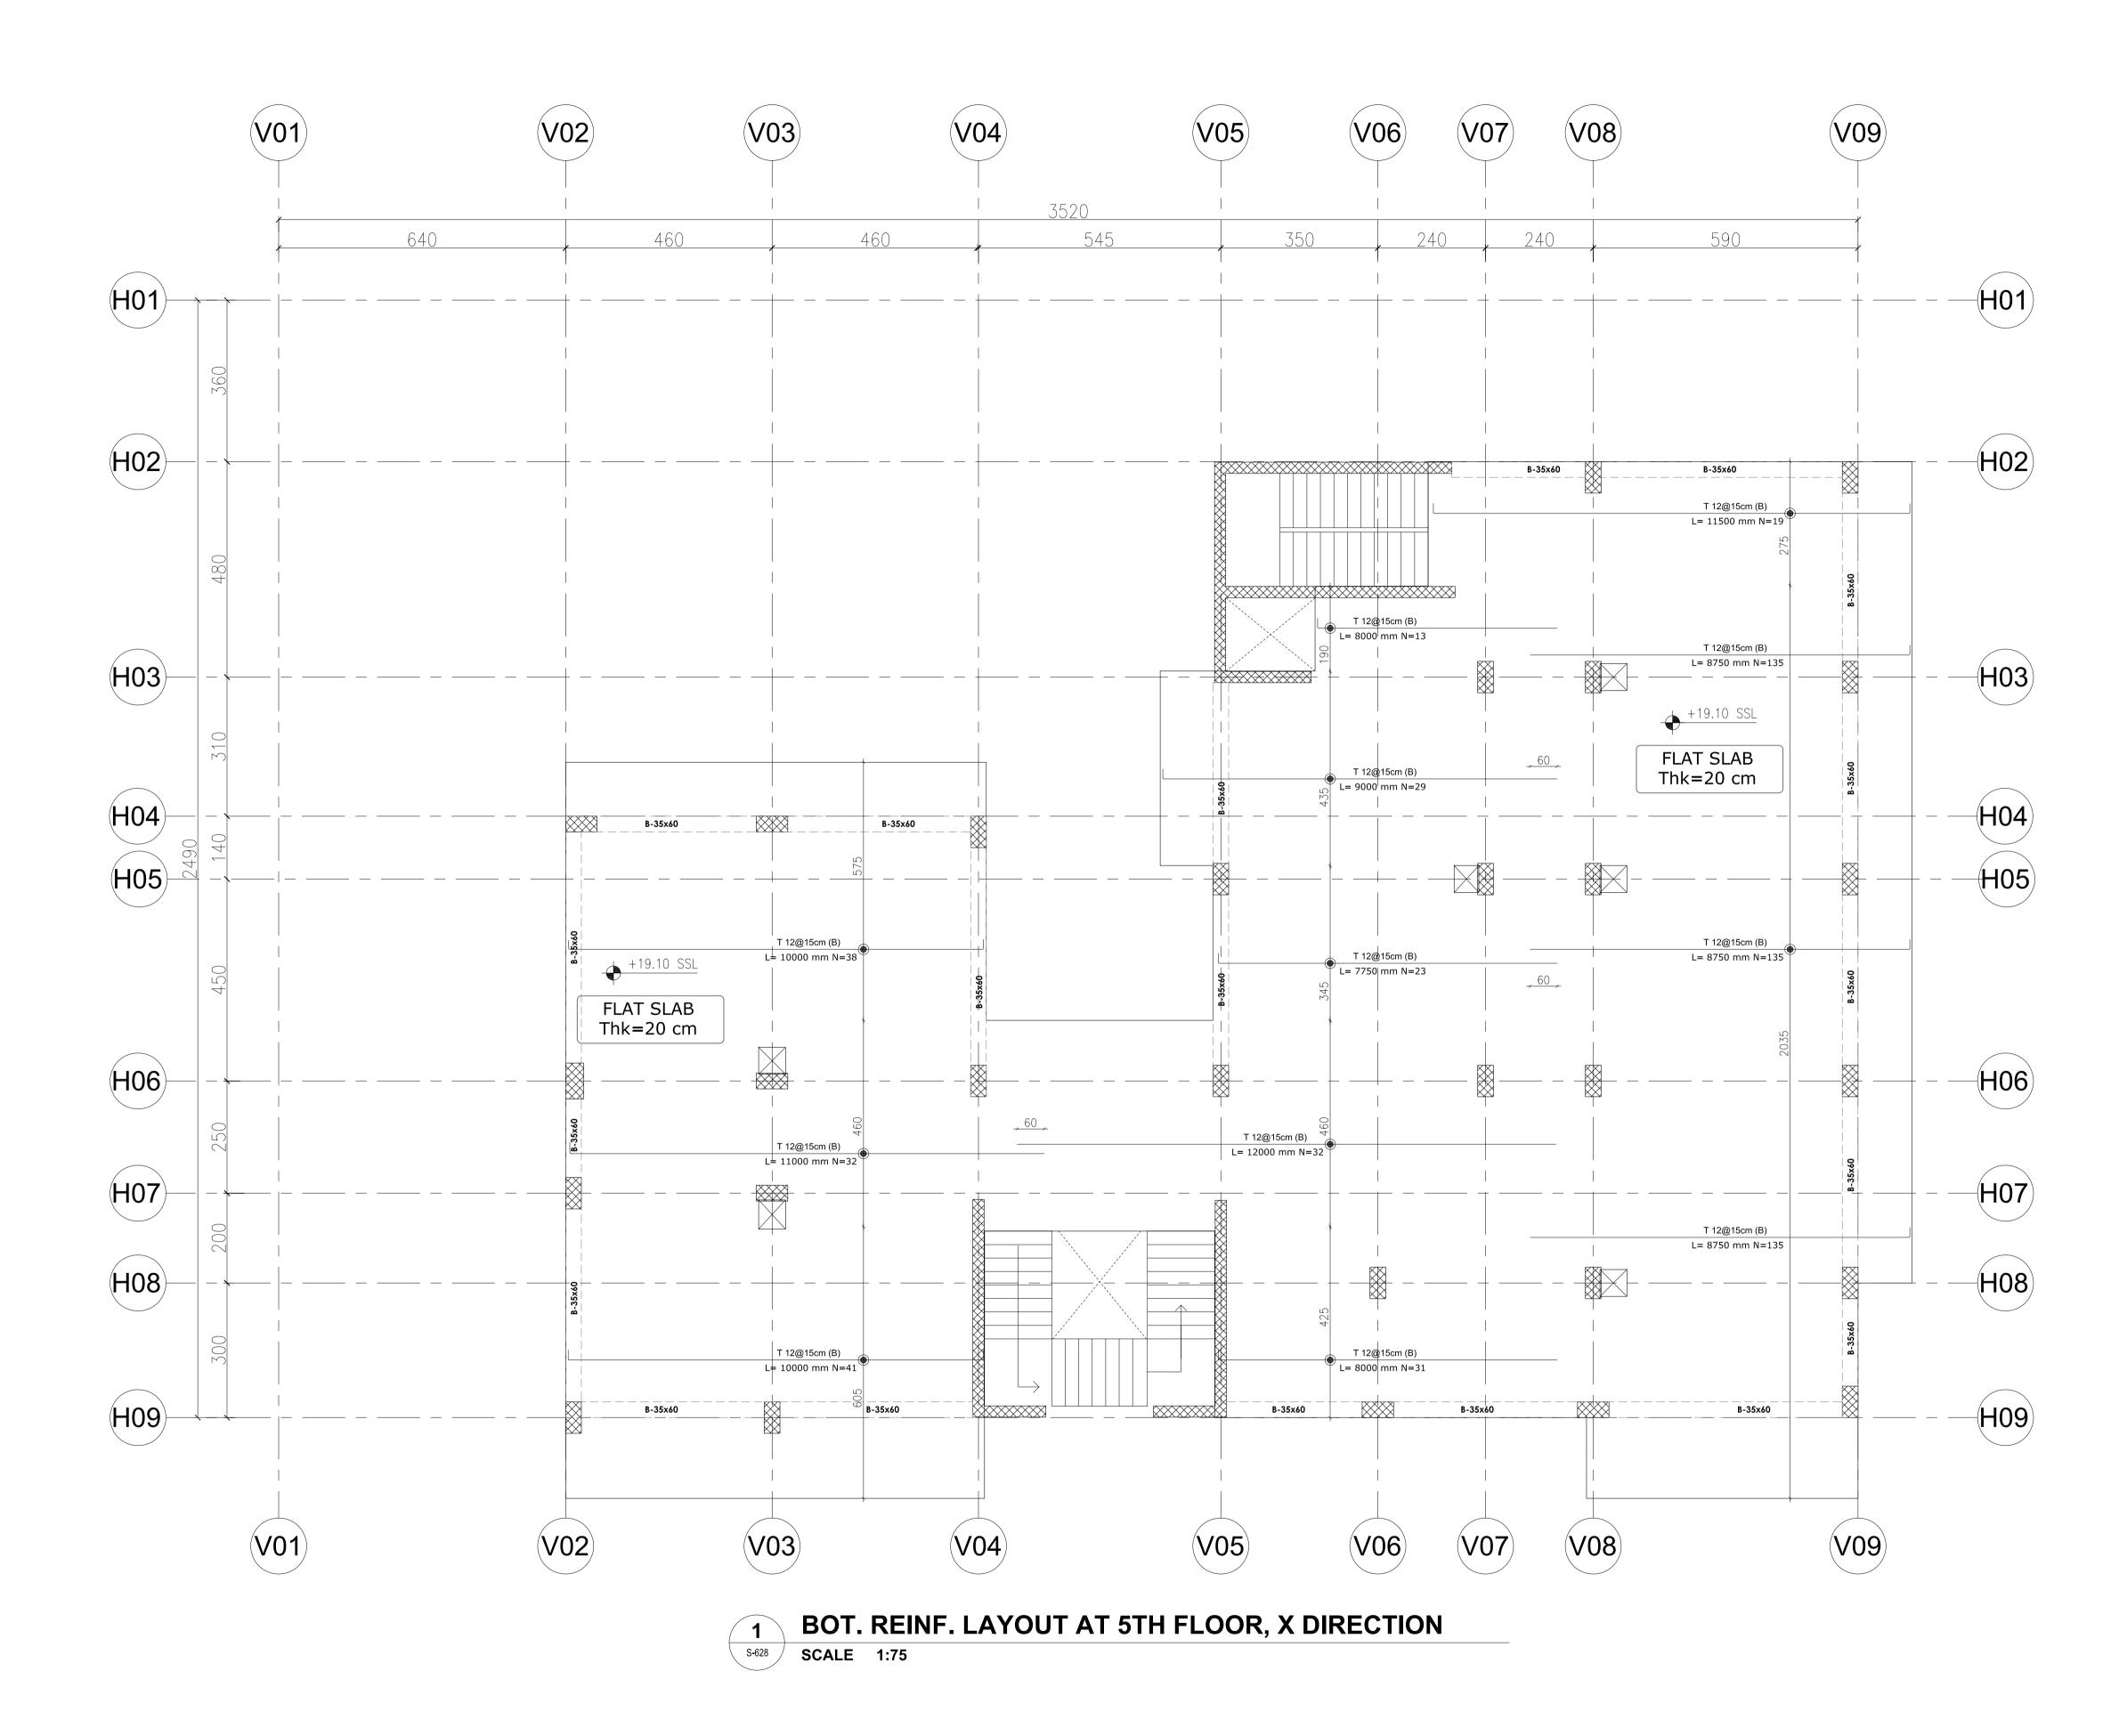

all dimensions in (cm)all levels in meter (m)

PROJECT TITLE:

YORKVILLE HOTEL & APARTMENTS LIMITED

CLIENT: **DELOMIS**

DESIGNED

DRAWN

CHECKED

SCALE

DATE

17 JAN. 2022

DRAWING TITLE:


BOT. REINF. LAYOUT AT 5TH FLOOR, X DIRECTION CONSULTANT OFFICE

Java Design Concepts

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SIZE: A1 DRAWING no:



ADDITIONAL BARS SCHEDULE: TAG DIMENSIONS DETAILS LENGHT

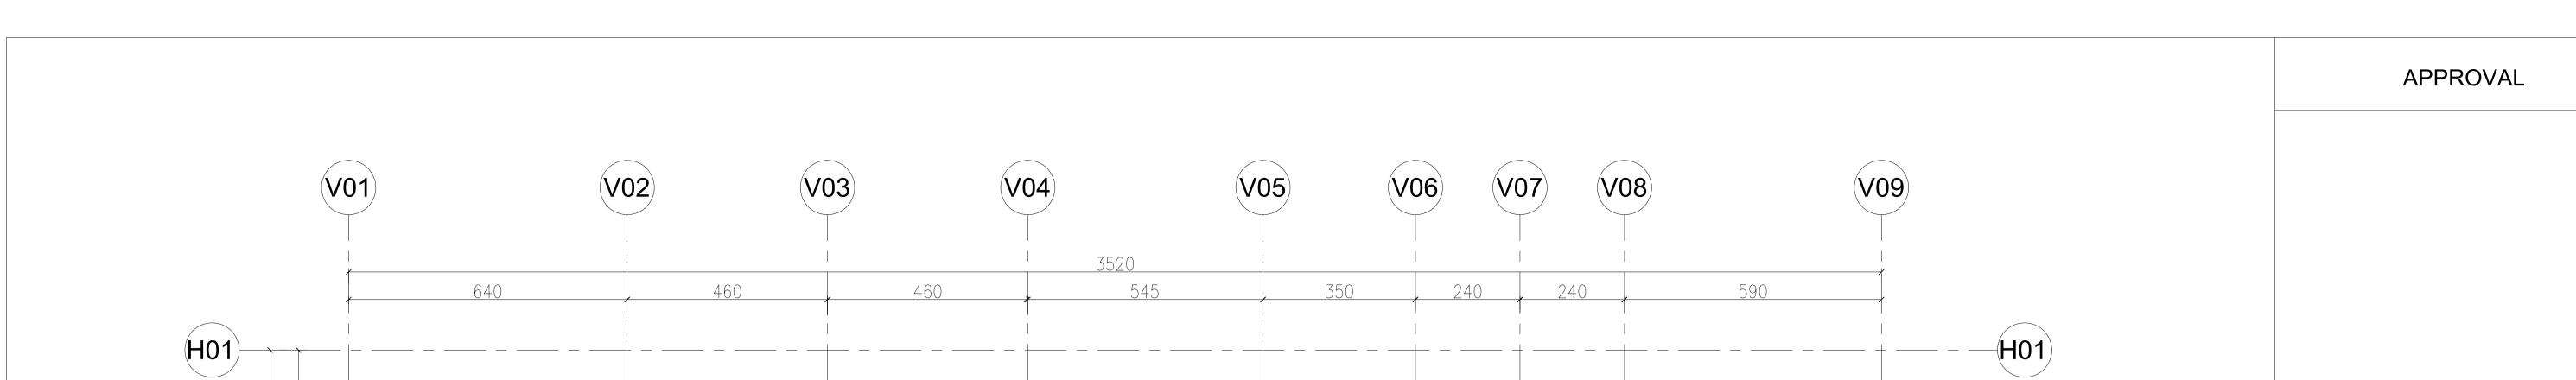IAG	DIVILIACIONO	DETAILS	LENGIII
T1	TOP REINF.	T12 @ 15cm	400cm
T2	TOP REINF.	T12 @ 15cm	200cm
T3	TOP REINF.	T12 @ 15cm	440cm
T4	TOP REINF.	T12 @ 15cm	500cm

H03 H03 +19.10 SSL +19.10 SSL FLAT SLAB FLAT SLAB Thk=20 cm Thk=20 cm T2 H06 H06 H07 H07 H08 H08 H09 H09 B-35x60 **V02** V01) (V03) V09 (V04) (V08) (V05) **(V07)**

ADD. REINFORCEMENT LAYOUT AT 5TH FLOOR

SCALE 1:75

Note:

- all dimensions in (cm)

- all levels in meter (m)

PROJECT TITLE:

YORKVILLE HOTEL & **APARTMENTS LIMITED** CLIENT:

DELOMIS

DESIGNED DRAWN CHECKED SCALE 17 JAN. 2022

DRAWING TITLE:

ADD. REINFORCEMENT LAYOUT AT 5TH FLOOR

CONSULTANT OFFICE

Java Design Concepts LTD

SIZE: A1 DRAWING no:



- all dimensions in (cm)
- all levels in meter (m)

YORKVILLE HOTEL & APARTMENTS LIMITED

PROJECT TITLE:

CLIENT: **DELOMIS**

DESIGNED

DRAWN

CHECKED

SCALE

DATE

17 JAN. 2022

DRAWING TITLE:

TOP. REINF. LAYOUT AT ROOF, Y DIRECTION


CONSULTANT OFFICE

Java Design Concepts

LTD



SIZE: A1 DRAWING no:

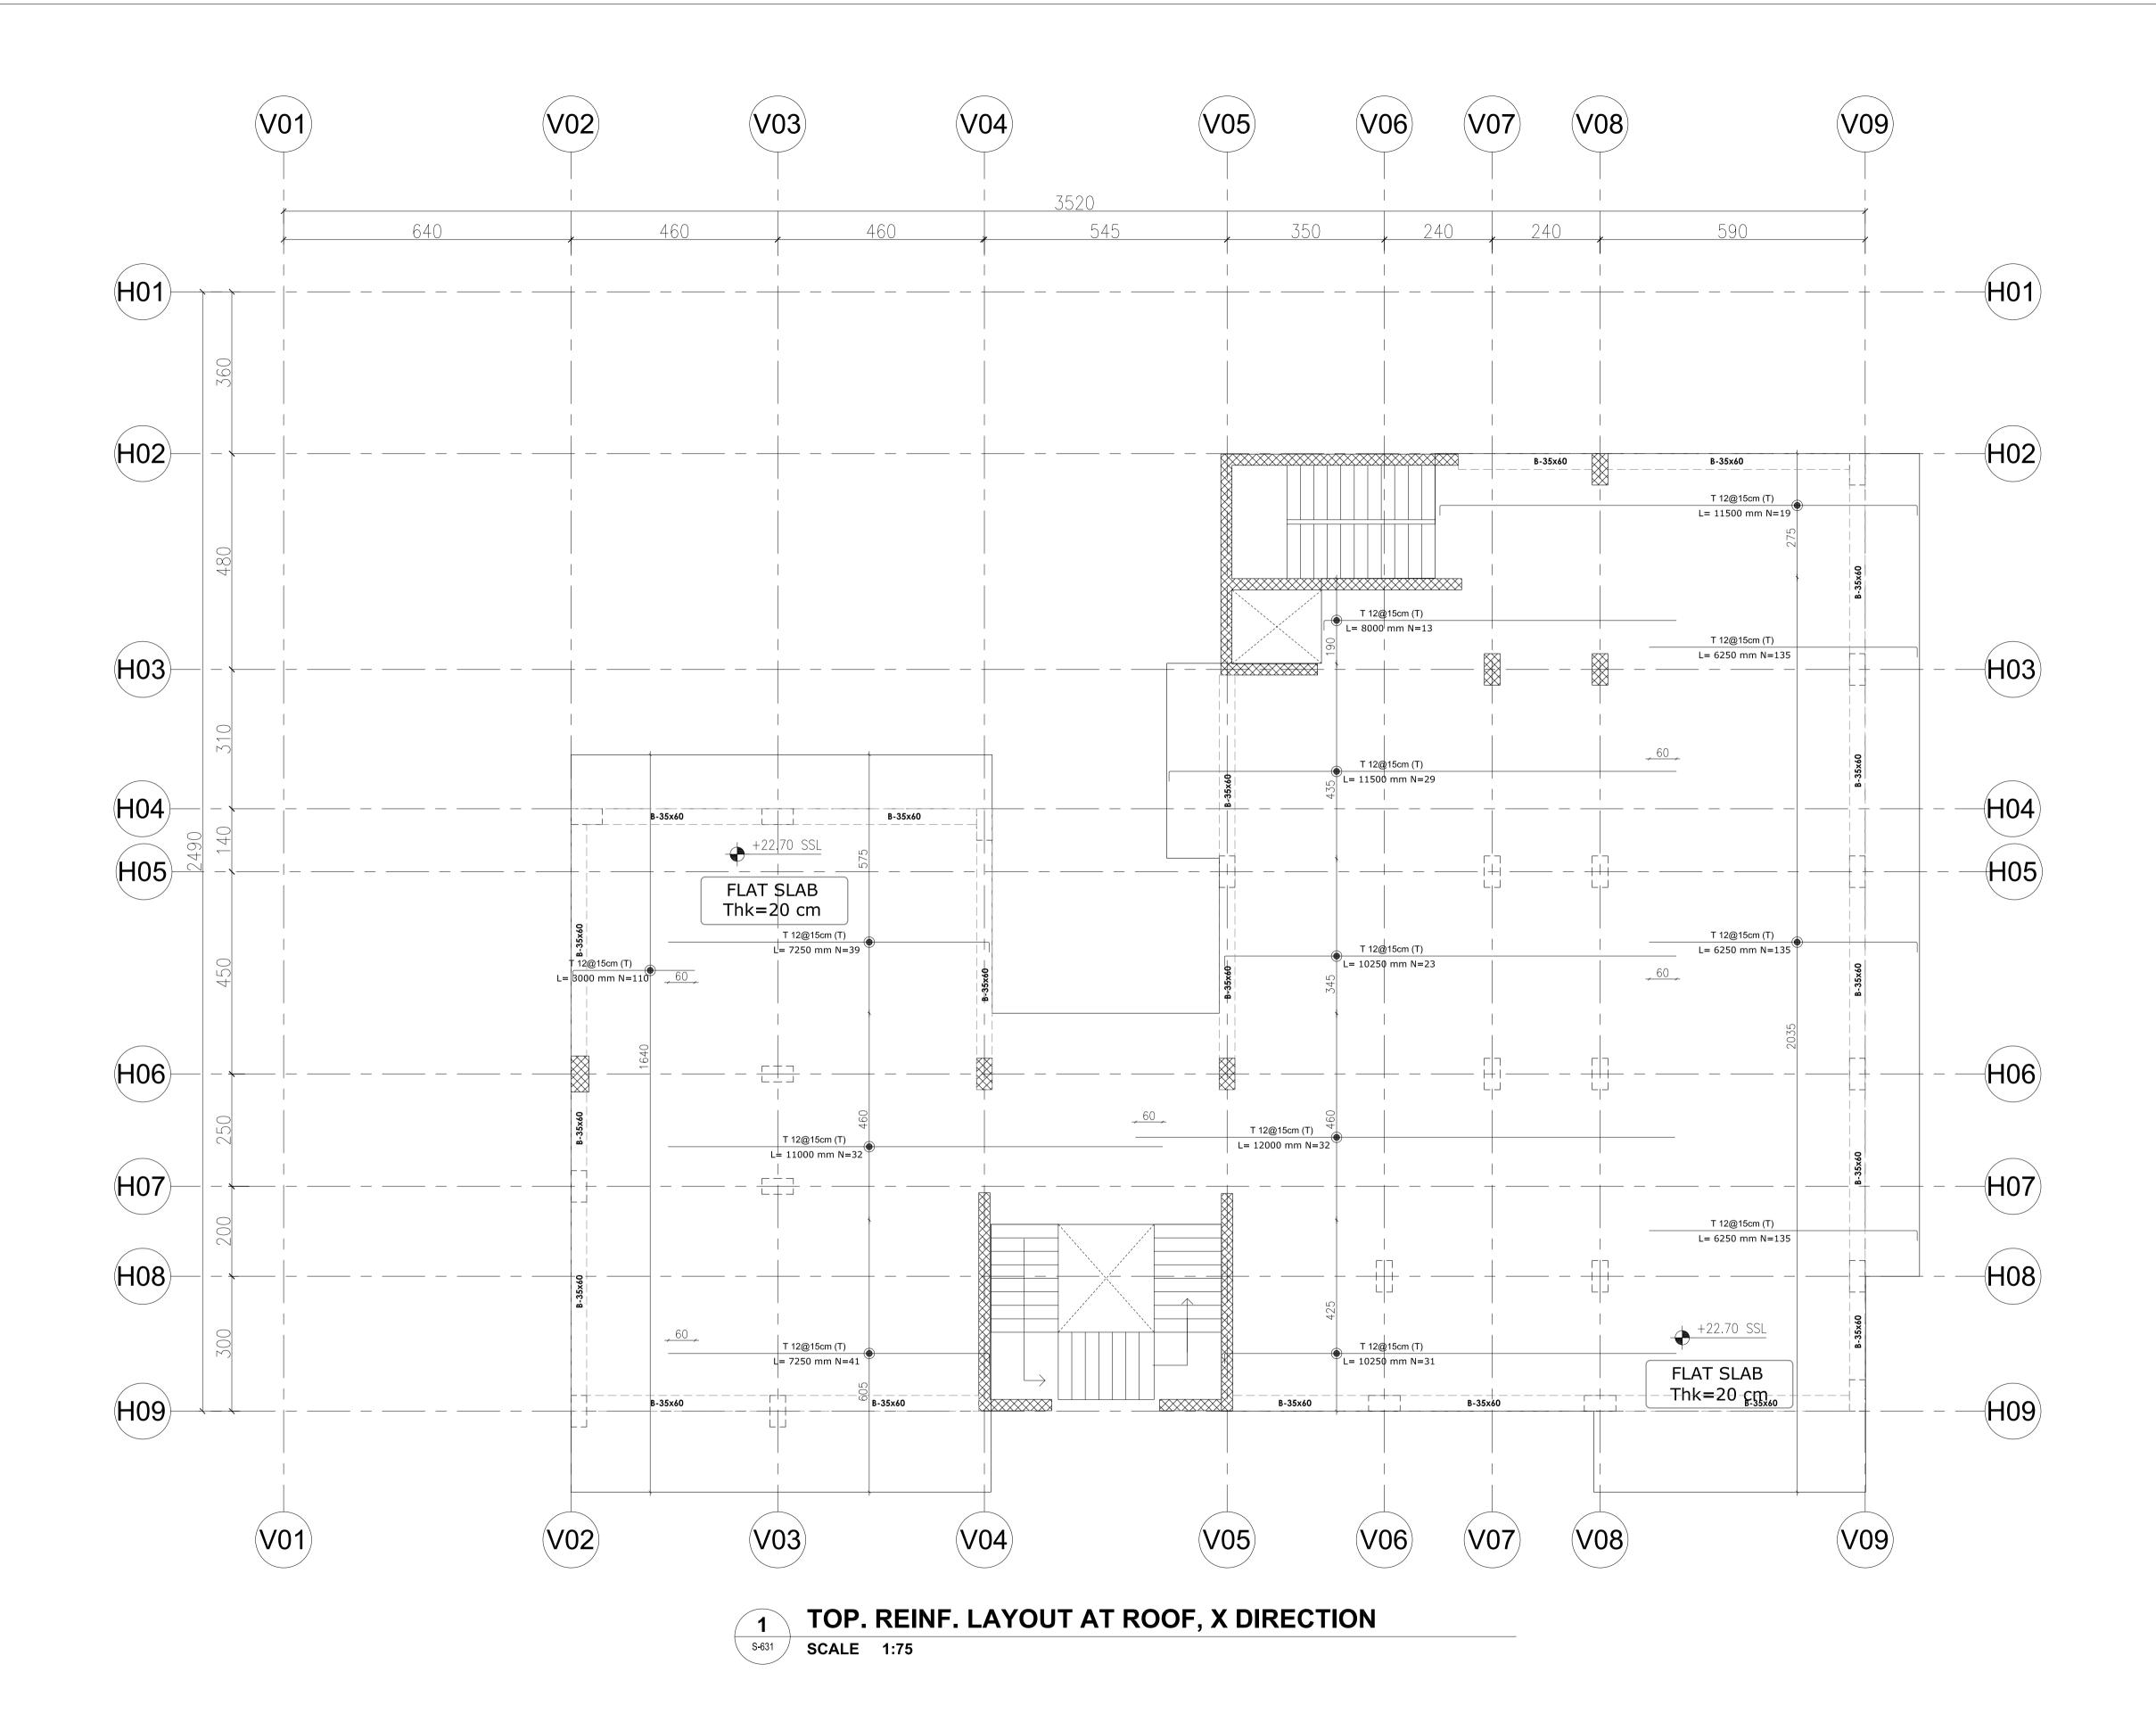

PROJECT TITLE:

Note:

- all dimensions in (cm)


- all levels in meter (m)

YORKVILLE HOTEL & **APARTMENTS LIMITED**

CLIENT: **DELOMIS** DESIGNED DRAWN CHECKED ROOF, X DIRECTION SCALE 17 JAN. 2022 DATE

DRAWING TITLE: TOP. REINF. LAYOUT AT CONSULTANT OFFICE Java Design Concepts LTD

SIZE: A1 DRAWING no:

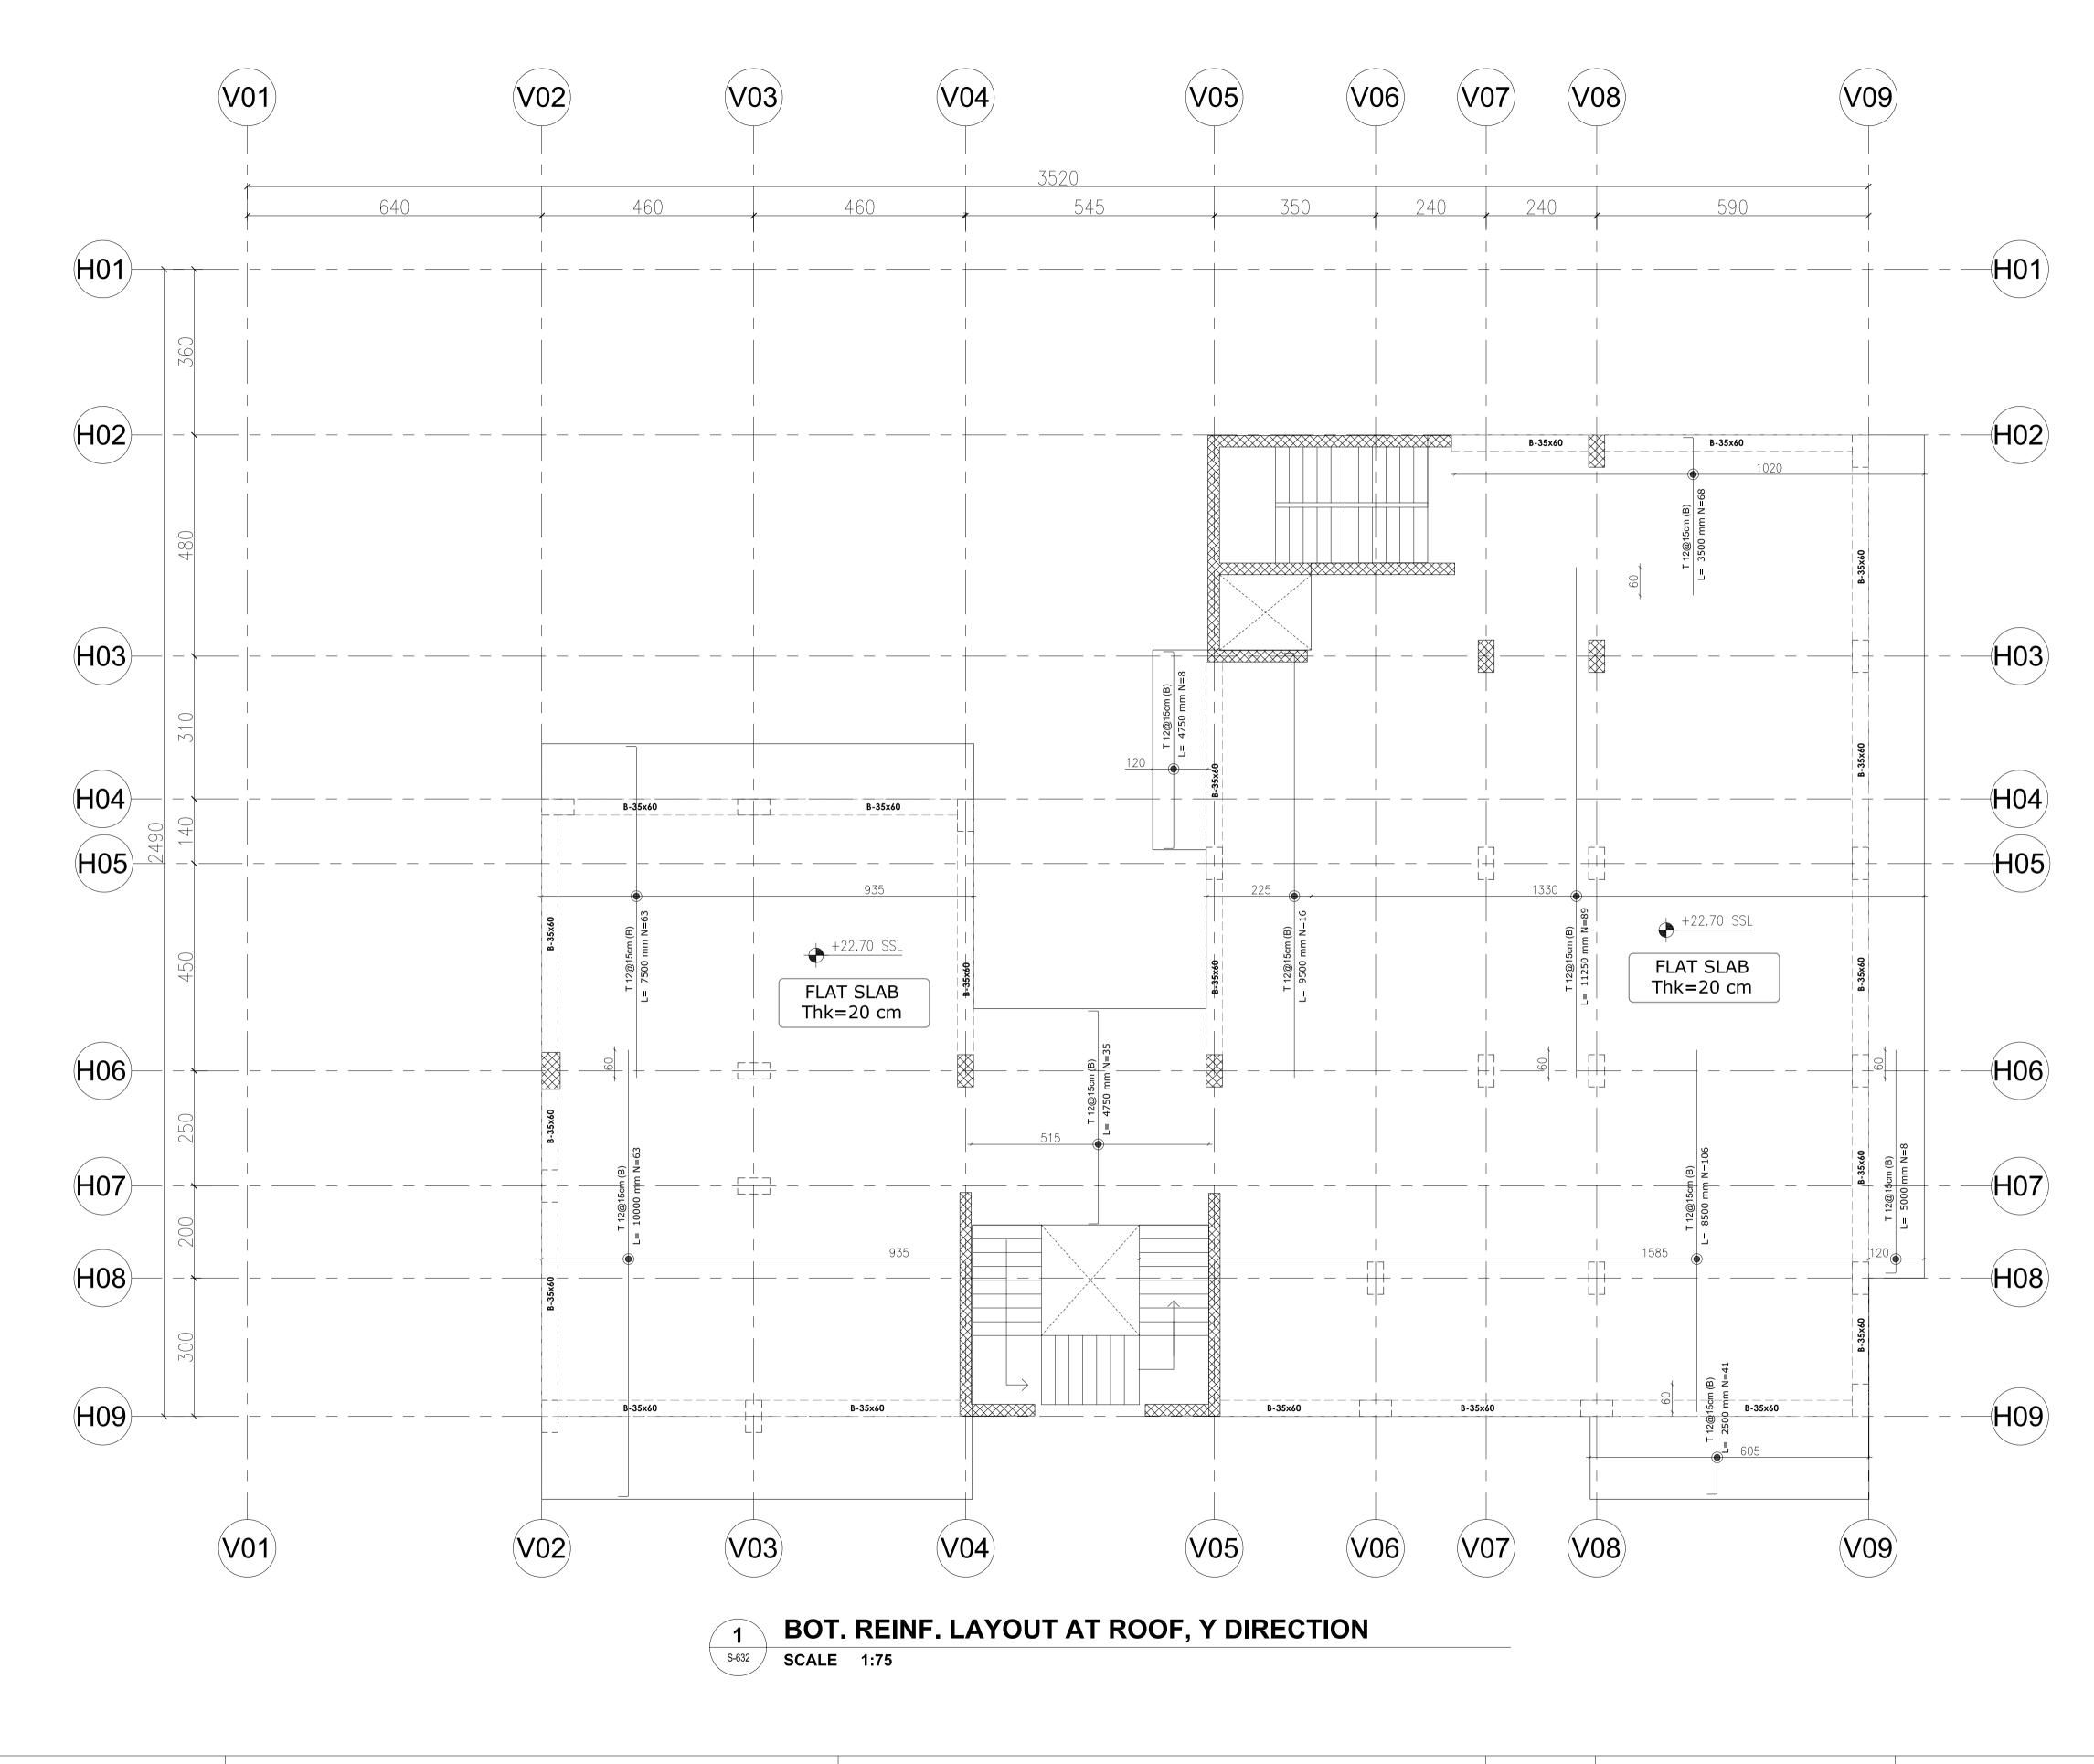

- all dimensions in (cm) - all levels in meter (m)

PROJECT TITLE:

YORKVILLE HOTEL & **APARTMENTS LIMITED** CLIENT:

DELOMIS

DESIGNED DRAWN CHECKED SCALE 17 JAN. 2022

DRAWING TITLE:


BOT. REINF. LAYOUT AT ROOF, Y DIRECTION

CONSULTANT OFFICE Java Design Concepts LTD



SIZE: A1 DRAWING no:



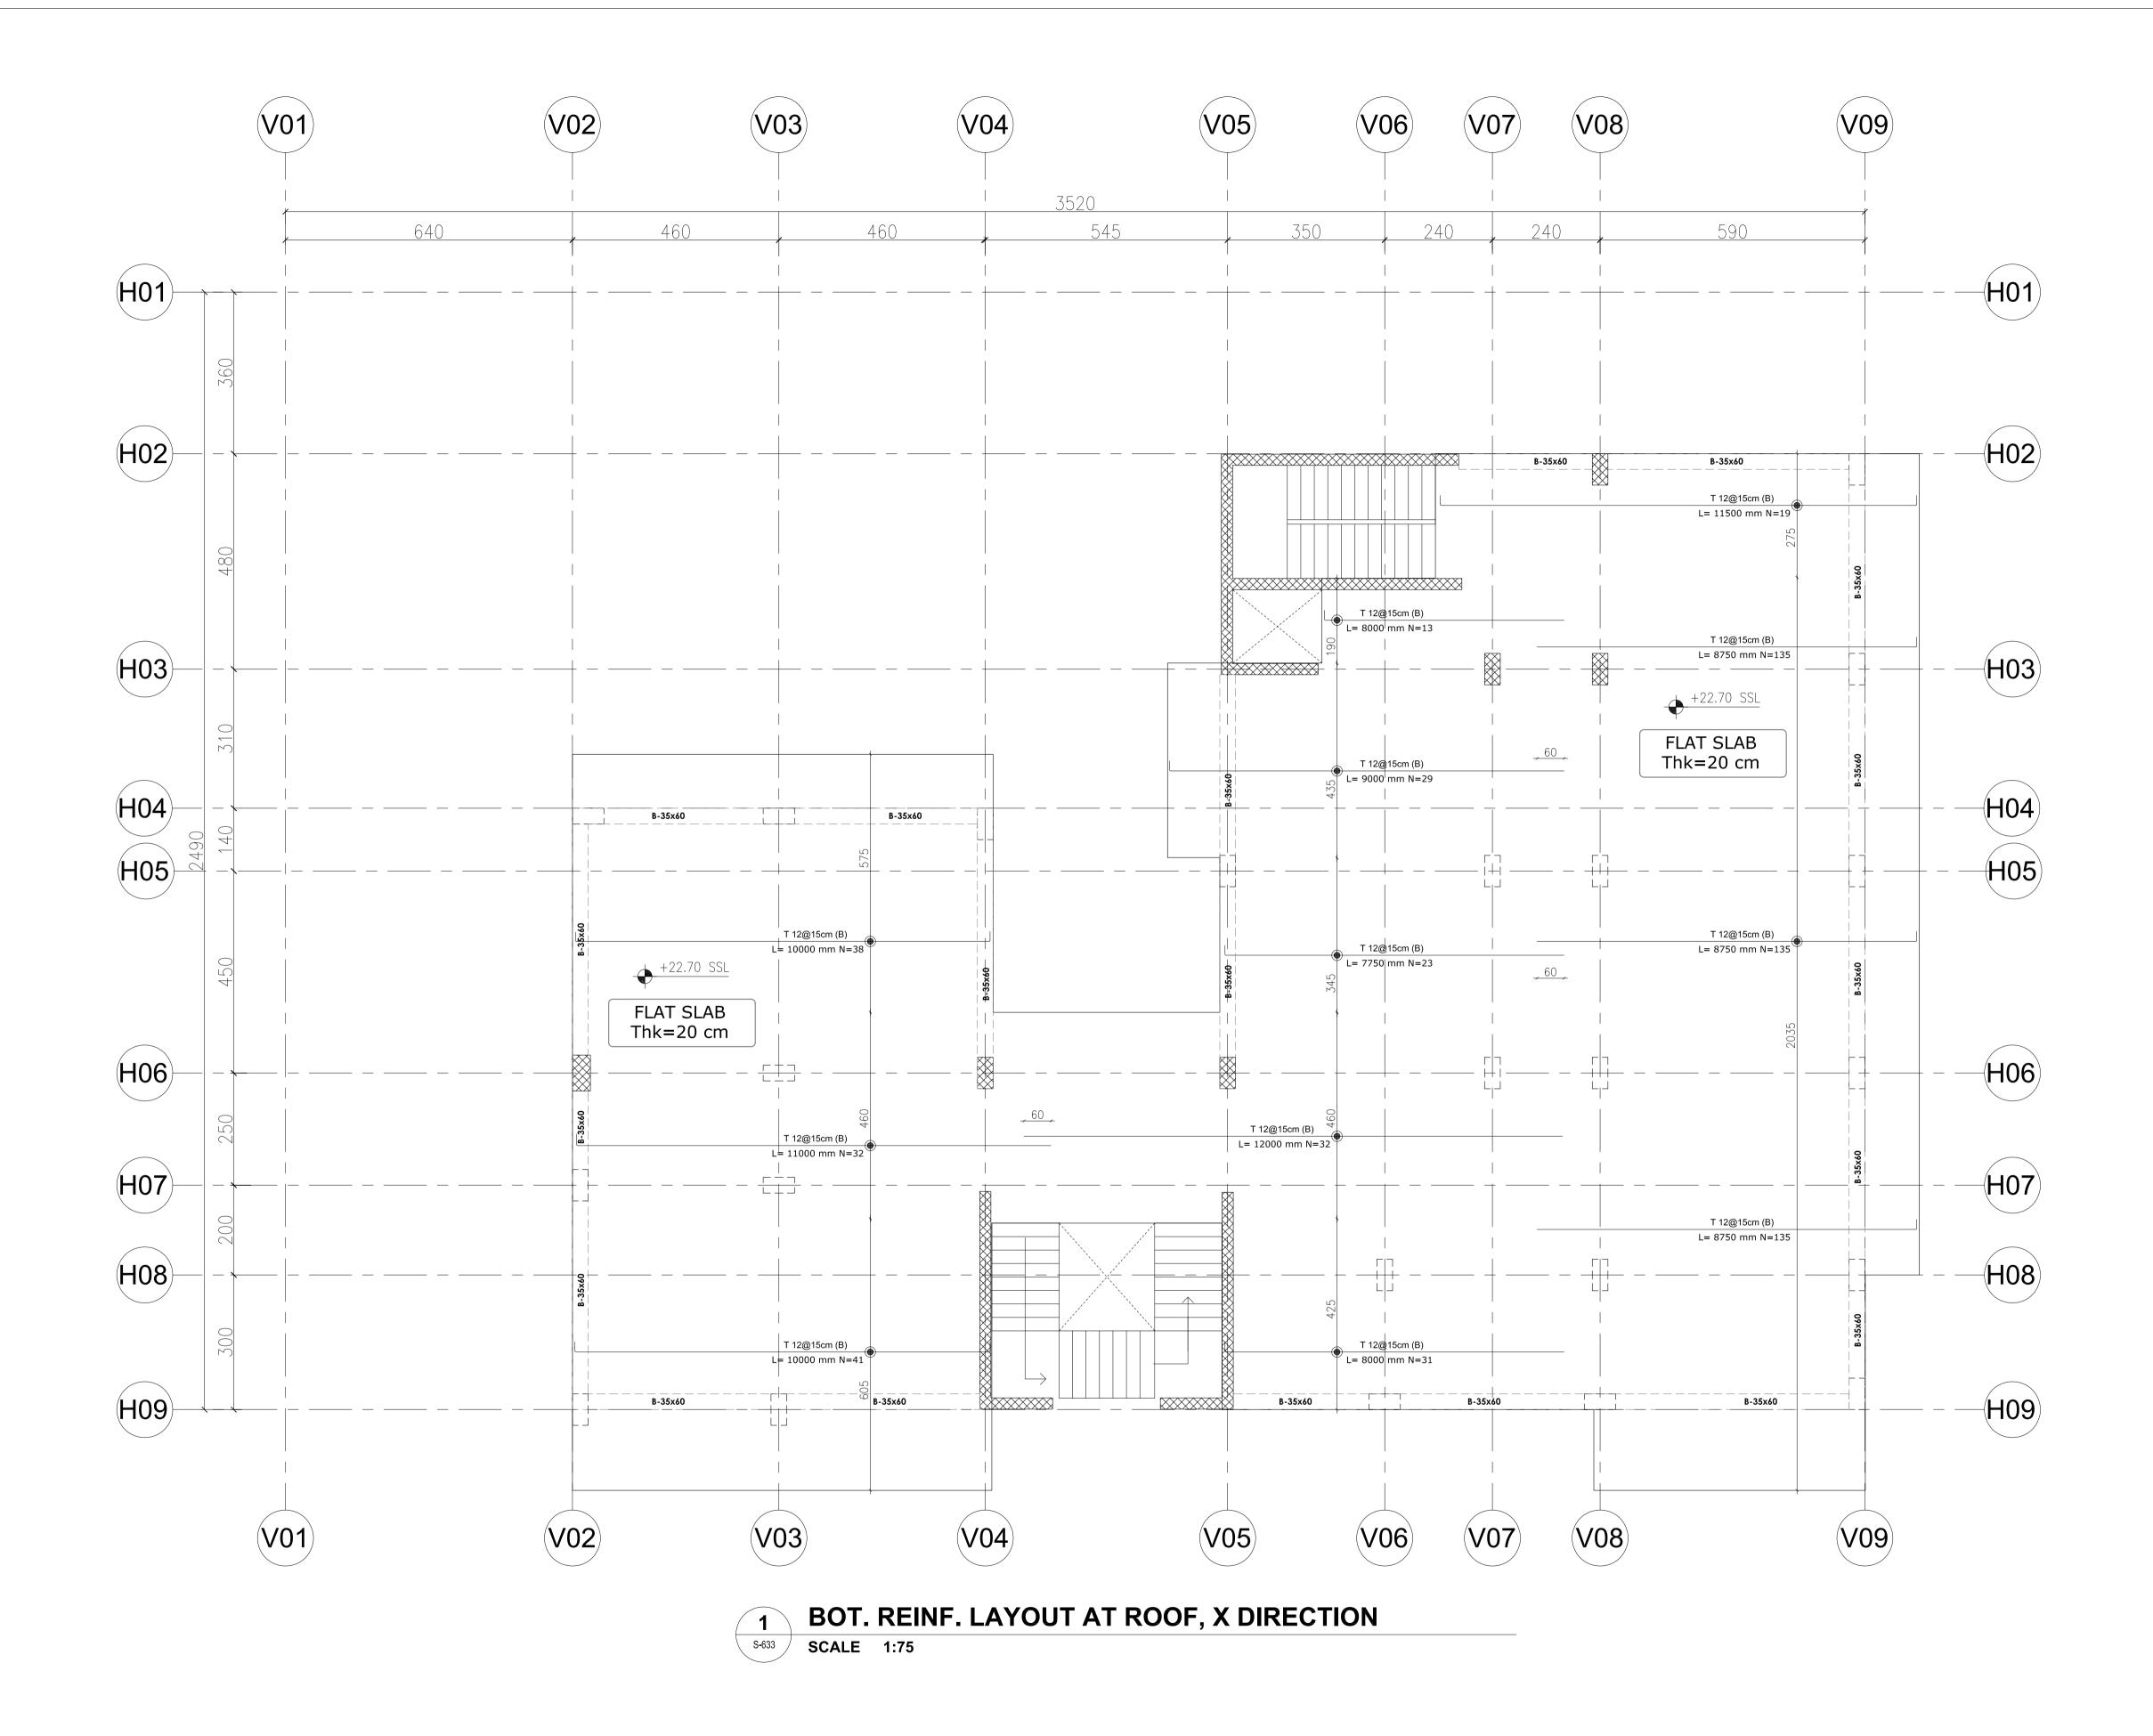

- all dimensions in (cm)

- all levels in meter (m)

PROJECT TITLE:

YORKVILLE HOTEL & **APARTMENTS LIMITED**

CLIENT: **DELOMIS** DESIGNED DRAWN CHECKED SCALE 17 JAN. 2022 DATE

DRAWING TITLE:


BOT. REINF. LAYOUT AT ROOF, X DIRECTION

CONSULTANT OFFICE Java Design Concepts LTD



SIZE: A1 DRAWING no:



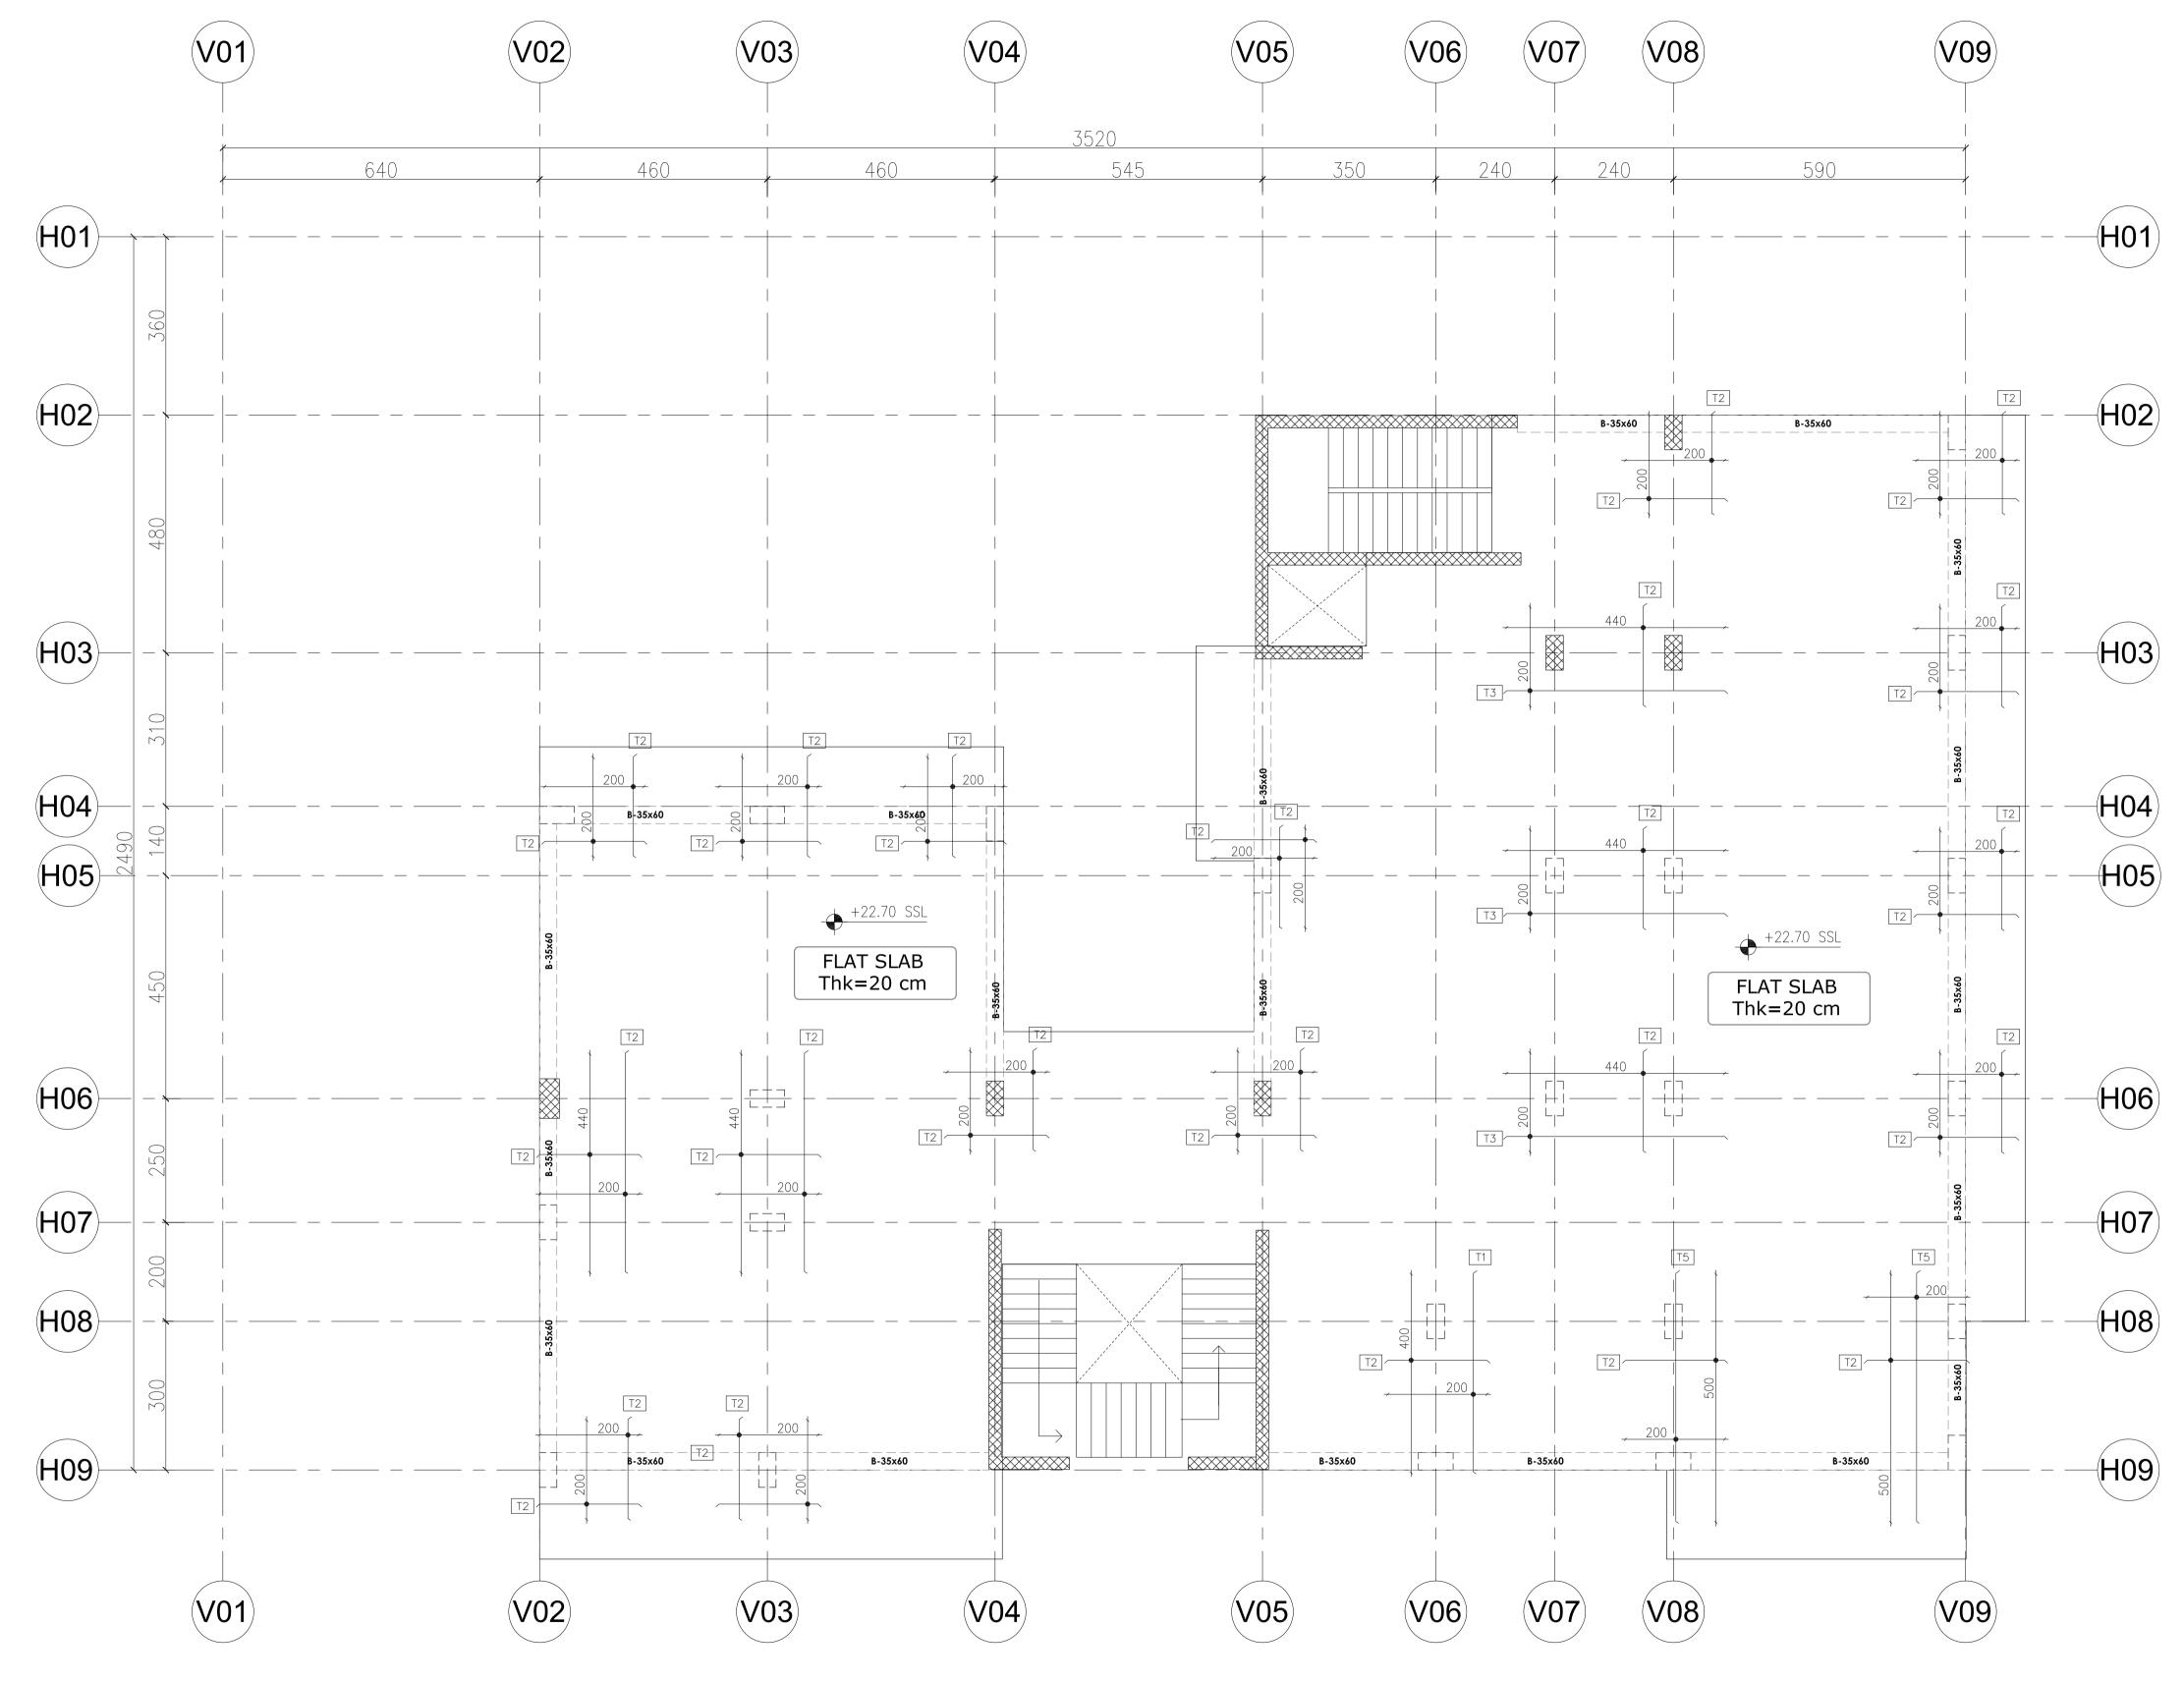

ADDITIONAL BARS SCHEDULE:

TAG	DIMENSIONS	DETAILS	LENGHT
T1	TOP REINF.	T12 @ 15cm	400cm
T2	TOP REINF.	T12 @ 15cm	200cm
T3	TOP REINF.	T12 @ 15cm	440cm
T4	TOP REINF.	T12 @ 15cm	500cm

ADD. REINFORCEMENT LAYOUT AT ROOF **1** S-634

SCALE 1:75

Note:

- all dimensions in (cm) - all levels in meter (m)

PROJECT TITLE:

YORKVILLE HOTEL & **APARTMENTS LIMITED** CLIENT:

DELOMIS


DESIGNED		DRAWING TITLE:
DRAWN		DIVAVVING TITLE.
CHECKED		ADD. REINFORCEM
SCALE		LAYOUT AT ROOF
DATE	17 JAN. 2022	

CONSULTANT OFFICE DRAWING TITLE: ADD. REINFORCEMENT

Java Design Concepts LTD



SIZE: A1 DRAWING no:

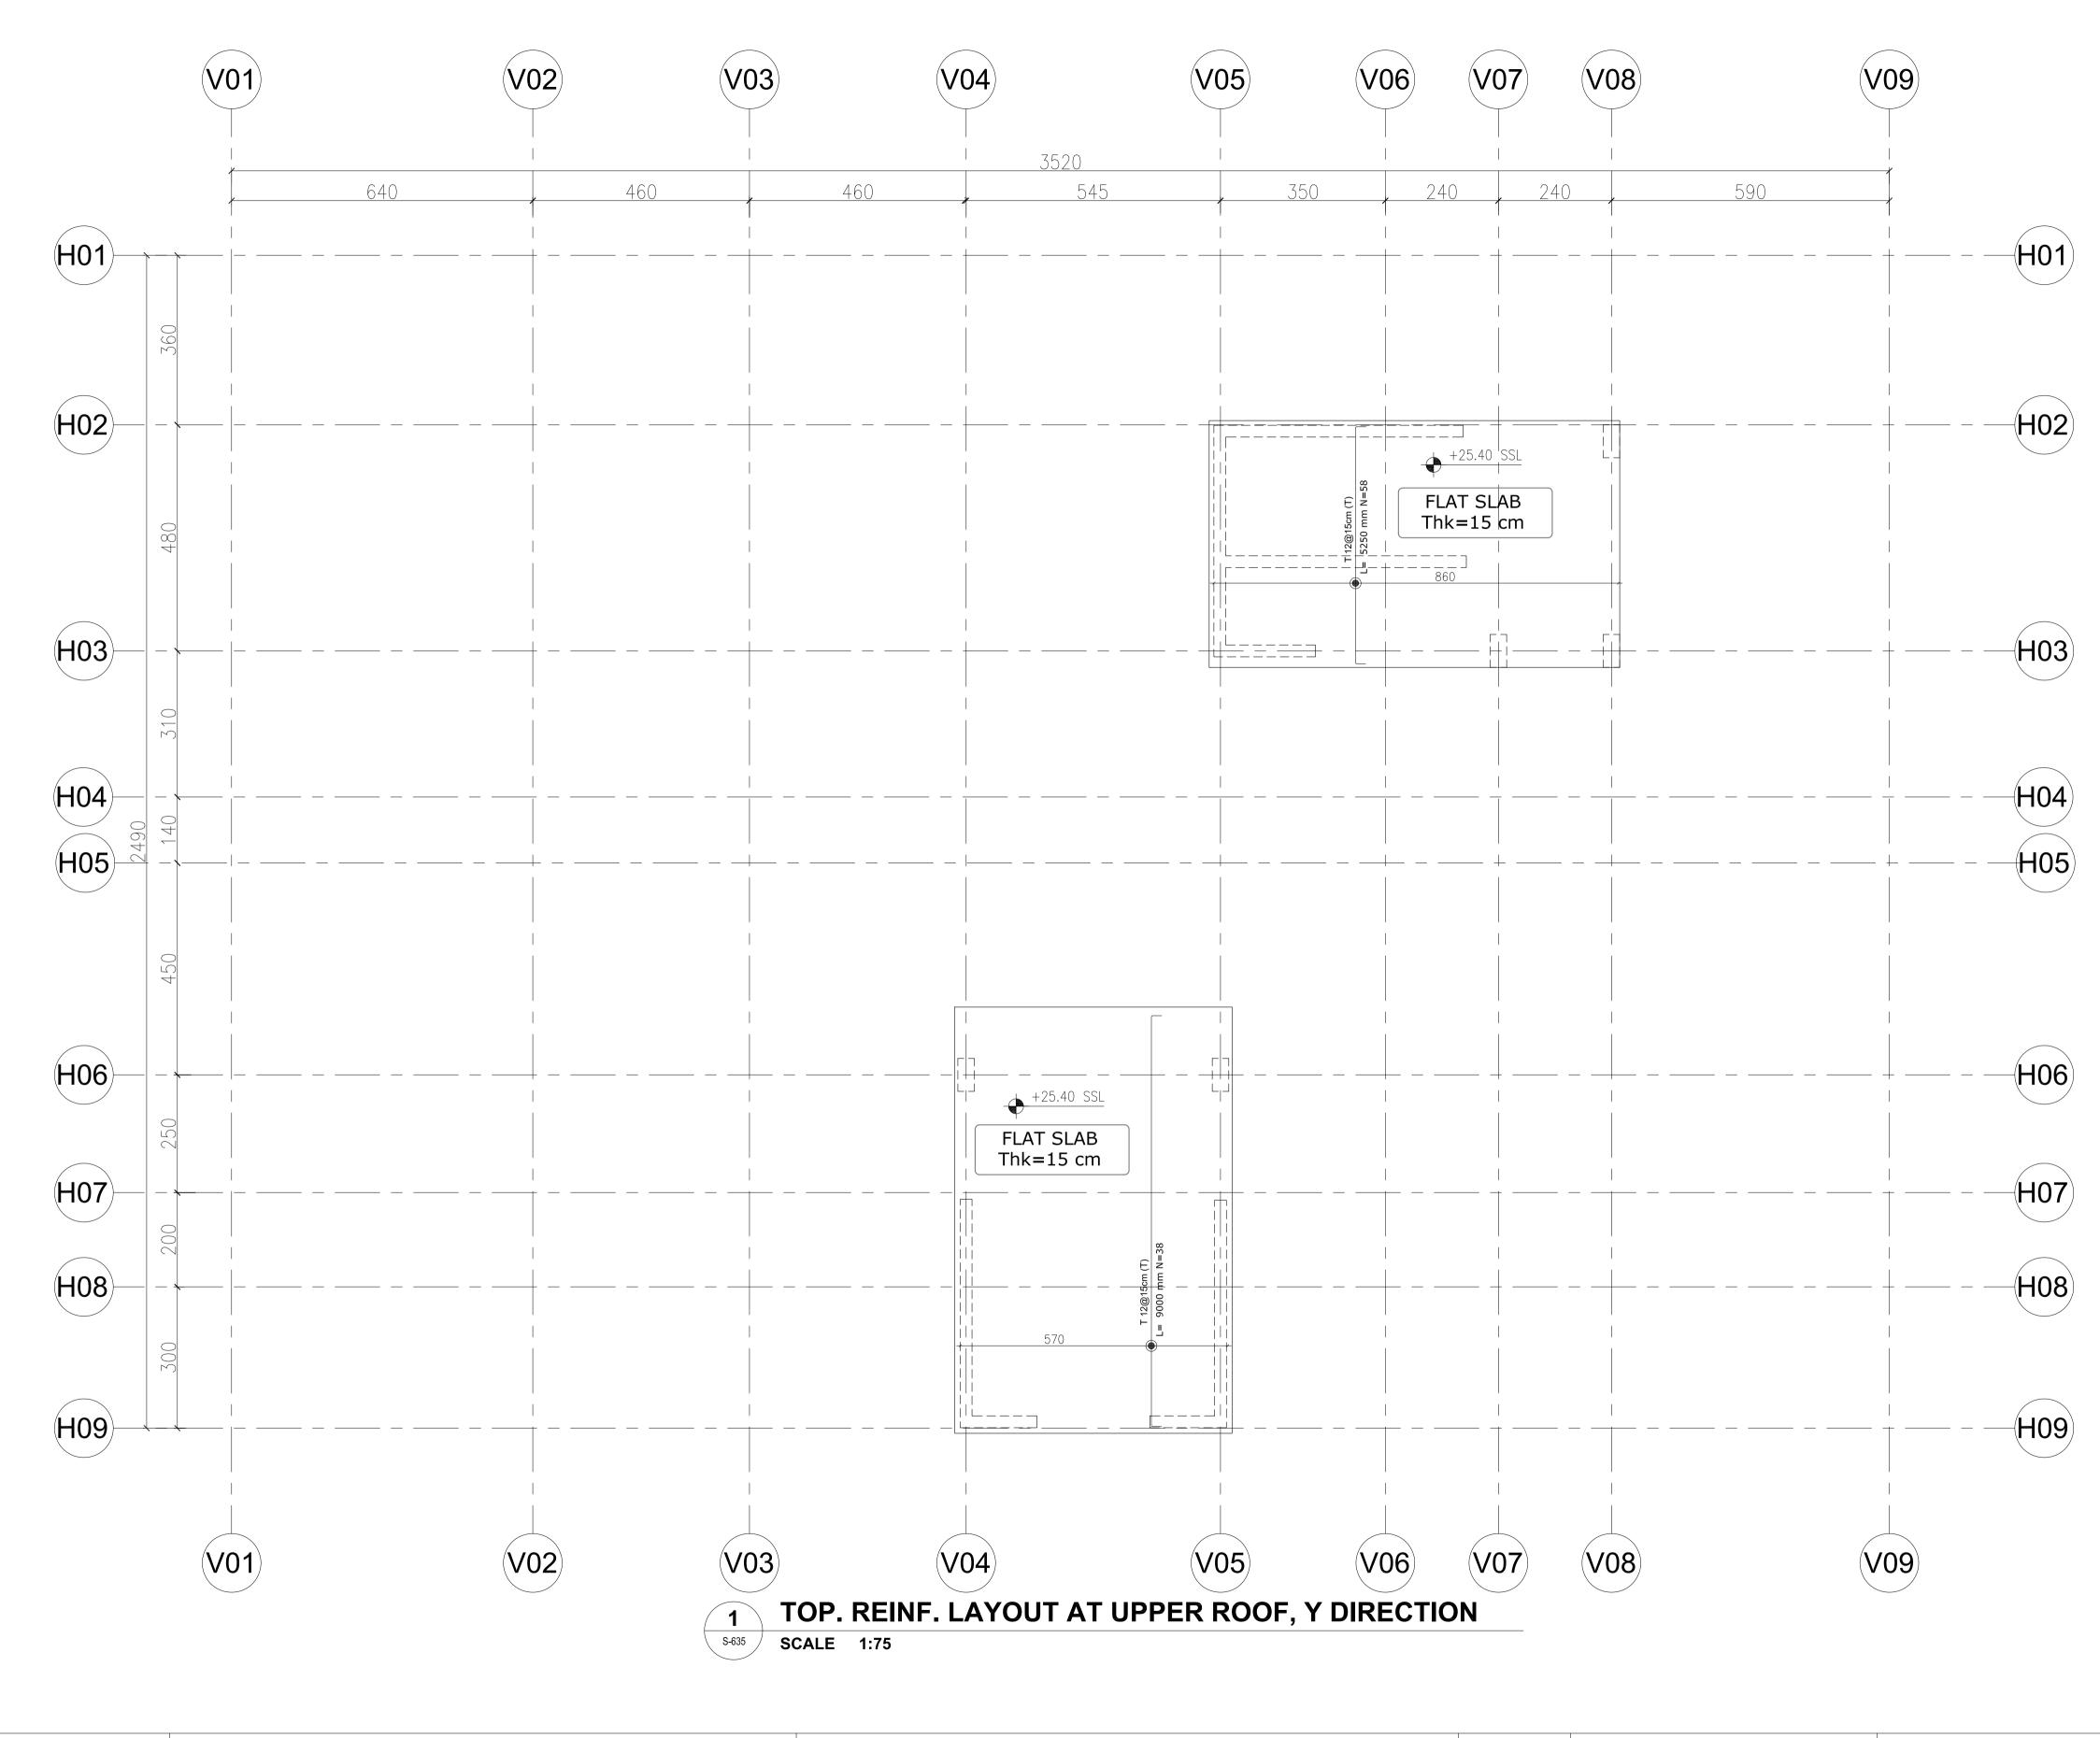

- all dimensions in (cm)

- all levels in meter (m)

PROJECT TITLE:

YORKVILLE HOTEL & **APARTMENTS LIMITED**

CLIENT: **DELOMIS** DESIGNED DRAWN CHECKED SCALE 17 JAN. 2022


DRAWING TITLE:

TOP. REINF. LAYOUT AT UPPER ROOF, Y DIRECTION

CONSULTANT OFFICE Java Design Concepts LTD



SIZE: A1 DRAWING no:

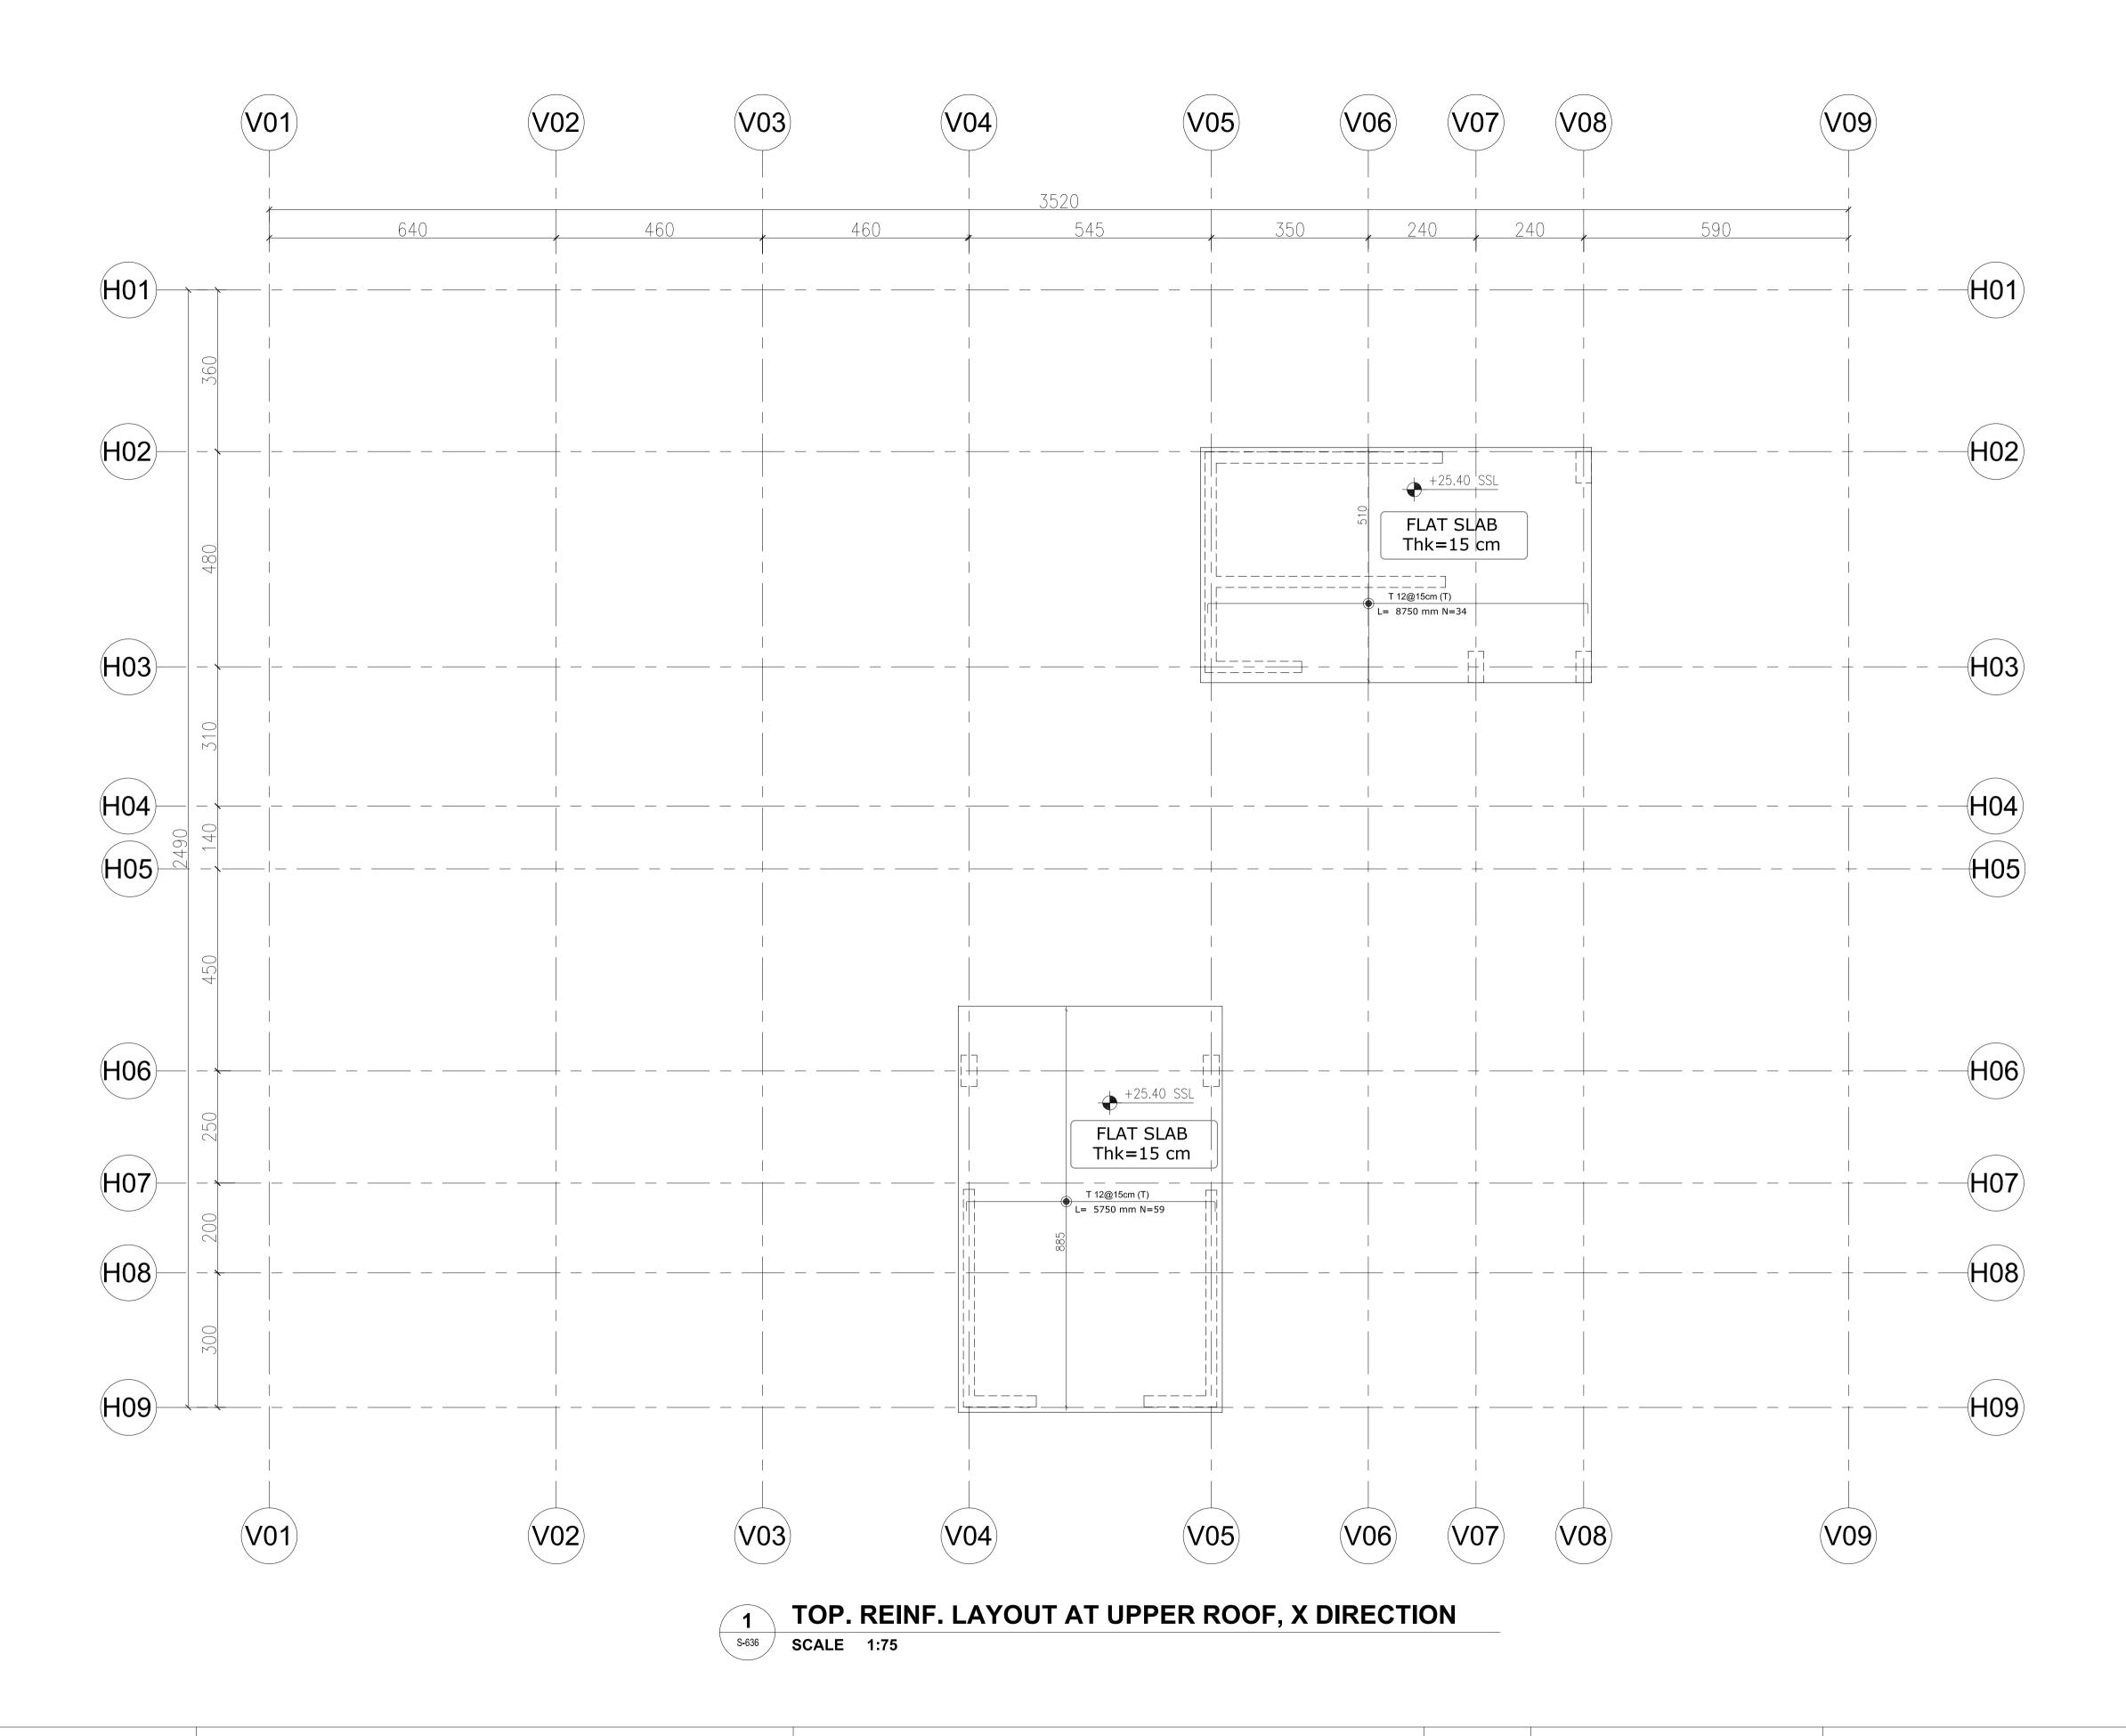

- all dimensions in (cm)
- all levels in meter (m)

YORKVILLE HOTEL & APARTMENTS LIMITED

PROJECT TITLE:

CLIENT: **DELOMIS**

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SCALE

DATE

17 JAN. 2022

DRAWING TITLE:

TOP. REINF. LAYOUT AT UPPER ROOF, X DIRECTION


CONSULTANT OFFICE

Java Design Concepts

LTD



SIZE: A1 DRAWING no:

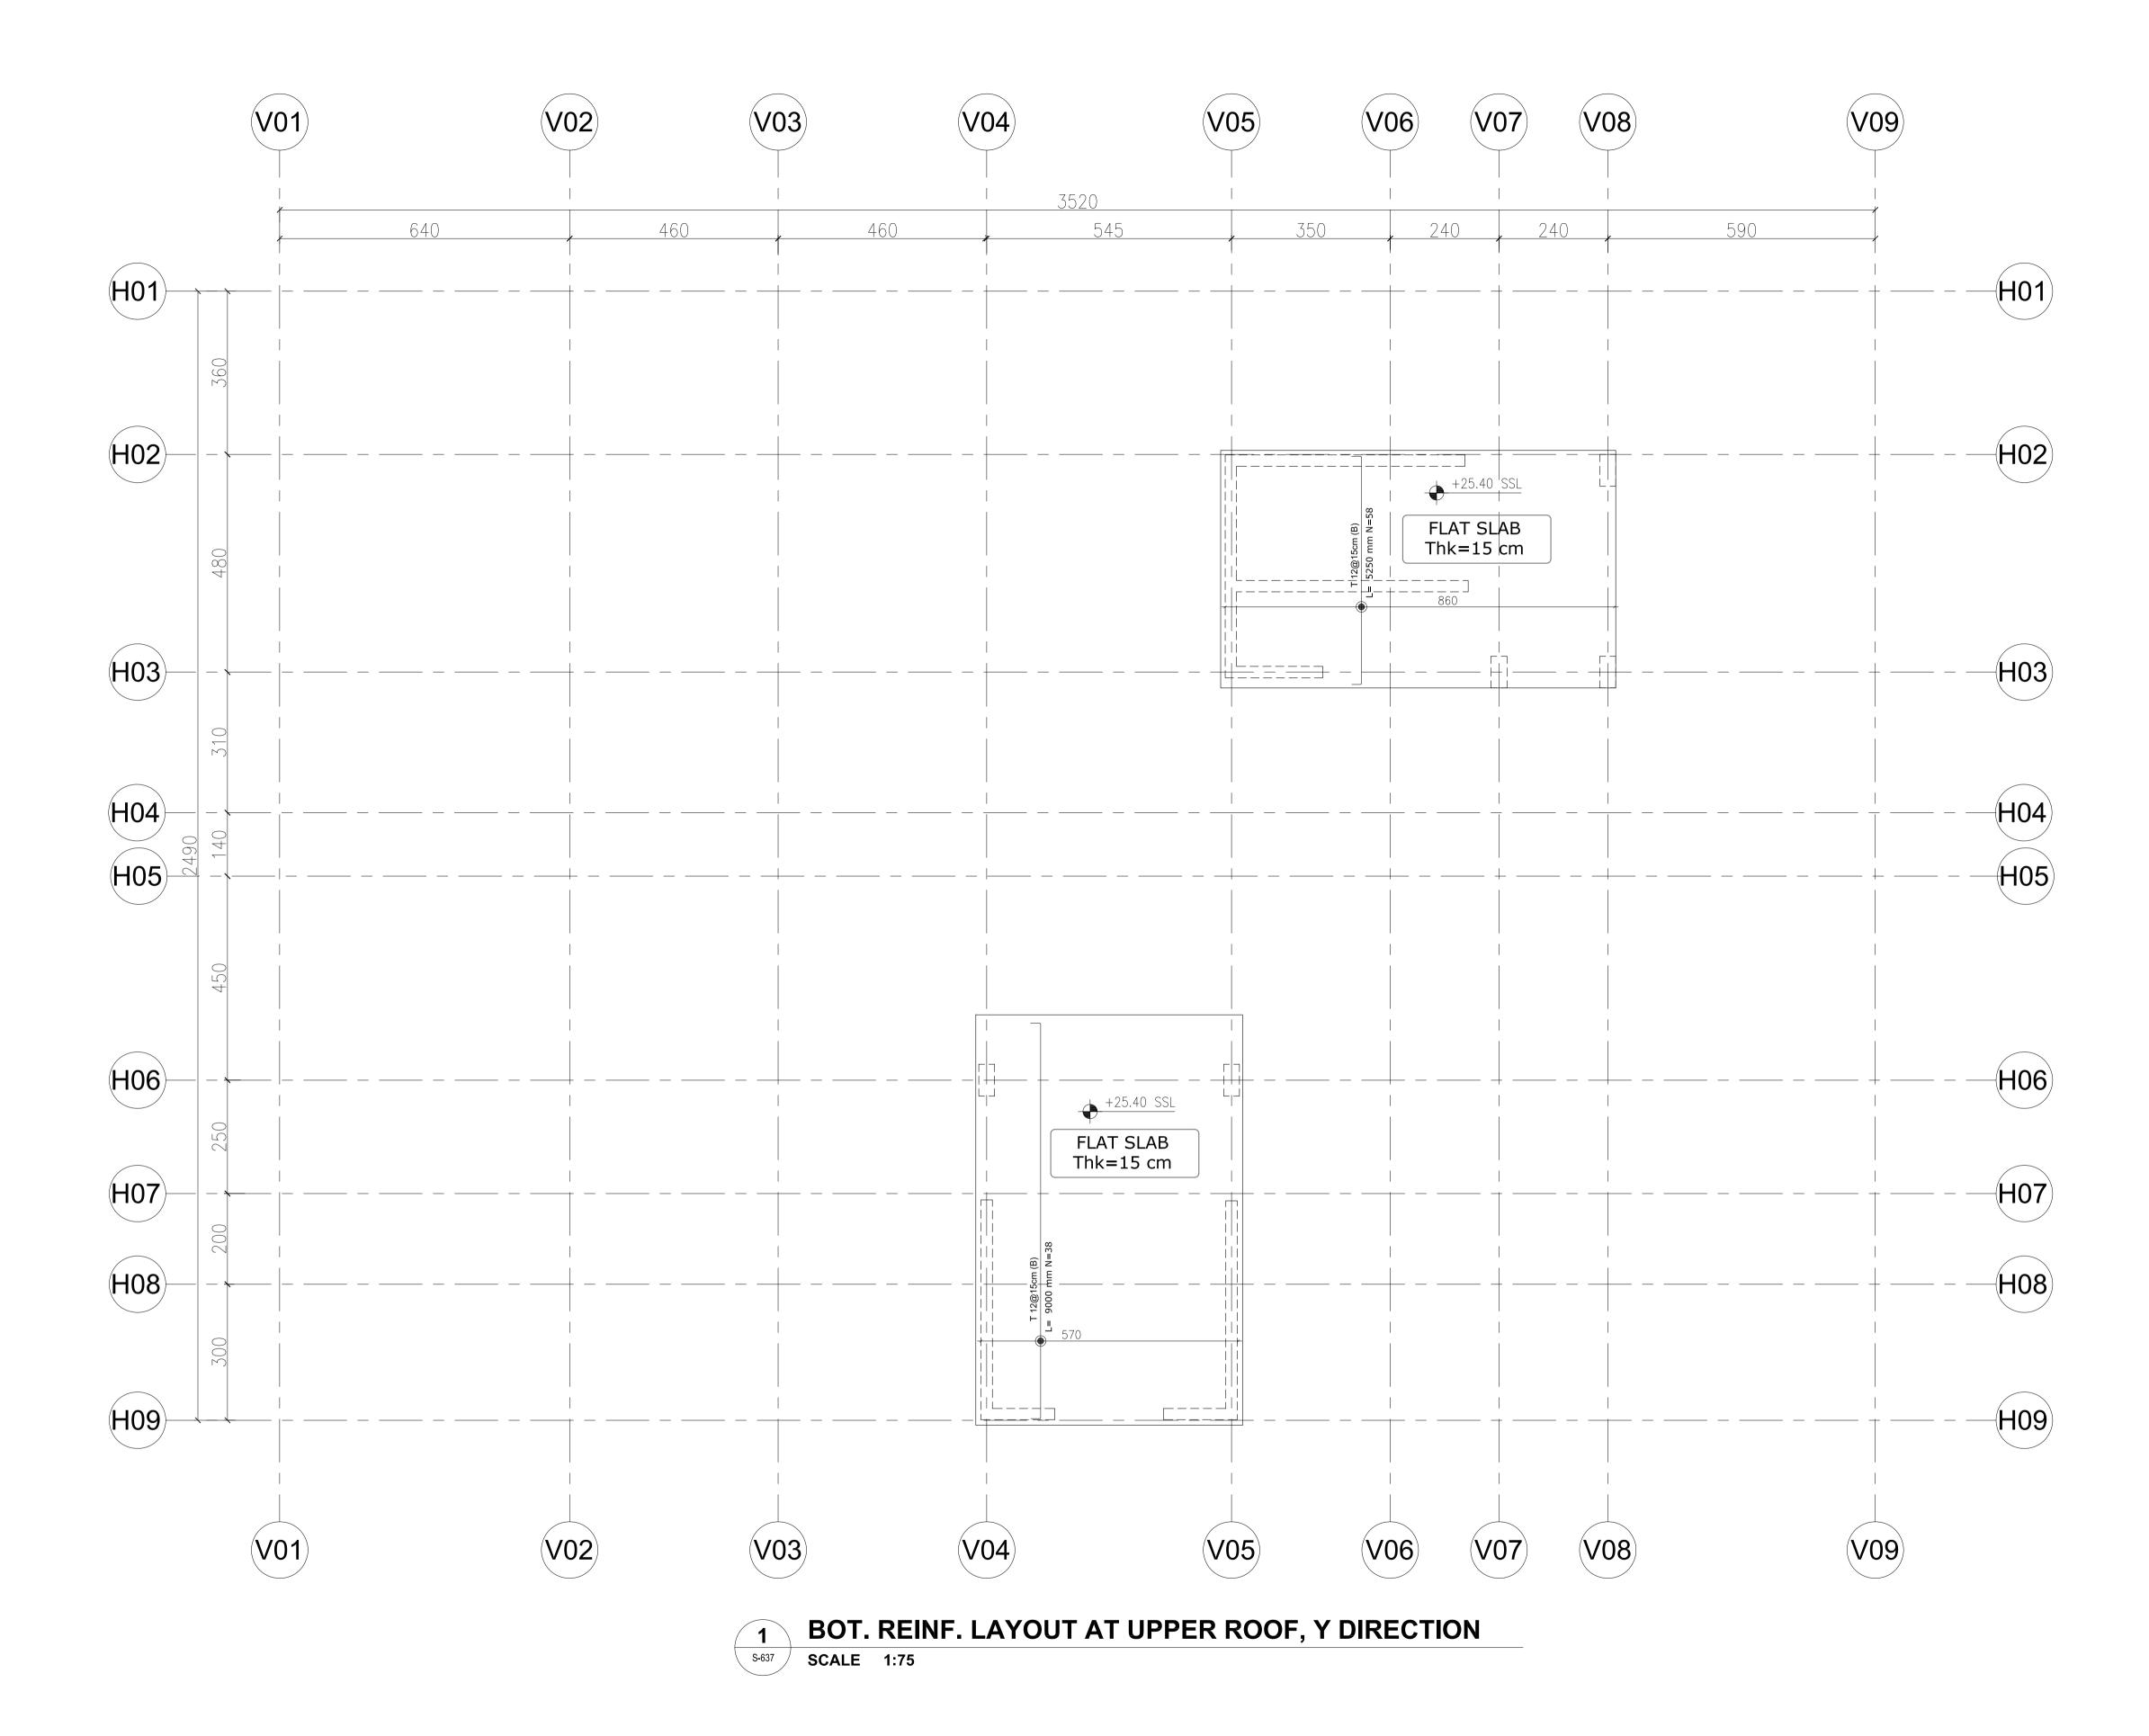

- all dimensions in (cm)

- all levels in meter (m)

PROJECT TITLE:

YORKVILLE HOTEL & **APARTMENTS LIMITED**

CLIENT: **DELOMIS** DESIGNED DRAWN CHECKED SCALE 17 JAN. 2022 DATE

DRAWING TITLE:


BOT. REINF. LAYOUT AT UPPER ROOF, Y DIRECTION

CONSULTANT OFFICE

Java Design Concepts LTD

S-637

SIZE: A1 DRAWING no:

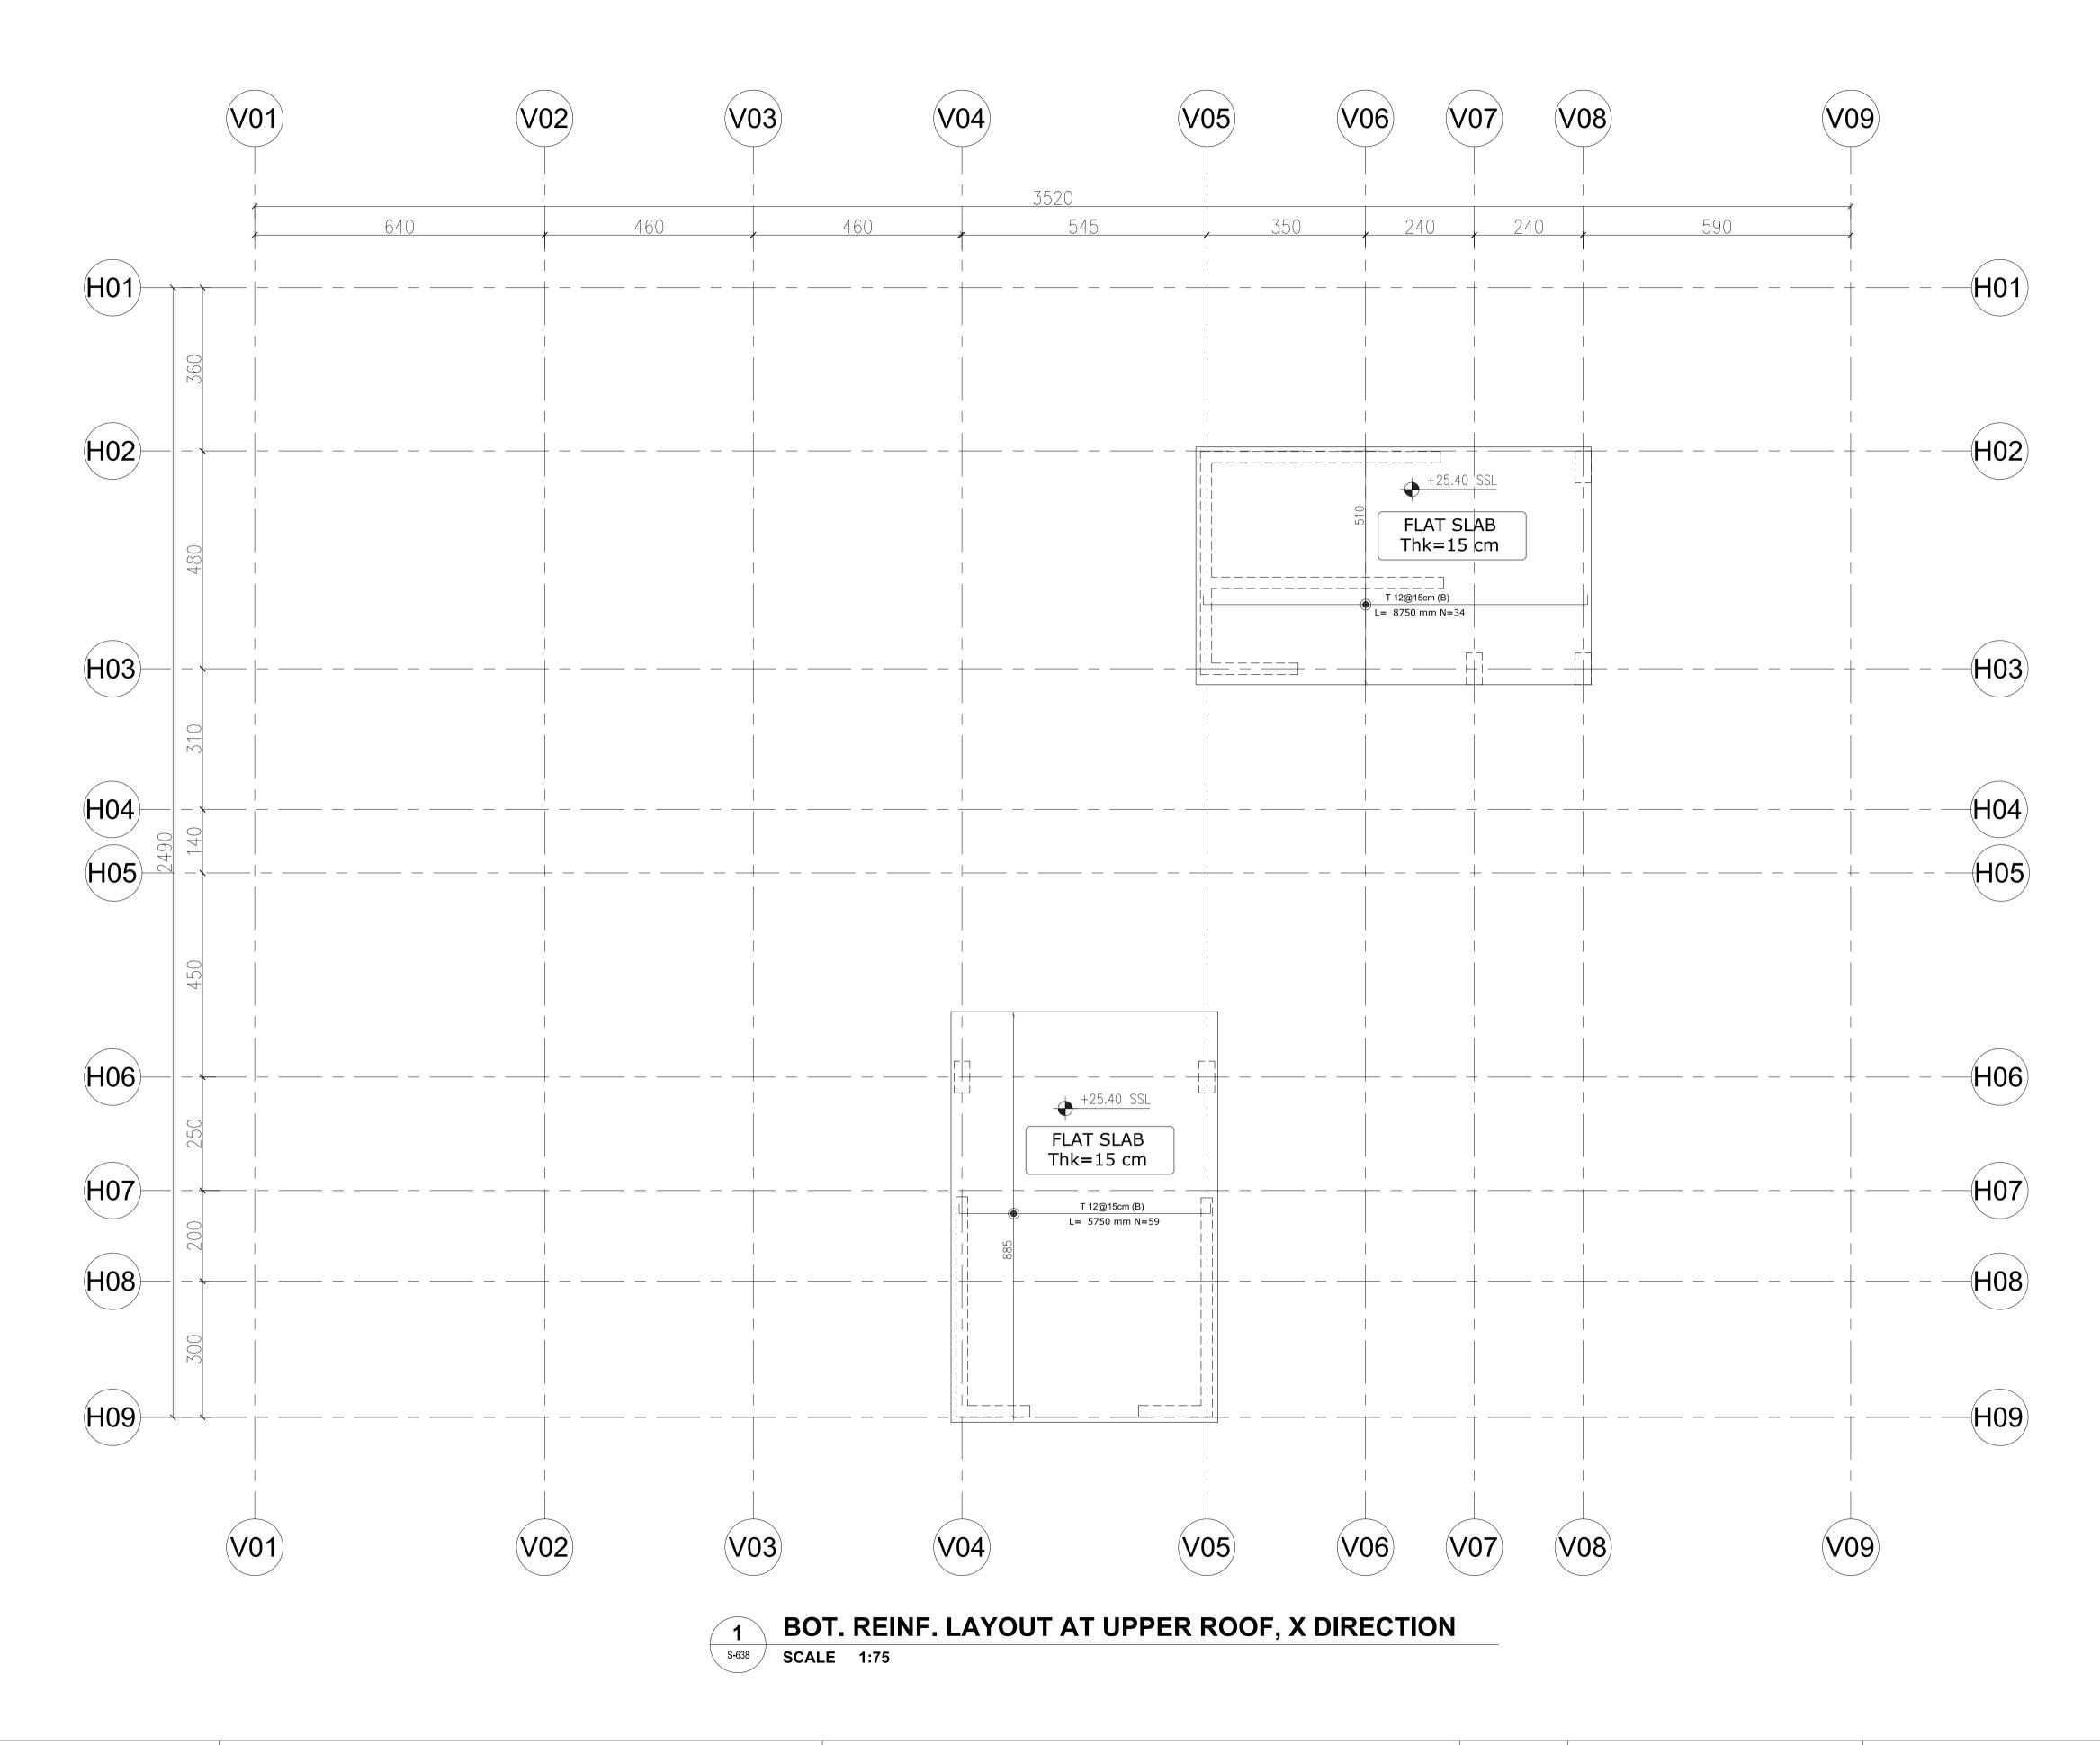

all dimensions in (cm)all levels in meter (m)

m)

YORKVILLE HOTEL & APARTMENTS LIMITED

PROJECT TITLE:

CLIENT: **DELOMIS**

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SCALE

DATE

17 JAN. 2022

DRAWING TITLE:


BOT. REINF. LAYOUT AT UPPER ROOF, X DIRECTION CONSULTANT OFFICE


Java Design Concepts

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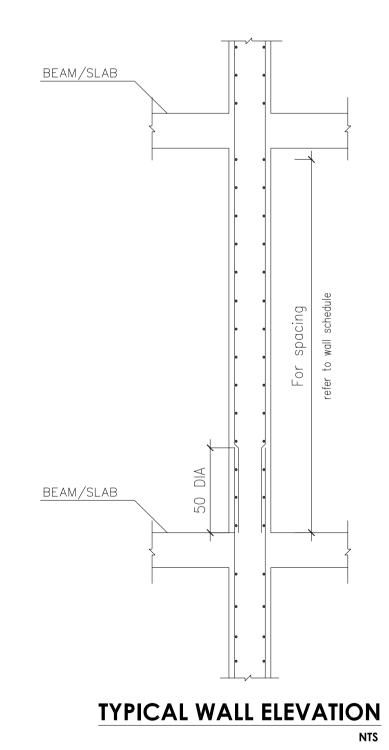


SIZE: A1 DRAWING no:



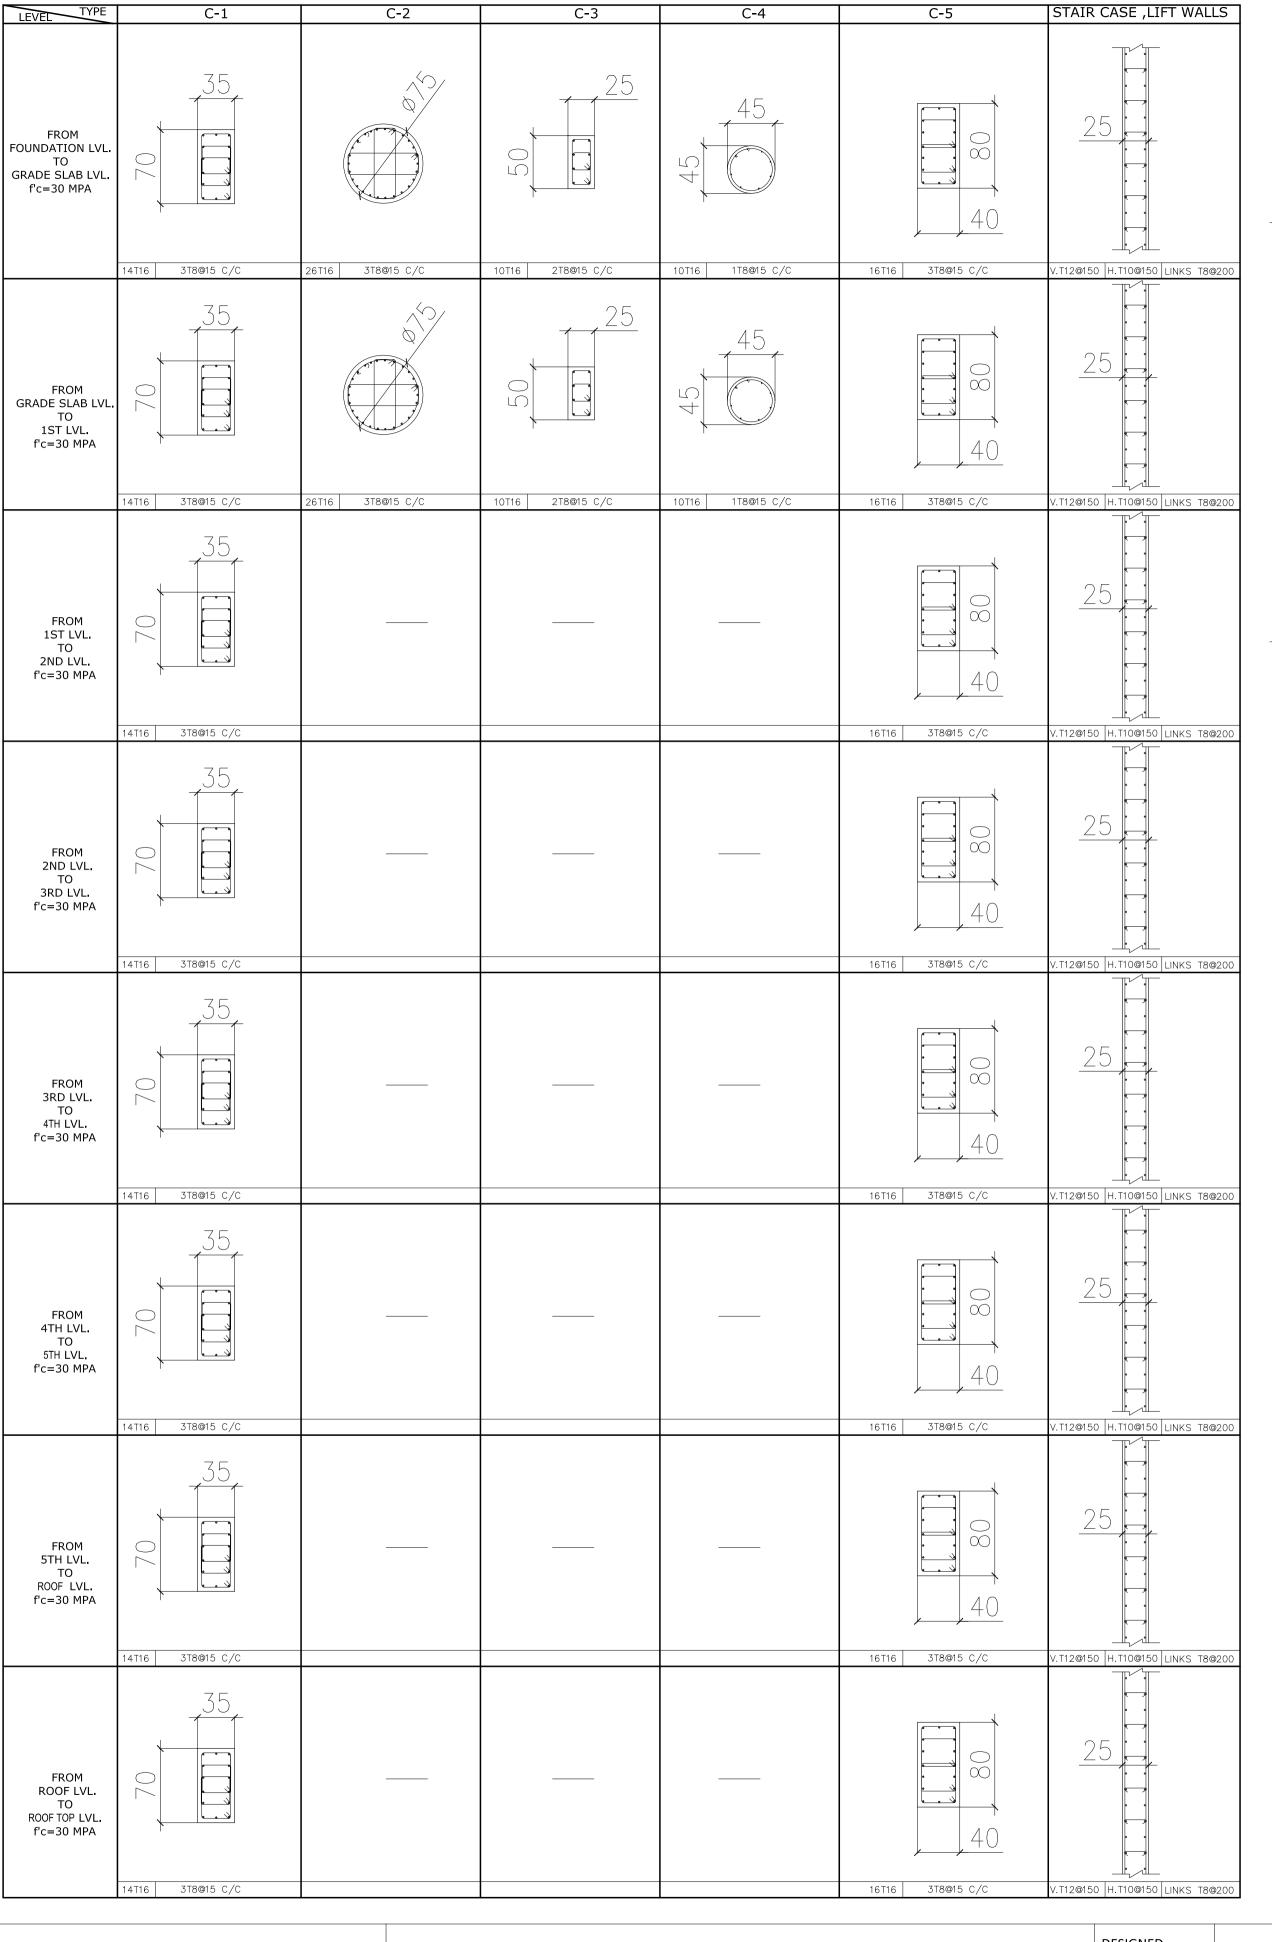

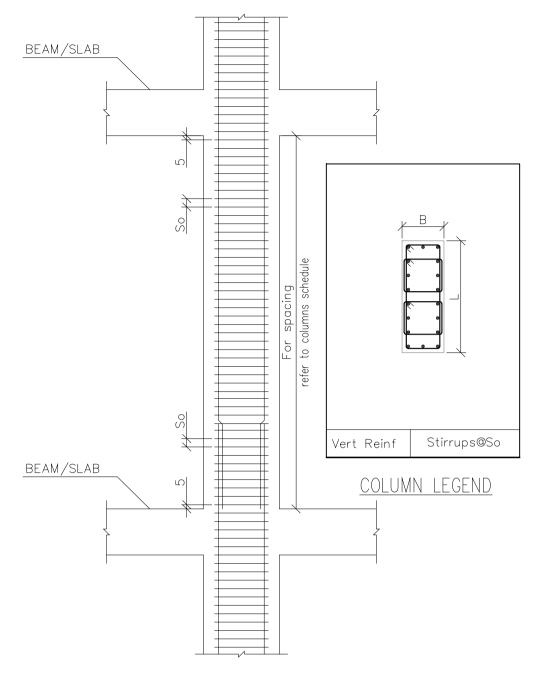TYPICAL COLUMN ELEVATION



Note:

- all dimensions in (cm)

- all levels in meter (m)

PROJECT TITLE:

YORKVILLE HOTEL & **APARTMENTS LIMITED**


COLUMNS SCHEDULE SC.1/30

CLIENT:

DESIGNED DRAWN **DELOMIS** CHECKED SCALE 17 JAN. 2022

DRAWING TITLE: COLUMNS AND WALL DETAILS


CONSULTANT OFFICE

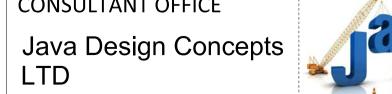

SIZE: A1

DRAWING no:



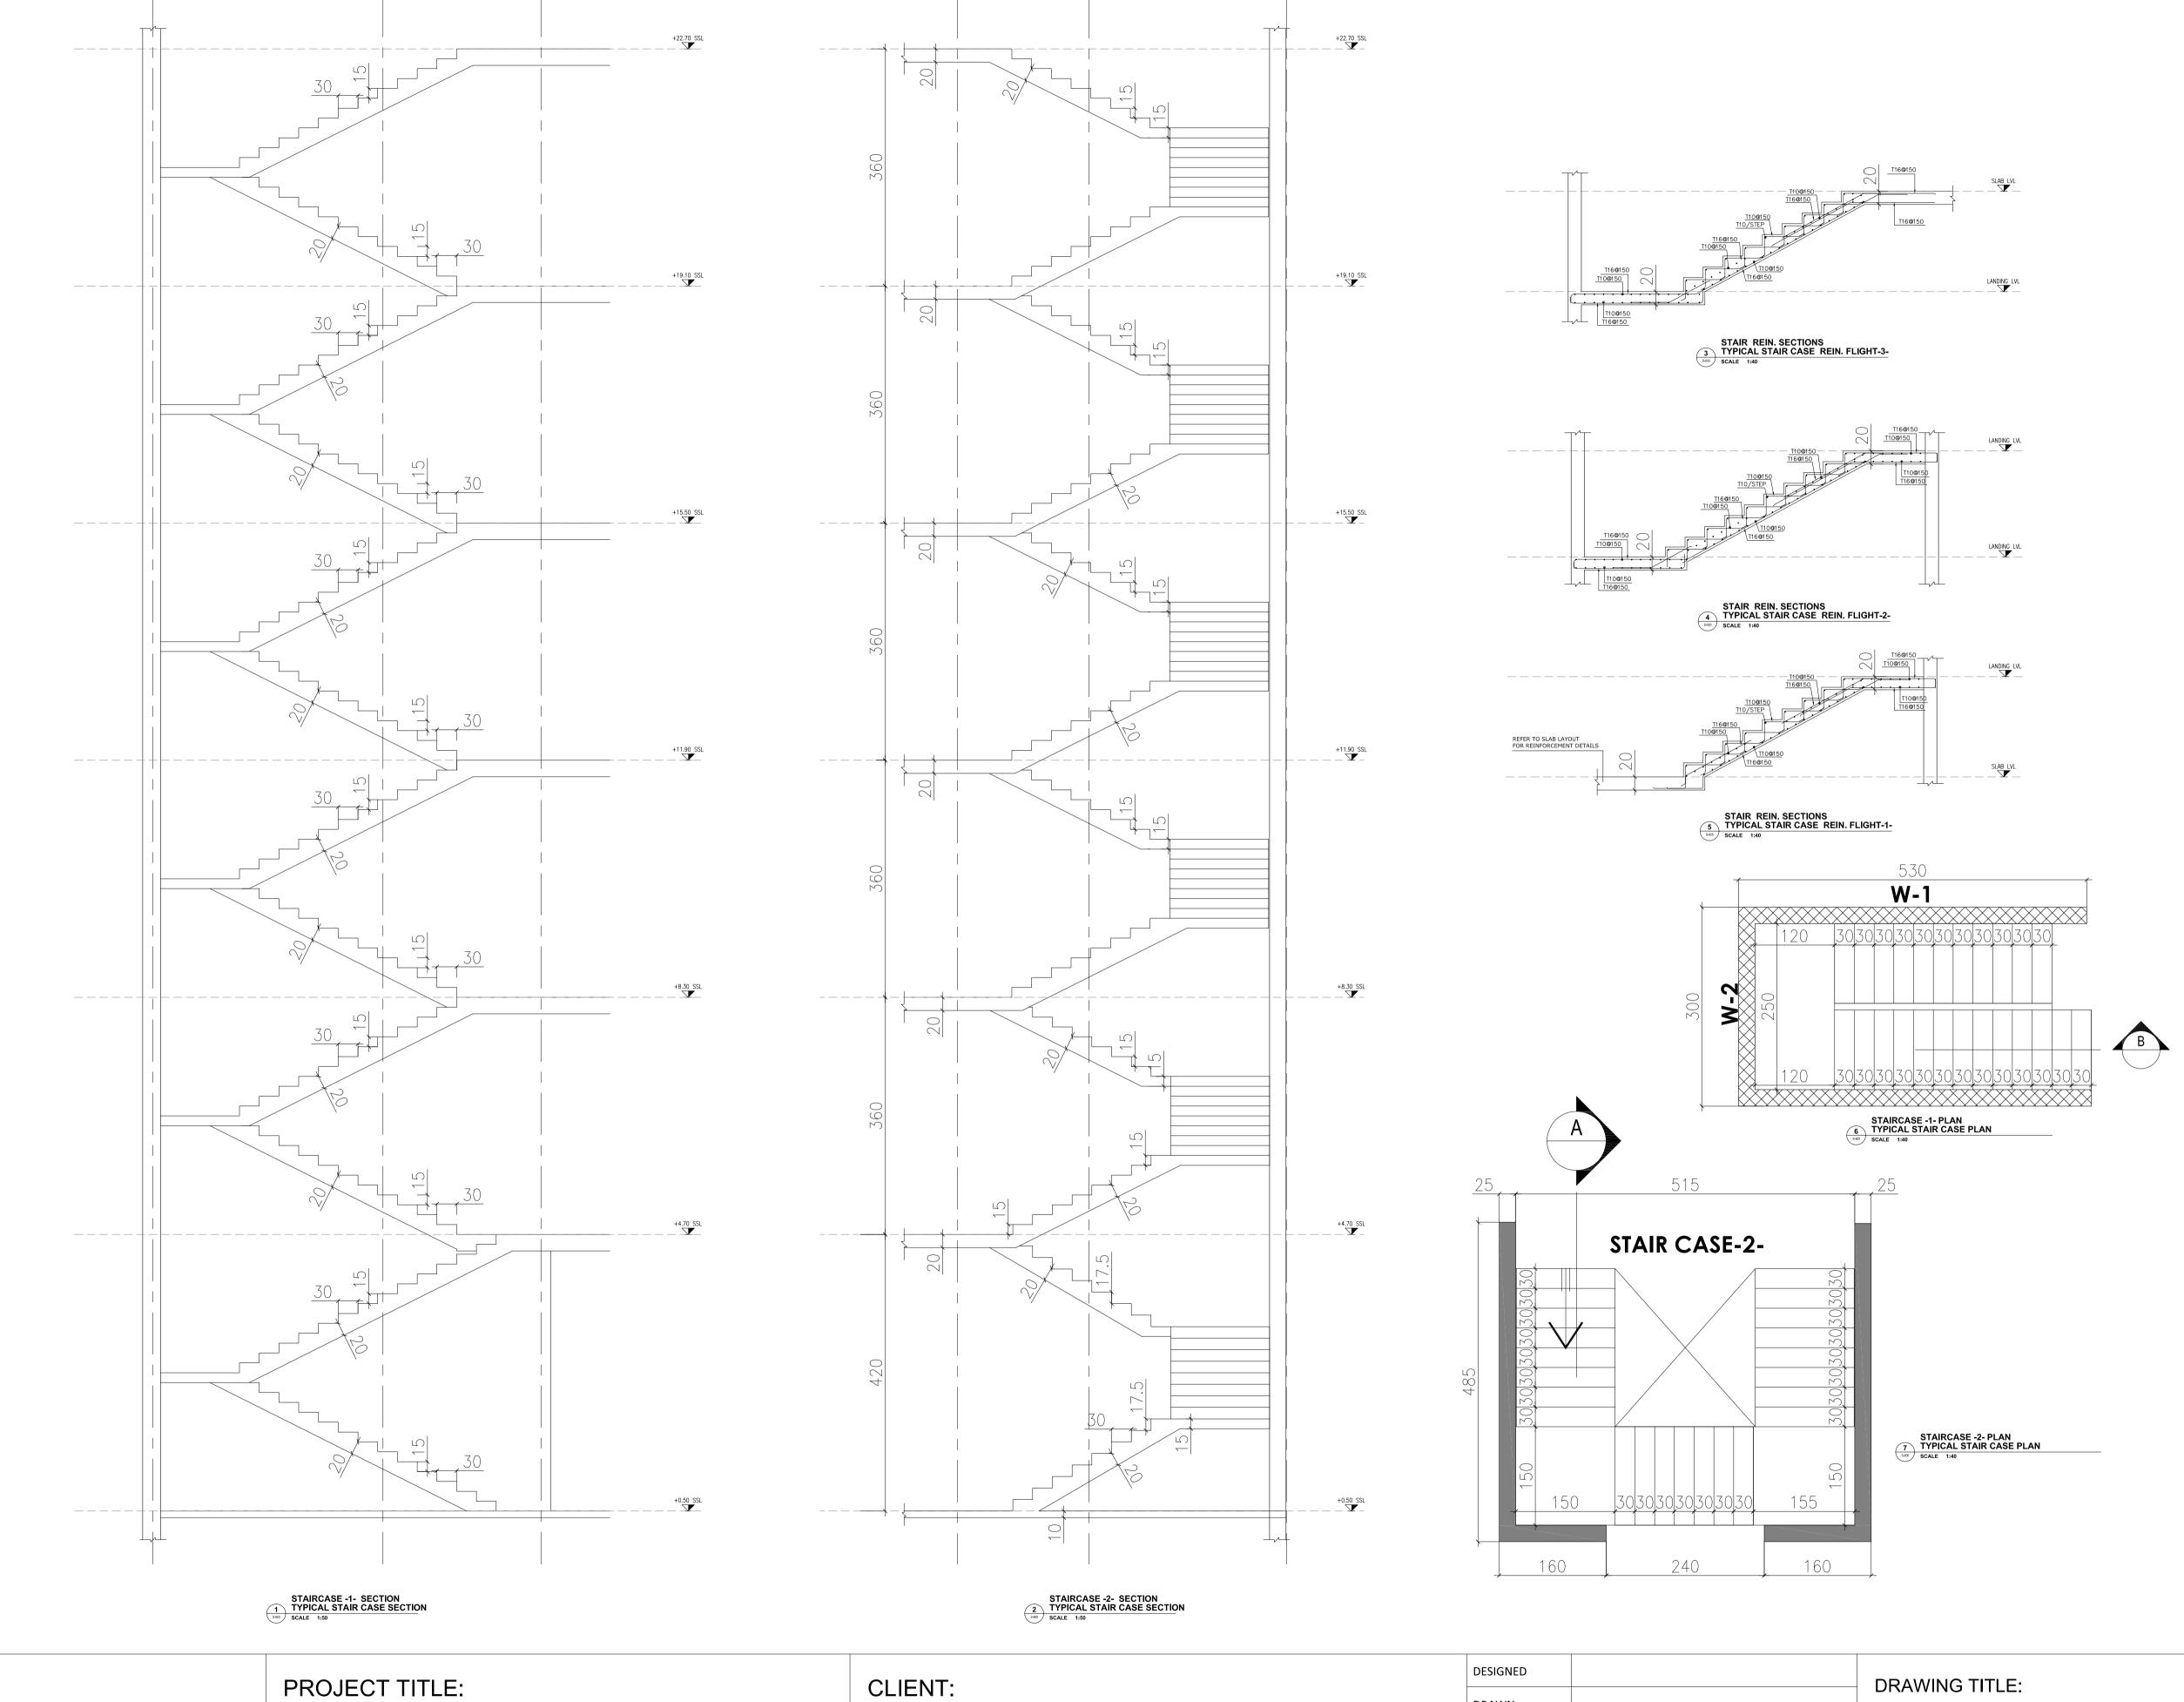

- all dimensions in (cm) - all levels in meter (m)

YORKVILLE HOTEL & **APARTMENTS LIMITED** CLIENT:

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CHECKED		
SCALE		
DATE	17 JAN. 2022	

DRAWING TITLE:

STAIRCASE DETAIL

CONSULTANT OFFICE Java Design Concepts LTD



SIZE: A1 DRAWING no: